

ethekwini water services WATER DESIGN BRANCH

Thandokuhle Reservoir:

The Construction of a 3Me reinforced concrete reservoir, 150mm ø steel inlet, 300mm ø steel outlet pipelines and ancillary works

> TENDER DRAWINGS October 2021





3 Prior Road, Durban Central Durban 4001




1ST FLOOR No.5 THE BOULEVARD WEST WAY OFFICE PARK WESTVILLE, DURBAN


IZI OF	DRAWINGS	
DWG No. (60356/)	DESCRIPTION	SHT
002	RESERVOIR SITE PLAN LAYOUT	1 of 1
003	TYPICAL EARTHWORK CROSS SECTIONS	1 of 1
004	RESERVOIR FLOOR PLAN	1 of 1
005	RESERVOIR SECTION & DETAILS	1 of 1
006	RESERVOIR ROOF PLAN & DETAILS	1 of 1
007	DN300 OUTLET CHAMBER AND SCOUR DETAILS	1 of 1
008	DN150 INLET CHAMBER AND DETAILS	1 of 1
009	STANDARD ASSOCIATED DETAILS	1 of 2
009	STANDARD ASSOCIATED DETAILS	2 of 2
010	INLESECTIONST AND OUTLET PIPELINE PLAN AND LONG	1 of 1
011	DN200 IN-LINE INLET METER	1 of 1
012	DN100 IN-LINE OUTLET METER	1 of 1
013	TYPICAL SCOUR VALVE CHAMBER	1 of 1
014	TYPICAL SCOUR VALVE CHAMBER	1 of 1
015	DN150 CROSS CONNECTION CHAMBER	1 of 1
016	STORMWATER PLAN AND LONGSECTIONS	1 of 1
017	ROAD PLAN AND SECTIONS	1 of 1
018	ACCESS ROAD LONG SECTION AND CROSS SECTION	1 of 1
019	TELEMETRY ROOM	1 of 1
	STANDARD DETAILS	
45001	THRUST BLOCK	1 of 1
45002	TYPICAL TRENCH DETAILS	1 of 1
45005	GRP ACCESS LADDER: PLAN, SECTION & DETAILS	1 of 2
45005	GRP ACCESS LADDER: PLAN, SECTION & DETAILS	2 of 2
68184	WIRE MESH SECURITY FENCE AND GATE	1 of 1
68308	1200mm SQ MANHOLE COVER AND FRAME	1 of 1
45483	50-150 DIRT BOX REV 4	1 of 1
45484	200-400 DIRT BOX REV 5	1 of 1

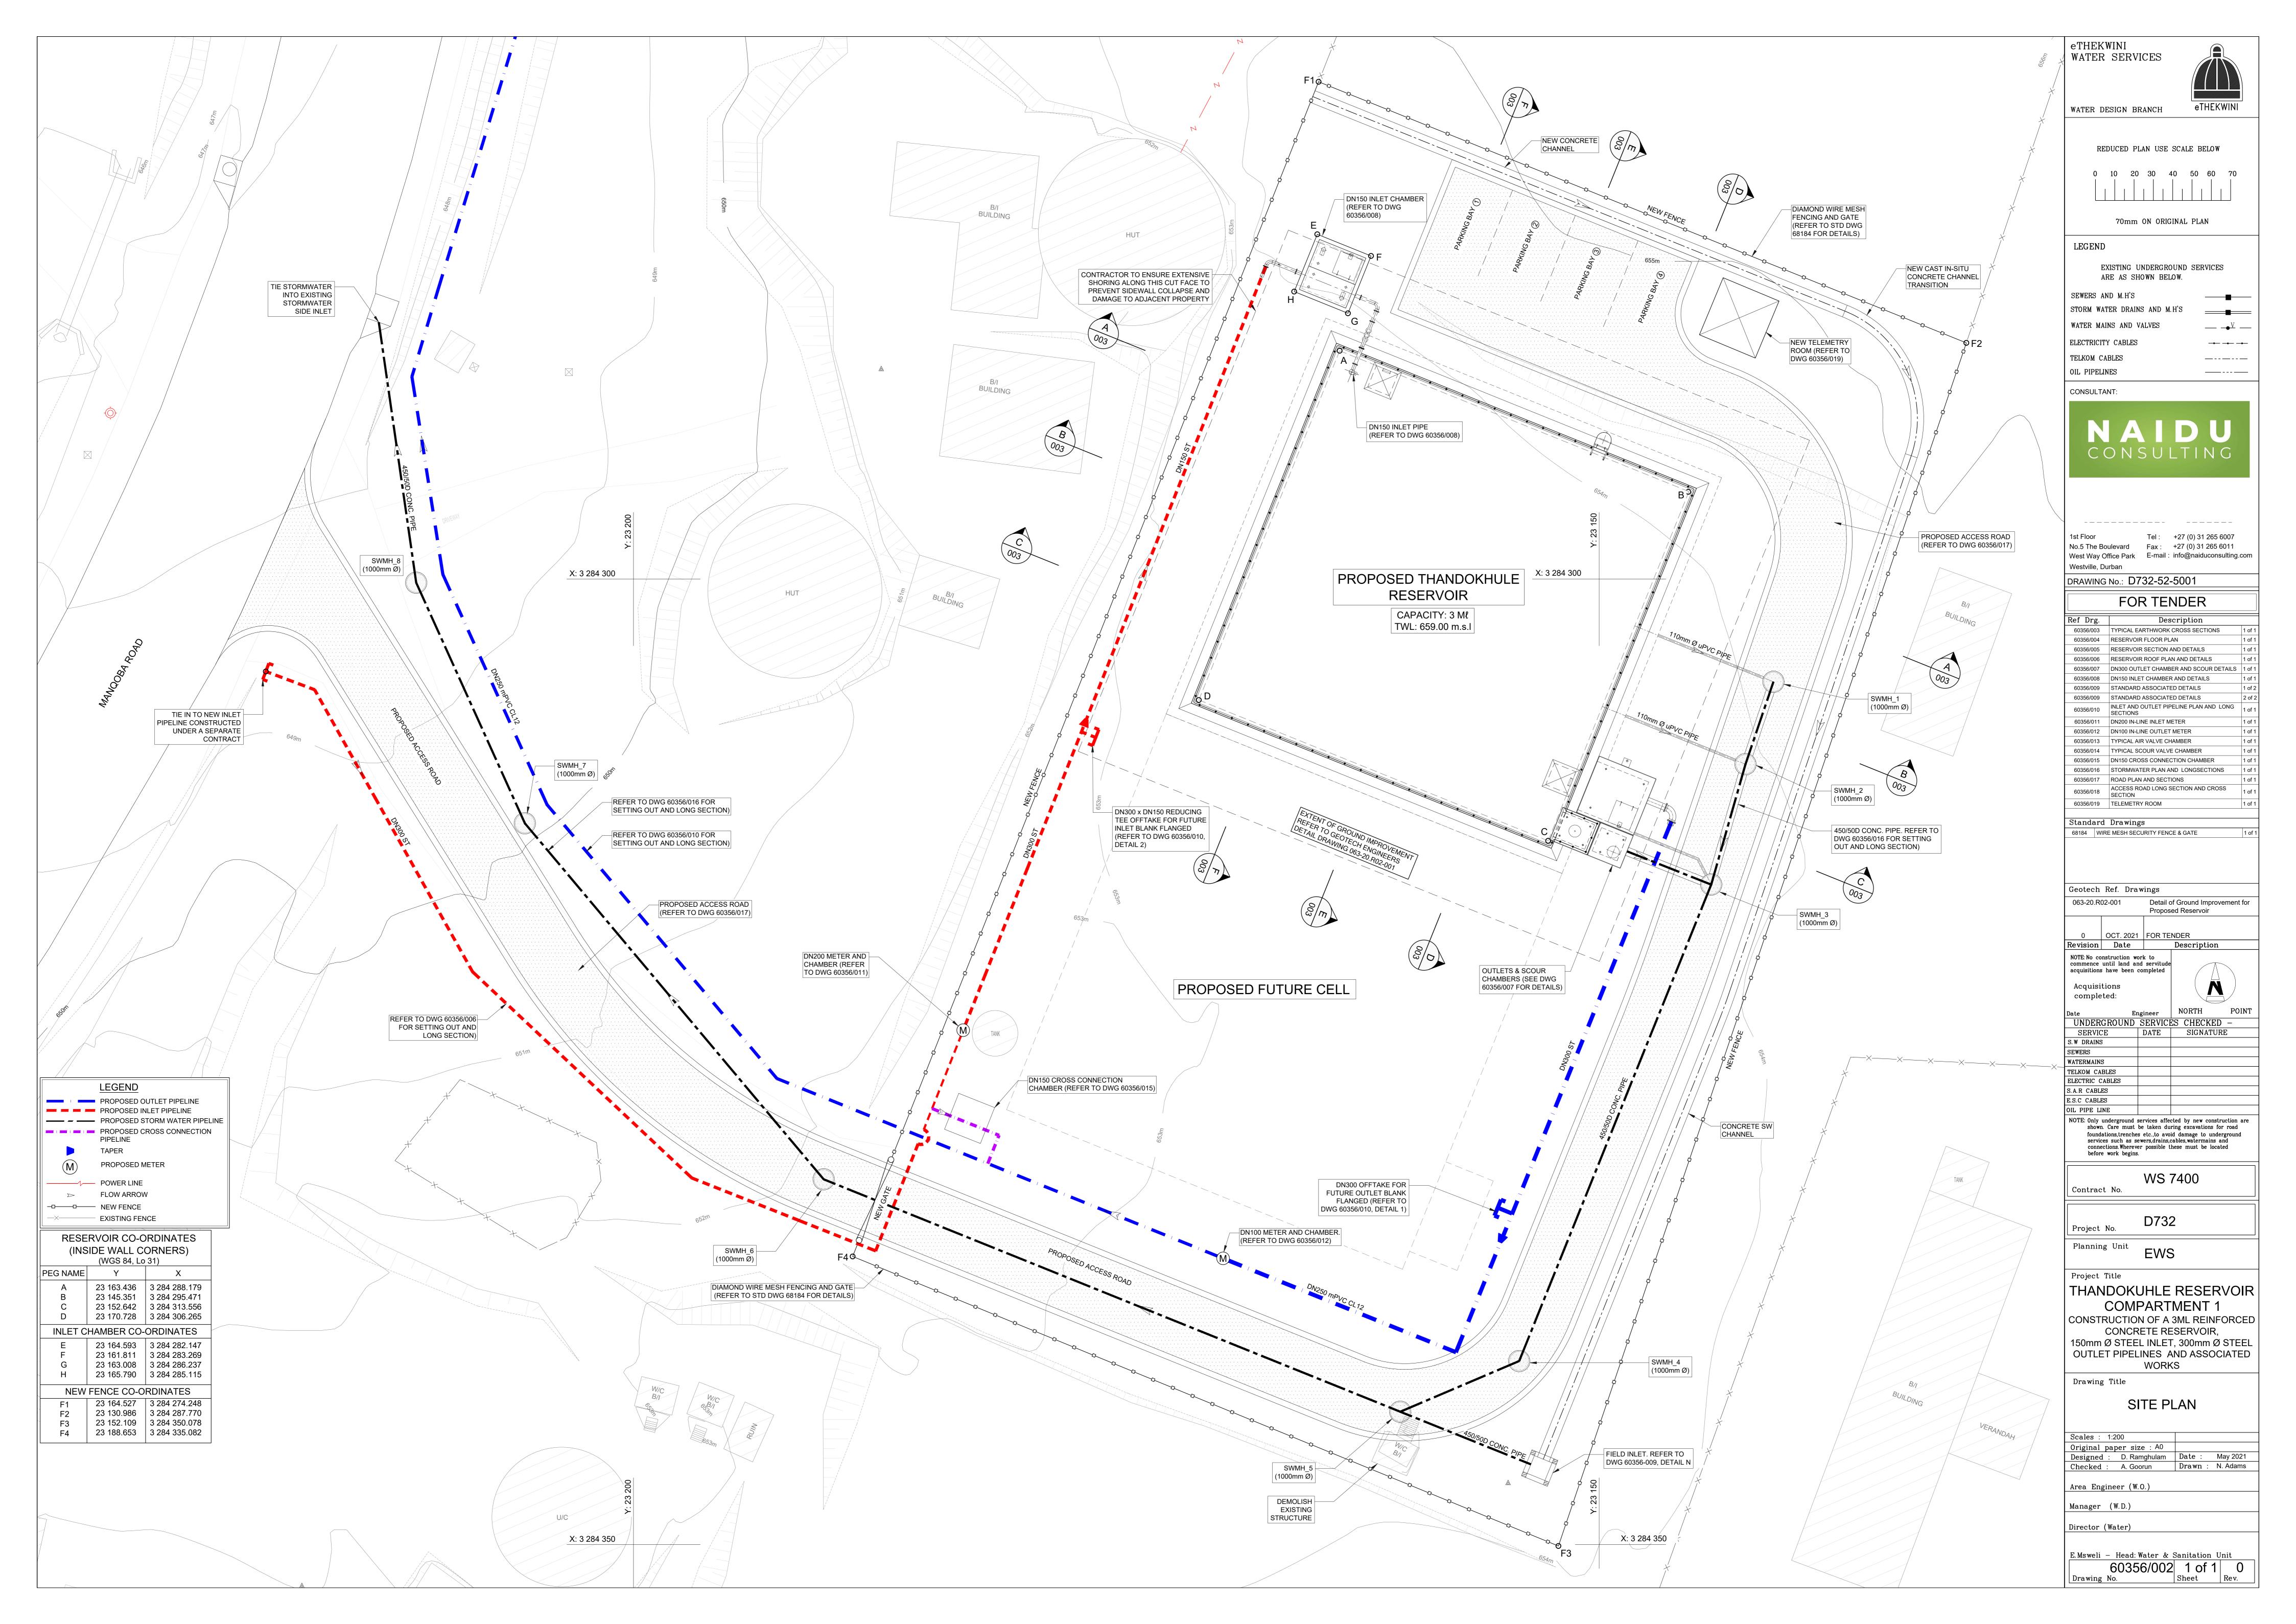

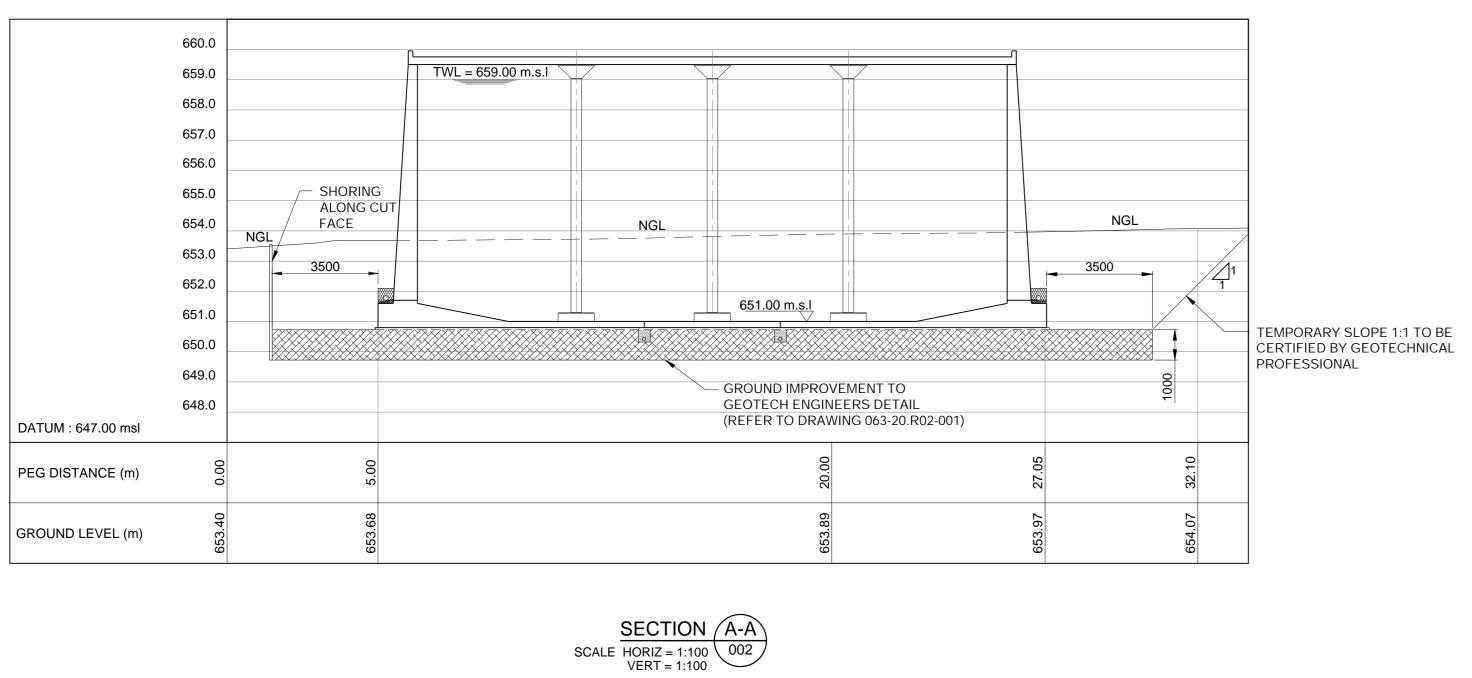

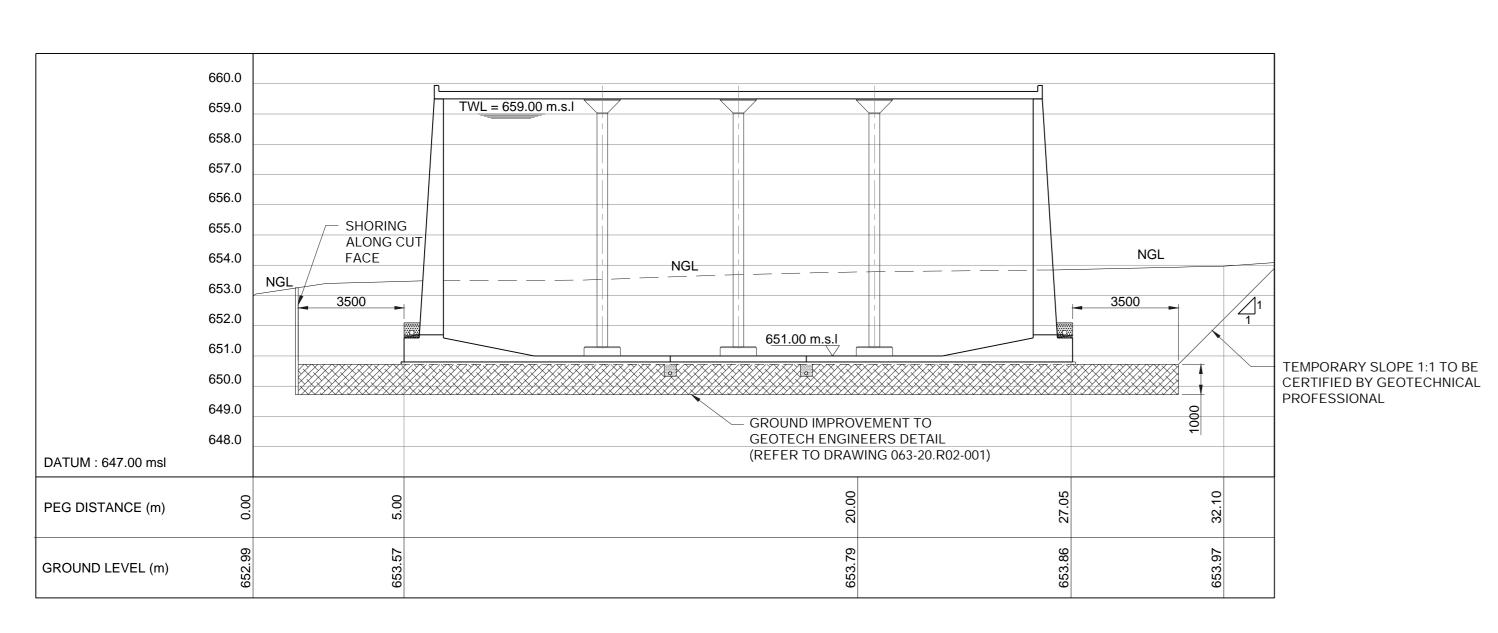

SCALE HORIZ = 1:100 002

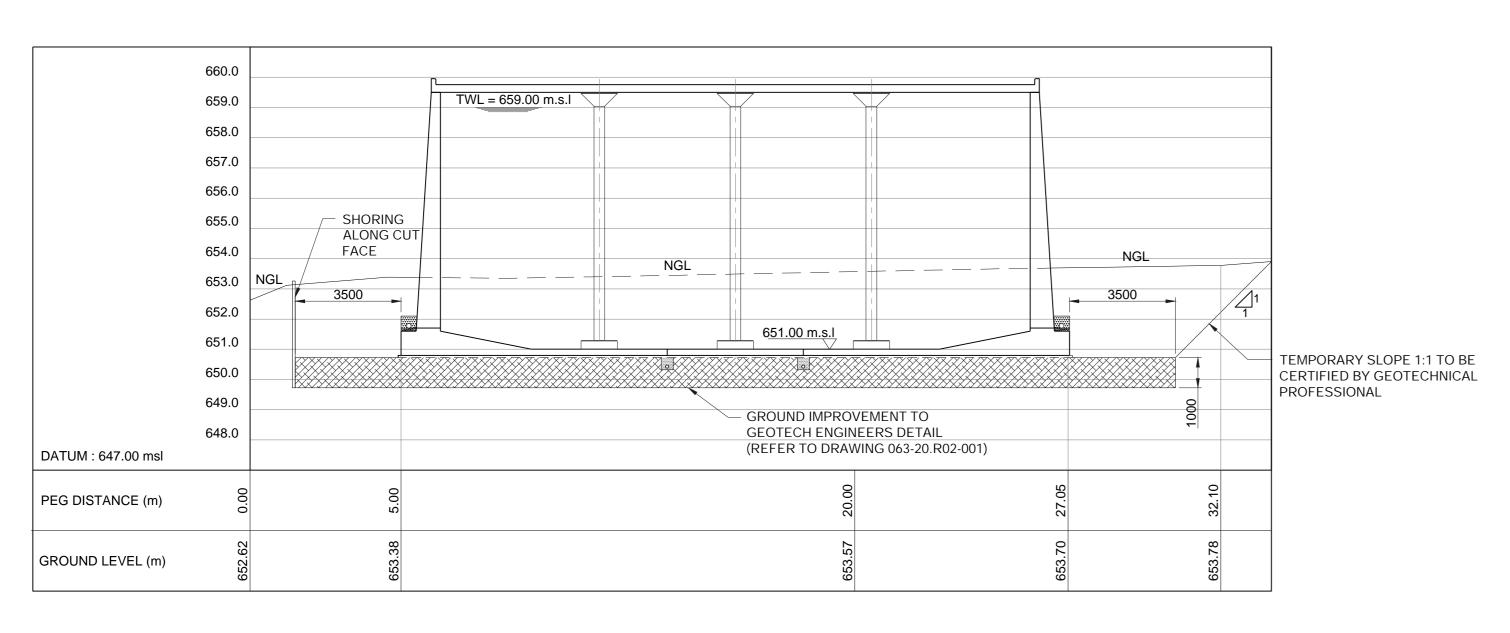

SCALE HORIZ = 1:100 002


DATUM : 647.00 msl PEG DISTANCE (m)

PEG DISTANCE (m)


GROUND LEVEL (m)

GROUND LEVEL (m)


PEG DISTANCE (m)

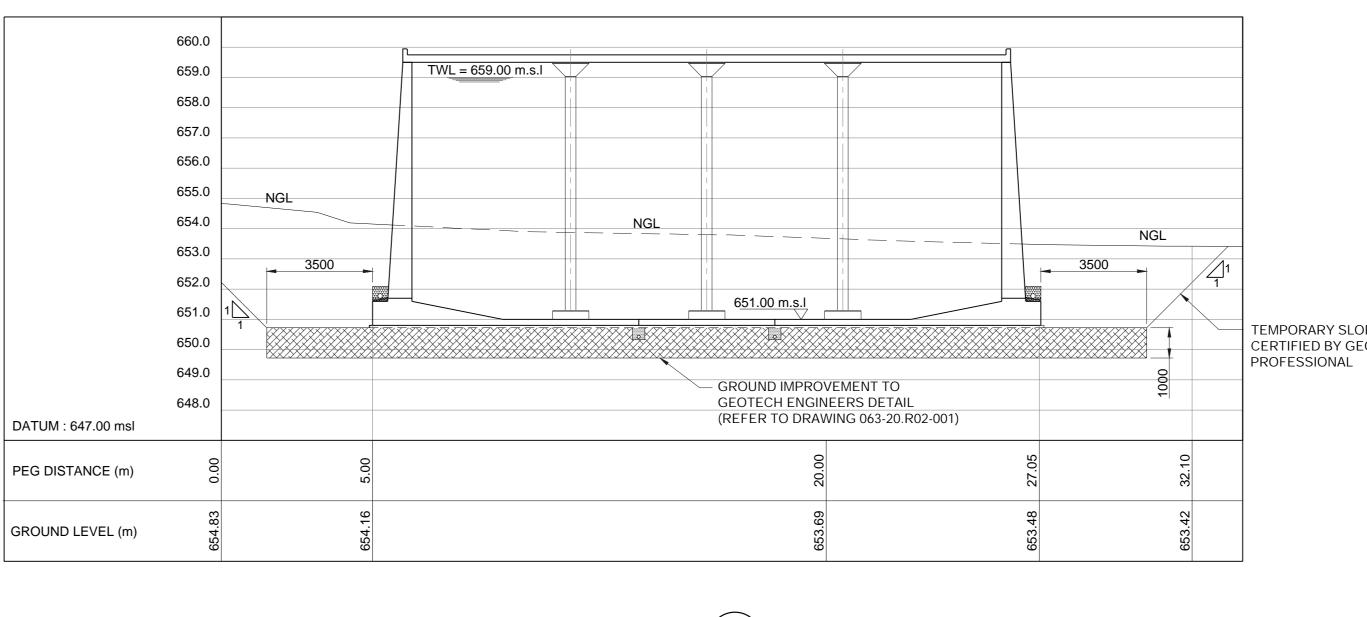



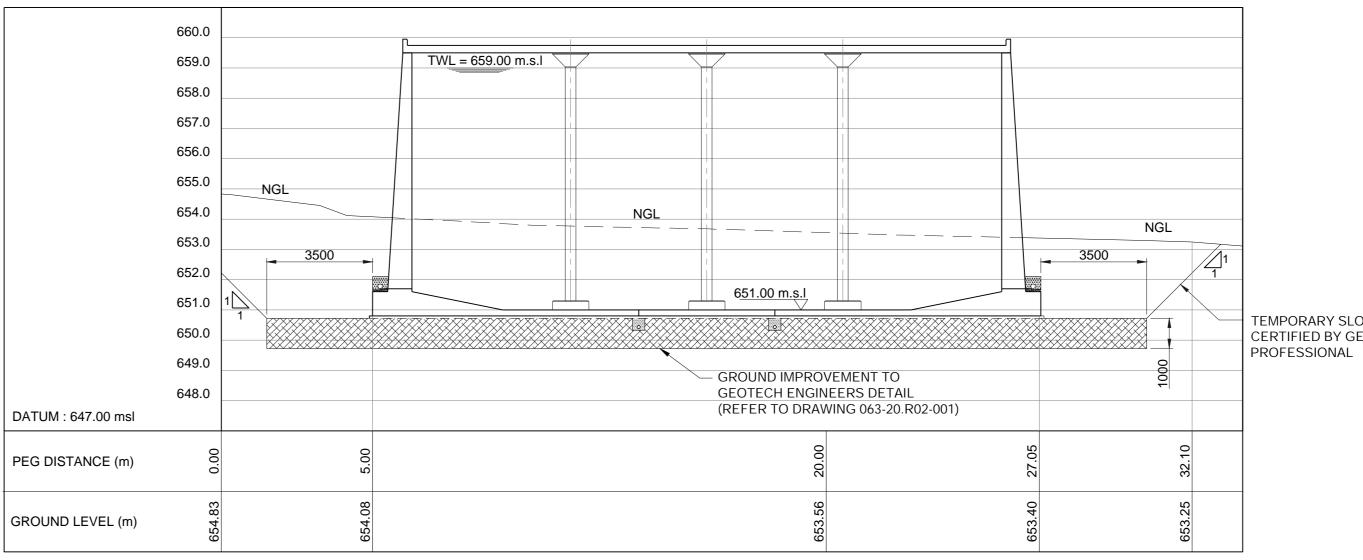

SCALE HORIZ = 1:100 VERT = 1:100

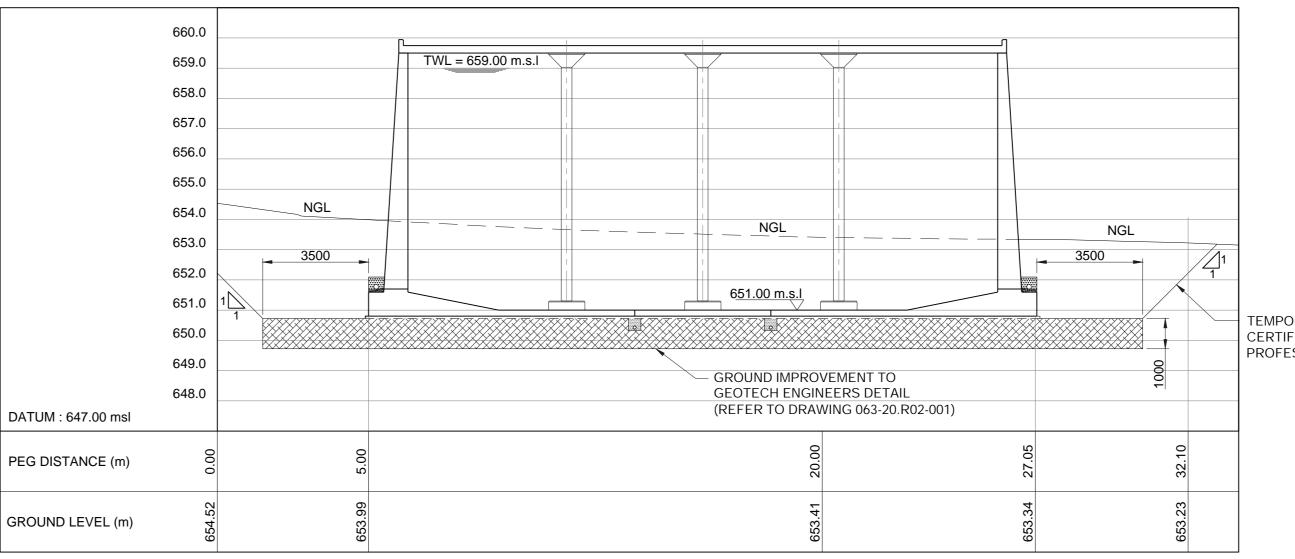


SCALE SECTION F-F HORIZ = 1:100 VERT = 1:100


TEMPORARY SLOPE 1:1 TO BE CERTIFIED BY GEOTECHNICAL

TEMPORARY SLOPE 1:1 TO BE CERTIFIED BY GEOTECHNICAL

TEMPORARY SLOPE 1:1 TO BE CERTIFIED BY GEOTECHNICAL PROFESSIONAL

eTHEKWINI WATER SERVICES
WATER DESIGN BRANCH eTHEKWINI
REDUCED PLAN USE SCALE BELOW
0 10 20 30 40 50 60 70
CONSULTANT:
NAIDU CONSULTING
1st Floor Tel : +27 (0) 31 265 6007 No.5 The Boulevard Fax : +27 (0) 31 265 6011 West Way Office Park E-mail : info@naiduconsulting.com Westville, Durban DRAWING No.: D732-53-5100
FOR TENDER
Ref Drg.Description60356/002RESERVOIR SITE PLAN LAYOUT1 of 160356/004RESERVOIR FLOOR PLAN1 of 1
60356/005 RESERVOIR SECTION AND DETAILS 1 of 1
Standard Drawings
Reinforcing Ref. Drawings
Geotech Ref. Drawings 063-20.R02-001 Detail of Ground Improvement for Proposed Reservoir Image: Construction of the second sec
0 OCT 2021 FOR TENDER PURPOSES ONLY Revision Date Description
NOTE: No construction work to commence until land and servitude acquisitions have been completed
Acquisitions completed:
DateEngineerNORTHPOINTUNDERGROUNDSERVICESCHECKED-SERVICEDATESIGNATURE
S. W DRAINS SEWERS WATERMAINS
TELKOM CABLES ELECTRIC CABLES S.A.R CABLES
E.S.C CABLES OIL PIPE LINE OIL PIPE LINE Image: Construction are shown. Care must be taken during excavations for road foundations, trenches etc., to avoid damage to underground services such as sewers, drains, cables, watermains and connections. Wherever possible these must be located before work begins.
WS 7400 Contract No.
Project No. D732
EWS Project Title THANDOKUHLE RESERVOIR COMPARTMENT 1
CONSTRUCTION OF A 3ML REINFORCED CONCRETE RESERVOIR, 150mm Ø STEEL INLET, 300mm Ø STEEL OUTLET PIPELINES AND ASSOCIATED WORKS
Drawing Title
TYPICAL EARTHWORKS CROSS SECTIONS
Scales : As Shown Original paper size : A0 Designed : D Ramphulam Date : May 2021
Designed :D. RamghulamDate :May 2021Checked :A. GoorunDrawn :N. Adams
Area Engineer (W.O.) Manager (W.D.)
Director (Water)
E.Msweli - Head: Water & Sanitation Unit 60356/003 1 of 1 1 Drawing No. Sheet Rev.

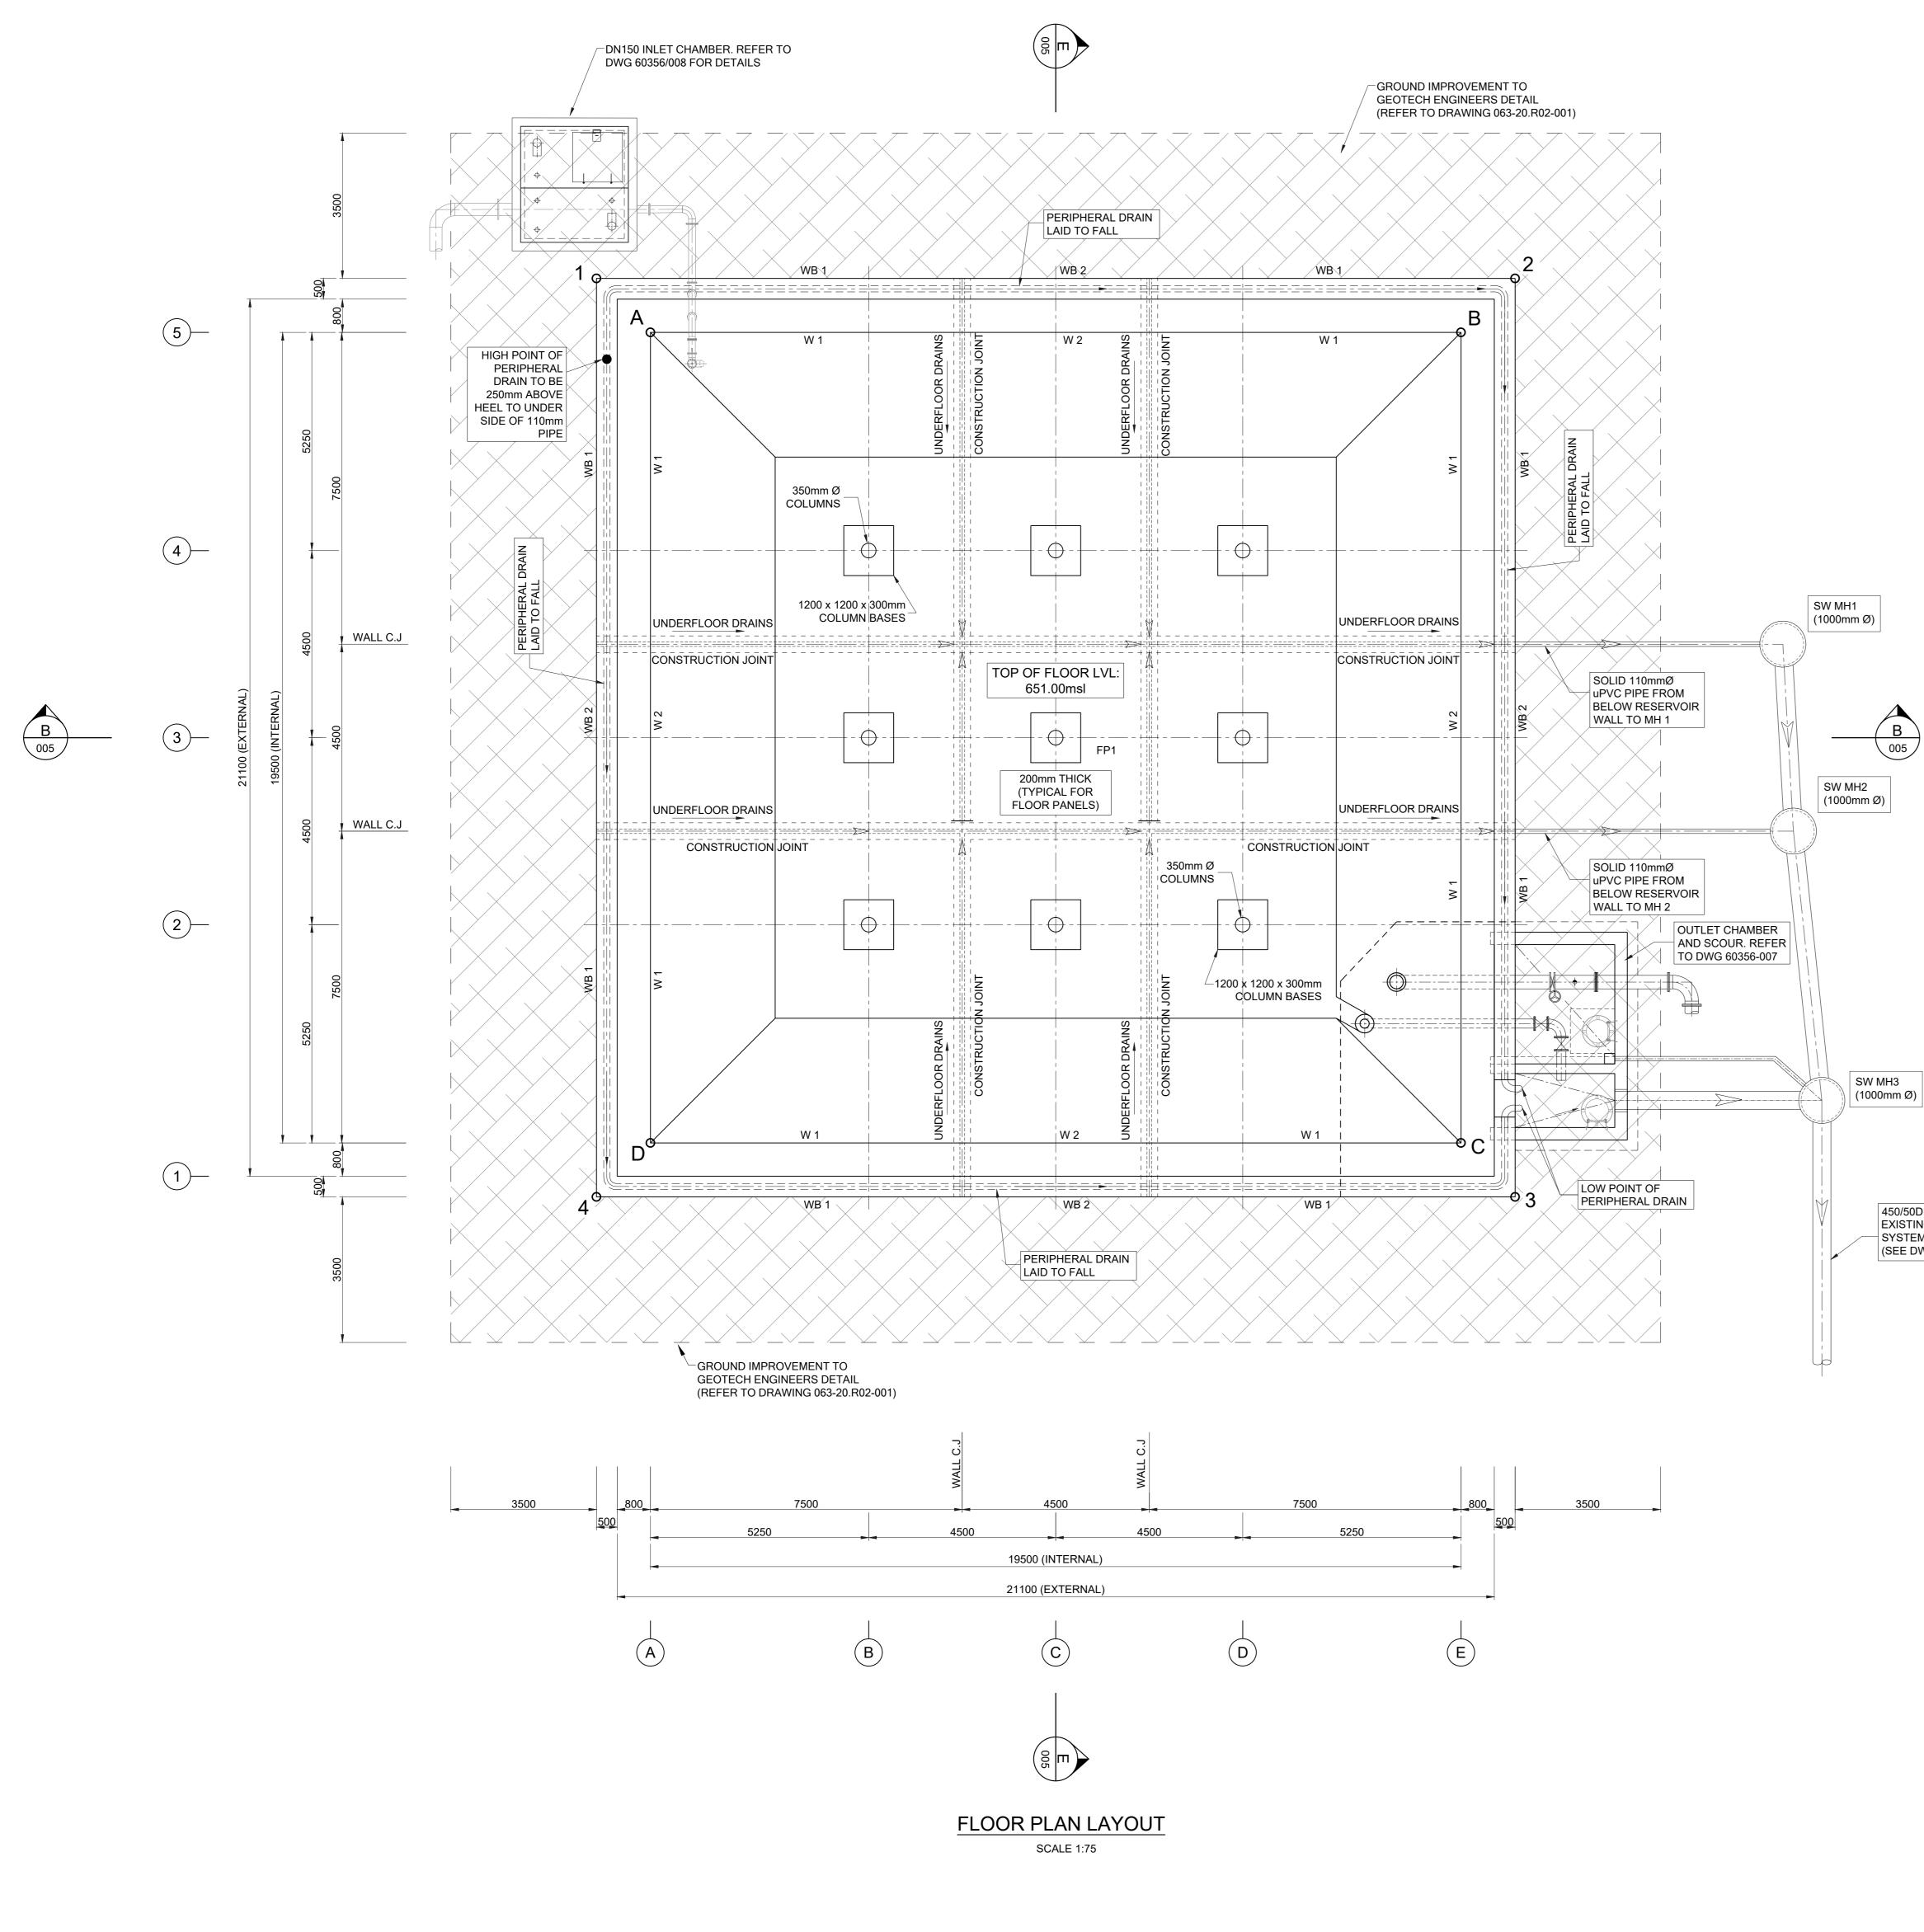

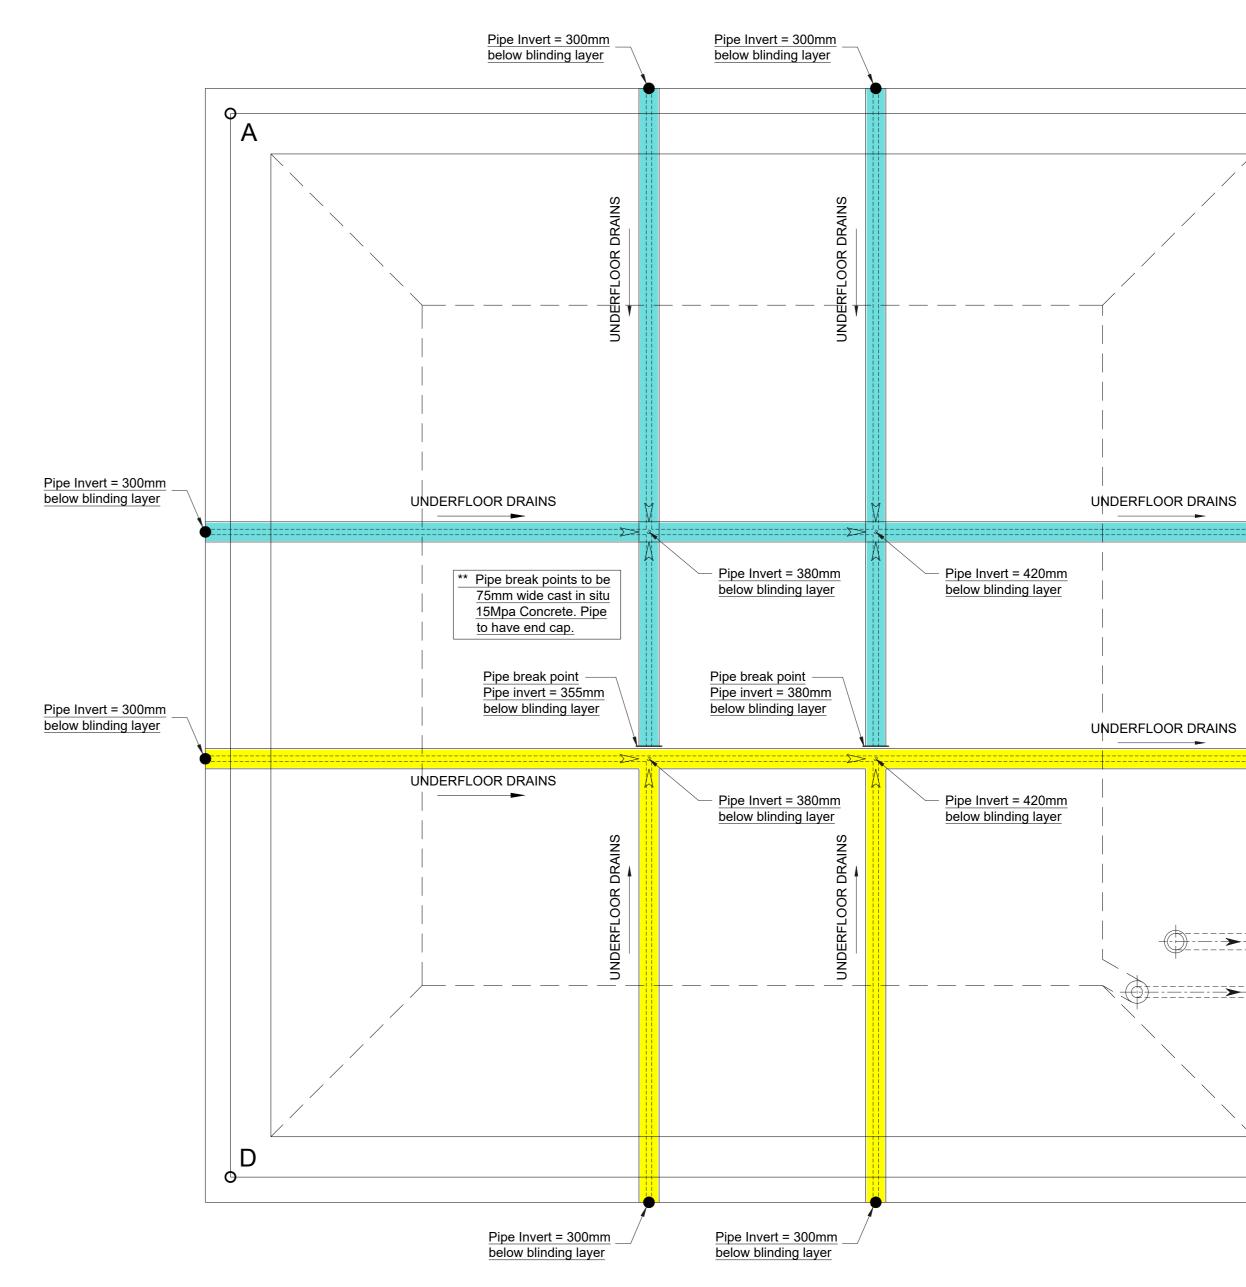


UNDERFLOOR DRAIN LAYOUT PLAN AND LEVELS SCALE 1:75

450/50D CONCRETE SCOUR PIPE TO EXISTING MUNICIPAL STORM WATER


(SEE DWG 60356/009 FOR HEADWALL DETAIL)


SYSTEM. REFER TO DWG 60356/016.


<u>B</u> 005

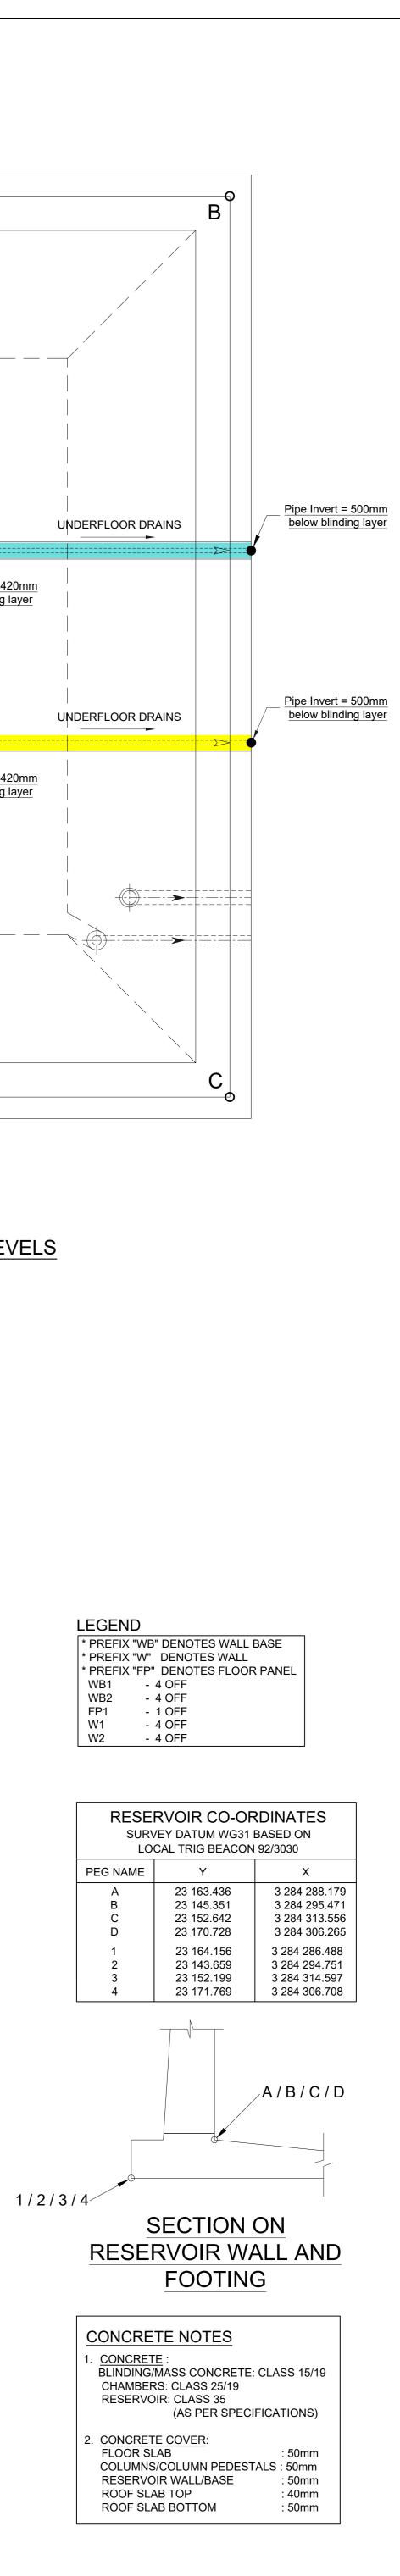



eTHEKWINI WATER SERVICES
water design branch eTHEKWINI
REDUCED PLAN USE SCALE BELOW
CONSULTANT:
CONSULTING
CONSULTINU
1st Floor Tel : +27 (0) 31 265 6007
No.5 The BoulevardFax : +27 (0) 31 265 6011West Way Office ParkE-mail : info@naiduconsulting.com
Westville, Durban DRAWING No.: D732-52-5250
FOR TENDER
Ref Drg. Description 60356/002 RESERVOIR SITE PLAN LAYOUT 1 of 1
60356/005RESERVOIR SECTION AND DETAILS1 of 160356/007DN300 OUTLET CHAMBER AND SCOUR DETAILS1 of 160356/009STANDARD ASSOCIATED DETAILS1 of 2
60356/009 STANDARD ASSOCIATED DETAILS 1 of 2 60356/009 STANDARD ASSOCIATED DETAILS 2 of 2
Standard Drawings
Reinforcing Ref. Drawings
Geotech Ref. Drawings
063-20.R02-001 Detail of Ground Improvement for Proposed Reservoir
0OCT. 2021FOR TENDER PURPOSES ONLYRevisionDateDescription
NOTE: No construction work to commence until land and servitude
acquisitions have been completed Acquisitions
completed: Date Engineer NORTH POINT
Date Engineer NORTH POINT UNDERGROUND SERVICES CHECKED - SERVICE DATE SIGNATURE
SERVICE DATE SIGNATORE S.W DRAINS
WATERMAINS TELKOM CABLES
ELECTRIC CABLES S.A.R CABLES E.S.C CABLES
E.S.C CABLES OIL PIPE LINE NOTE: Only underground services affected by new construction are
shown. Care must be taken during excavations for road foundations, trenches etc., to avoid damage to underground services such as sewers, drains, cables, watermains and
connections.Wherever possible these must be located before work begins.
WS 7400
Contract No.
Project No. D732
Planning Unit EWS
EVV3 Project Title
THANDOKUHLE RESERVOIR
COMPARTMENT 1 CONSTRUCTION OF A 3ML REINFORCED
CONCRETE RESERVOIR,
150mm Ø STEEL INLET, 300mm Ø STEEL OUTLET PIPELINES AND ASSOCIATED
WORKS Drawing Title
RESERVOIR
FLOOR PLAN
Scales : 1:75 Original paper size : A0
Designed : D. Ramghulam Date : May 2021
Checked : A. Goorun Drawn : N. Adams
Checked : A. Goorun Drawn : N. Adams Area Engineer (W.O.)
Area Engineer (W.O.)
Area Engineer (W.O.) Manager (W.D.)

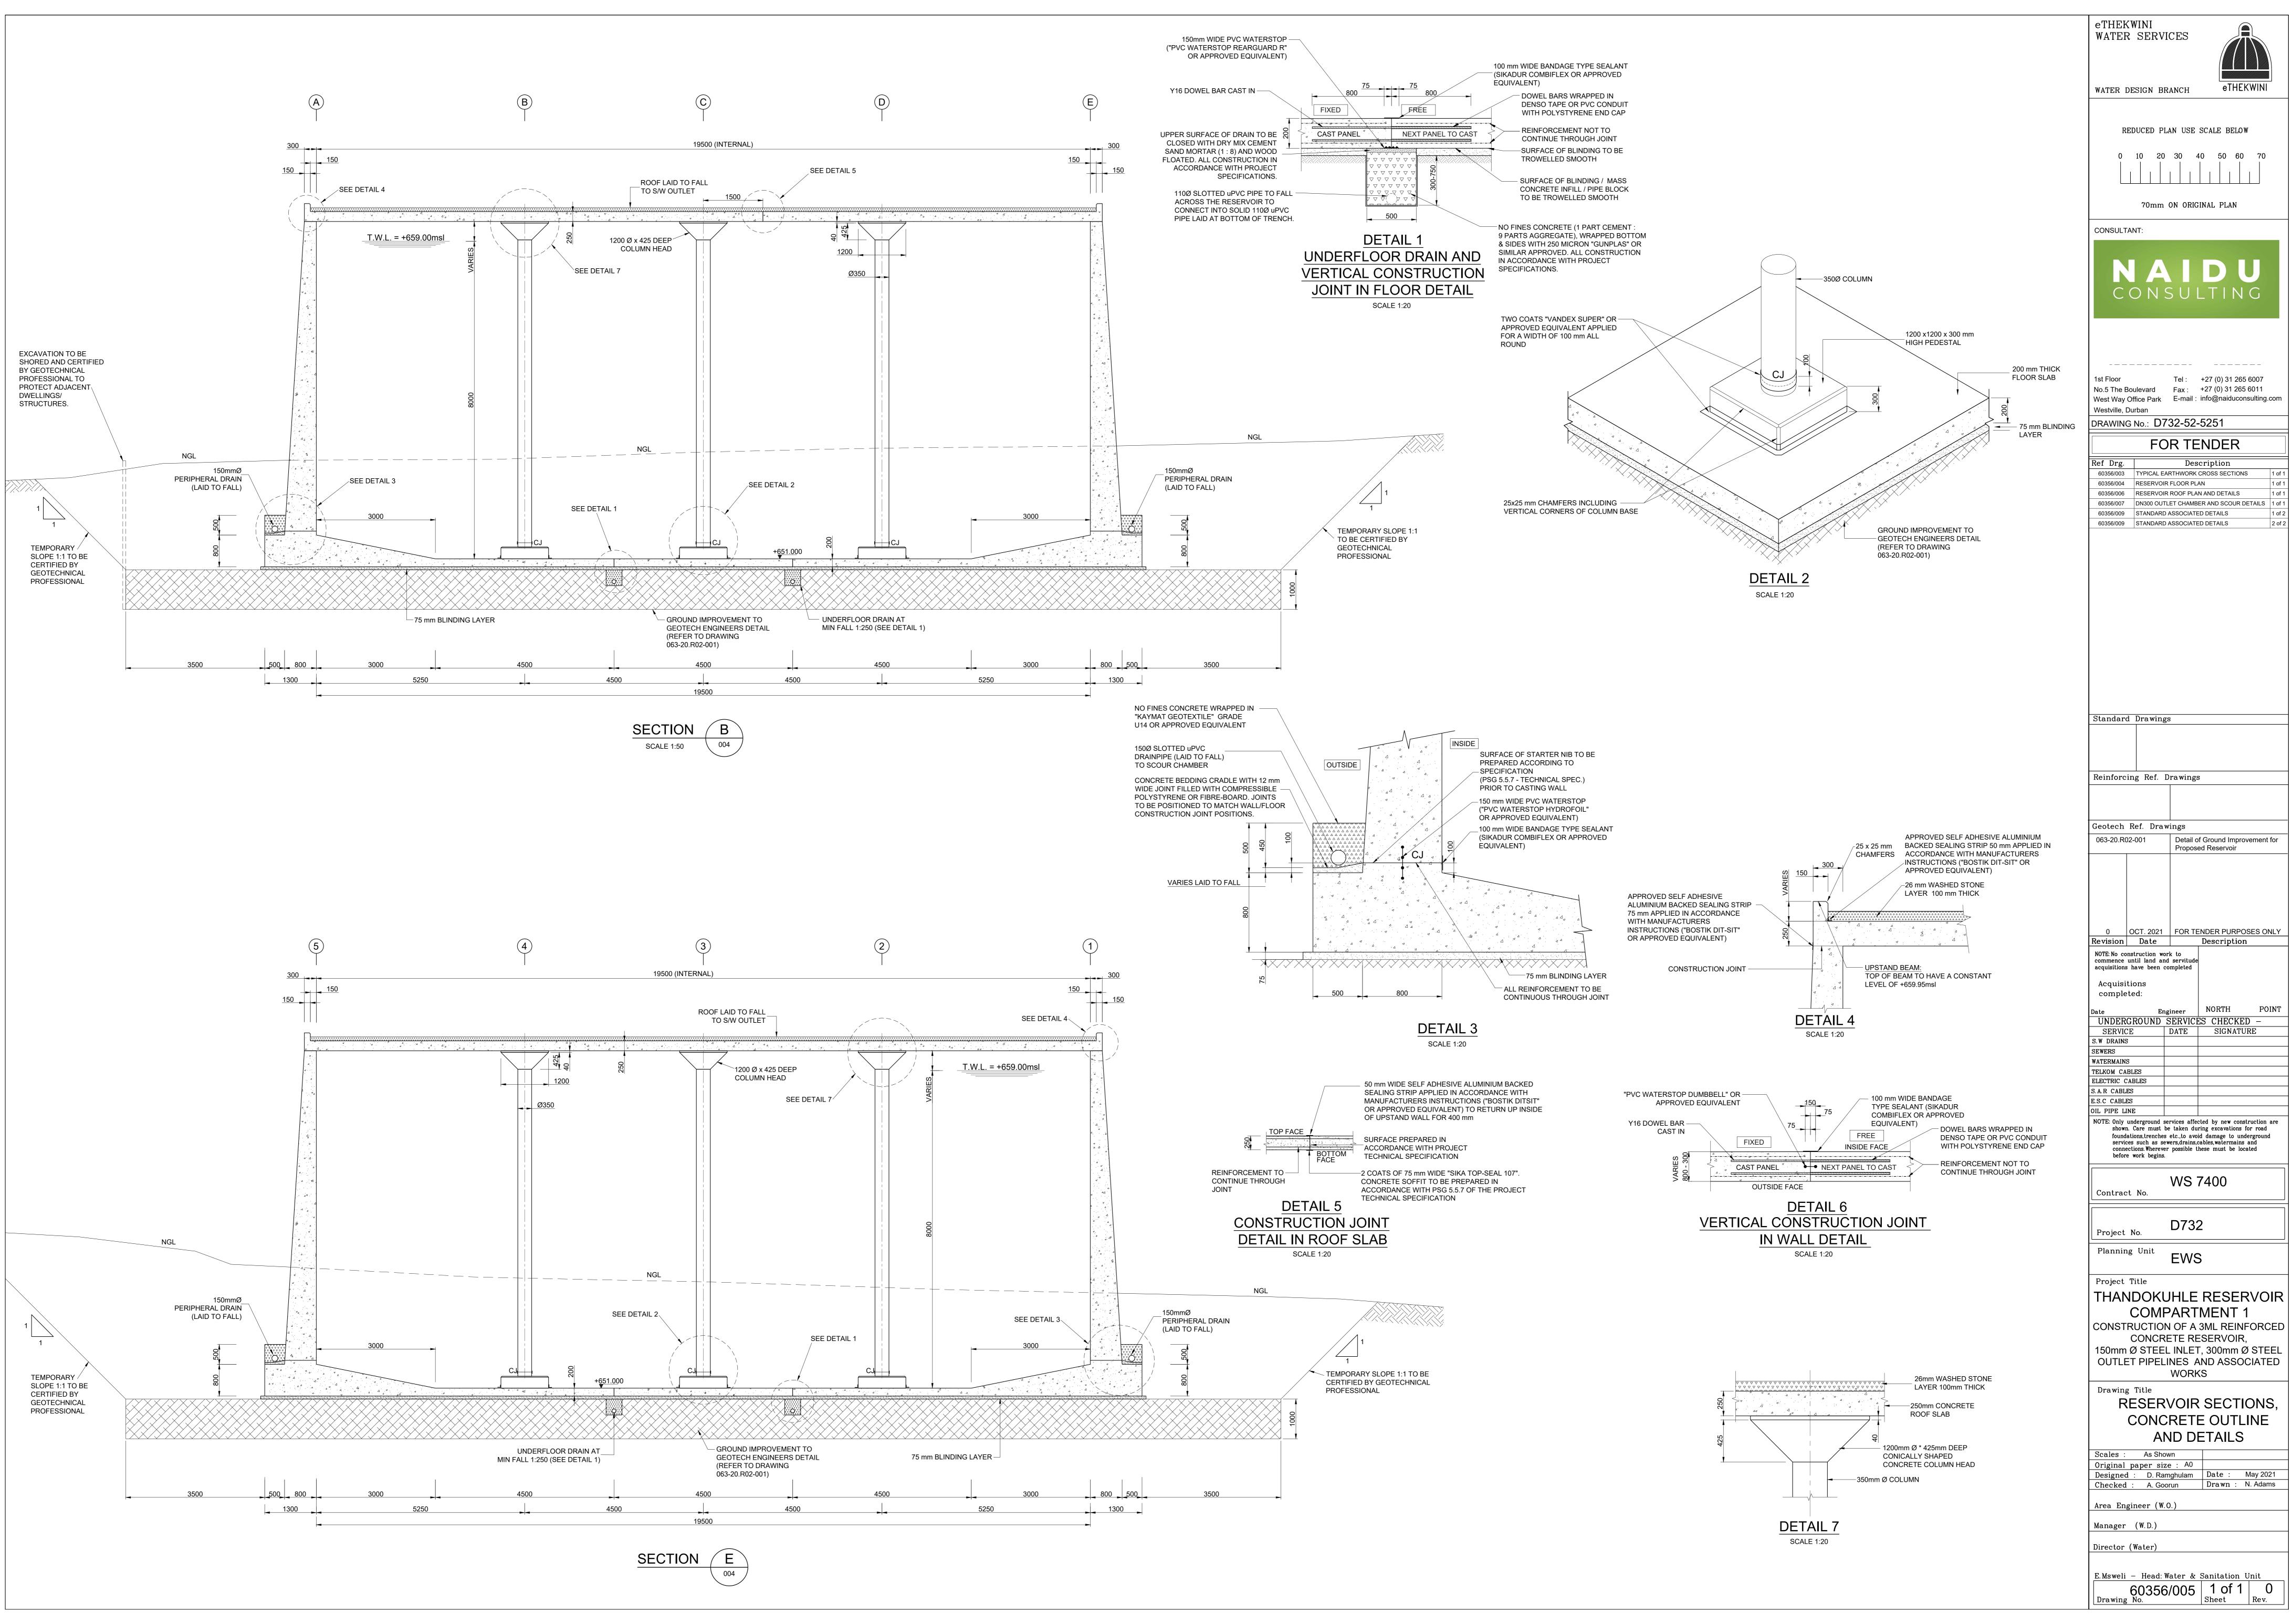


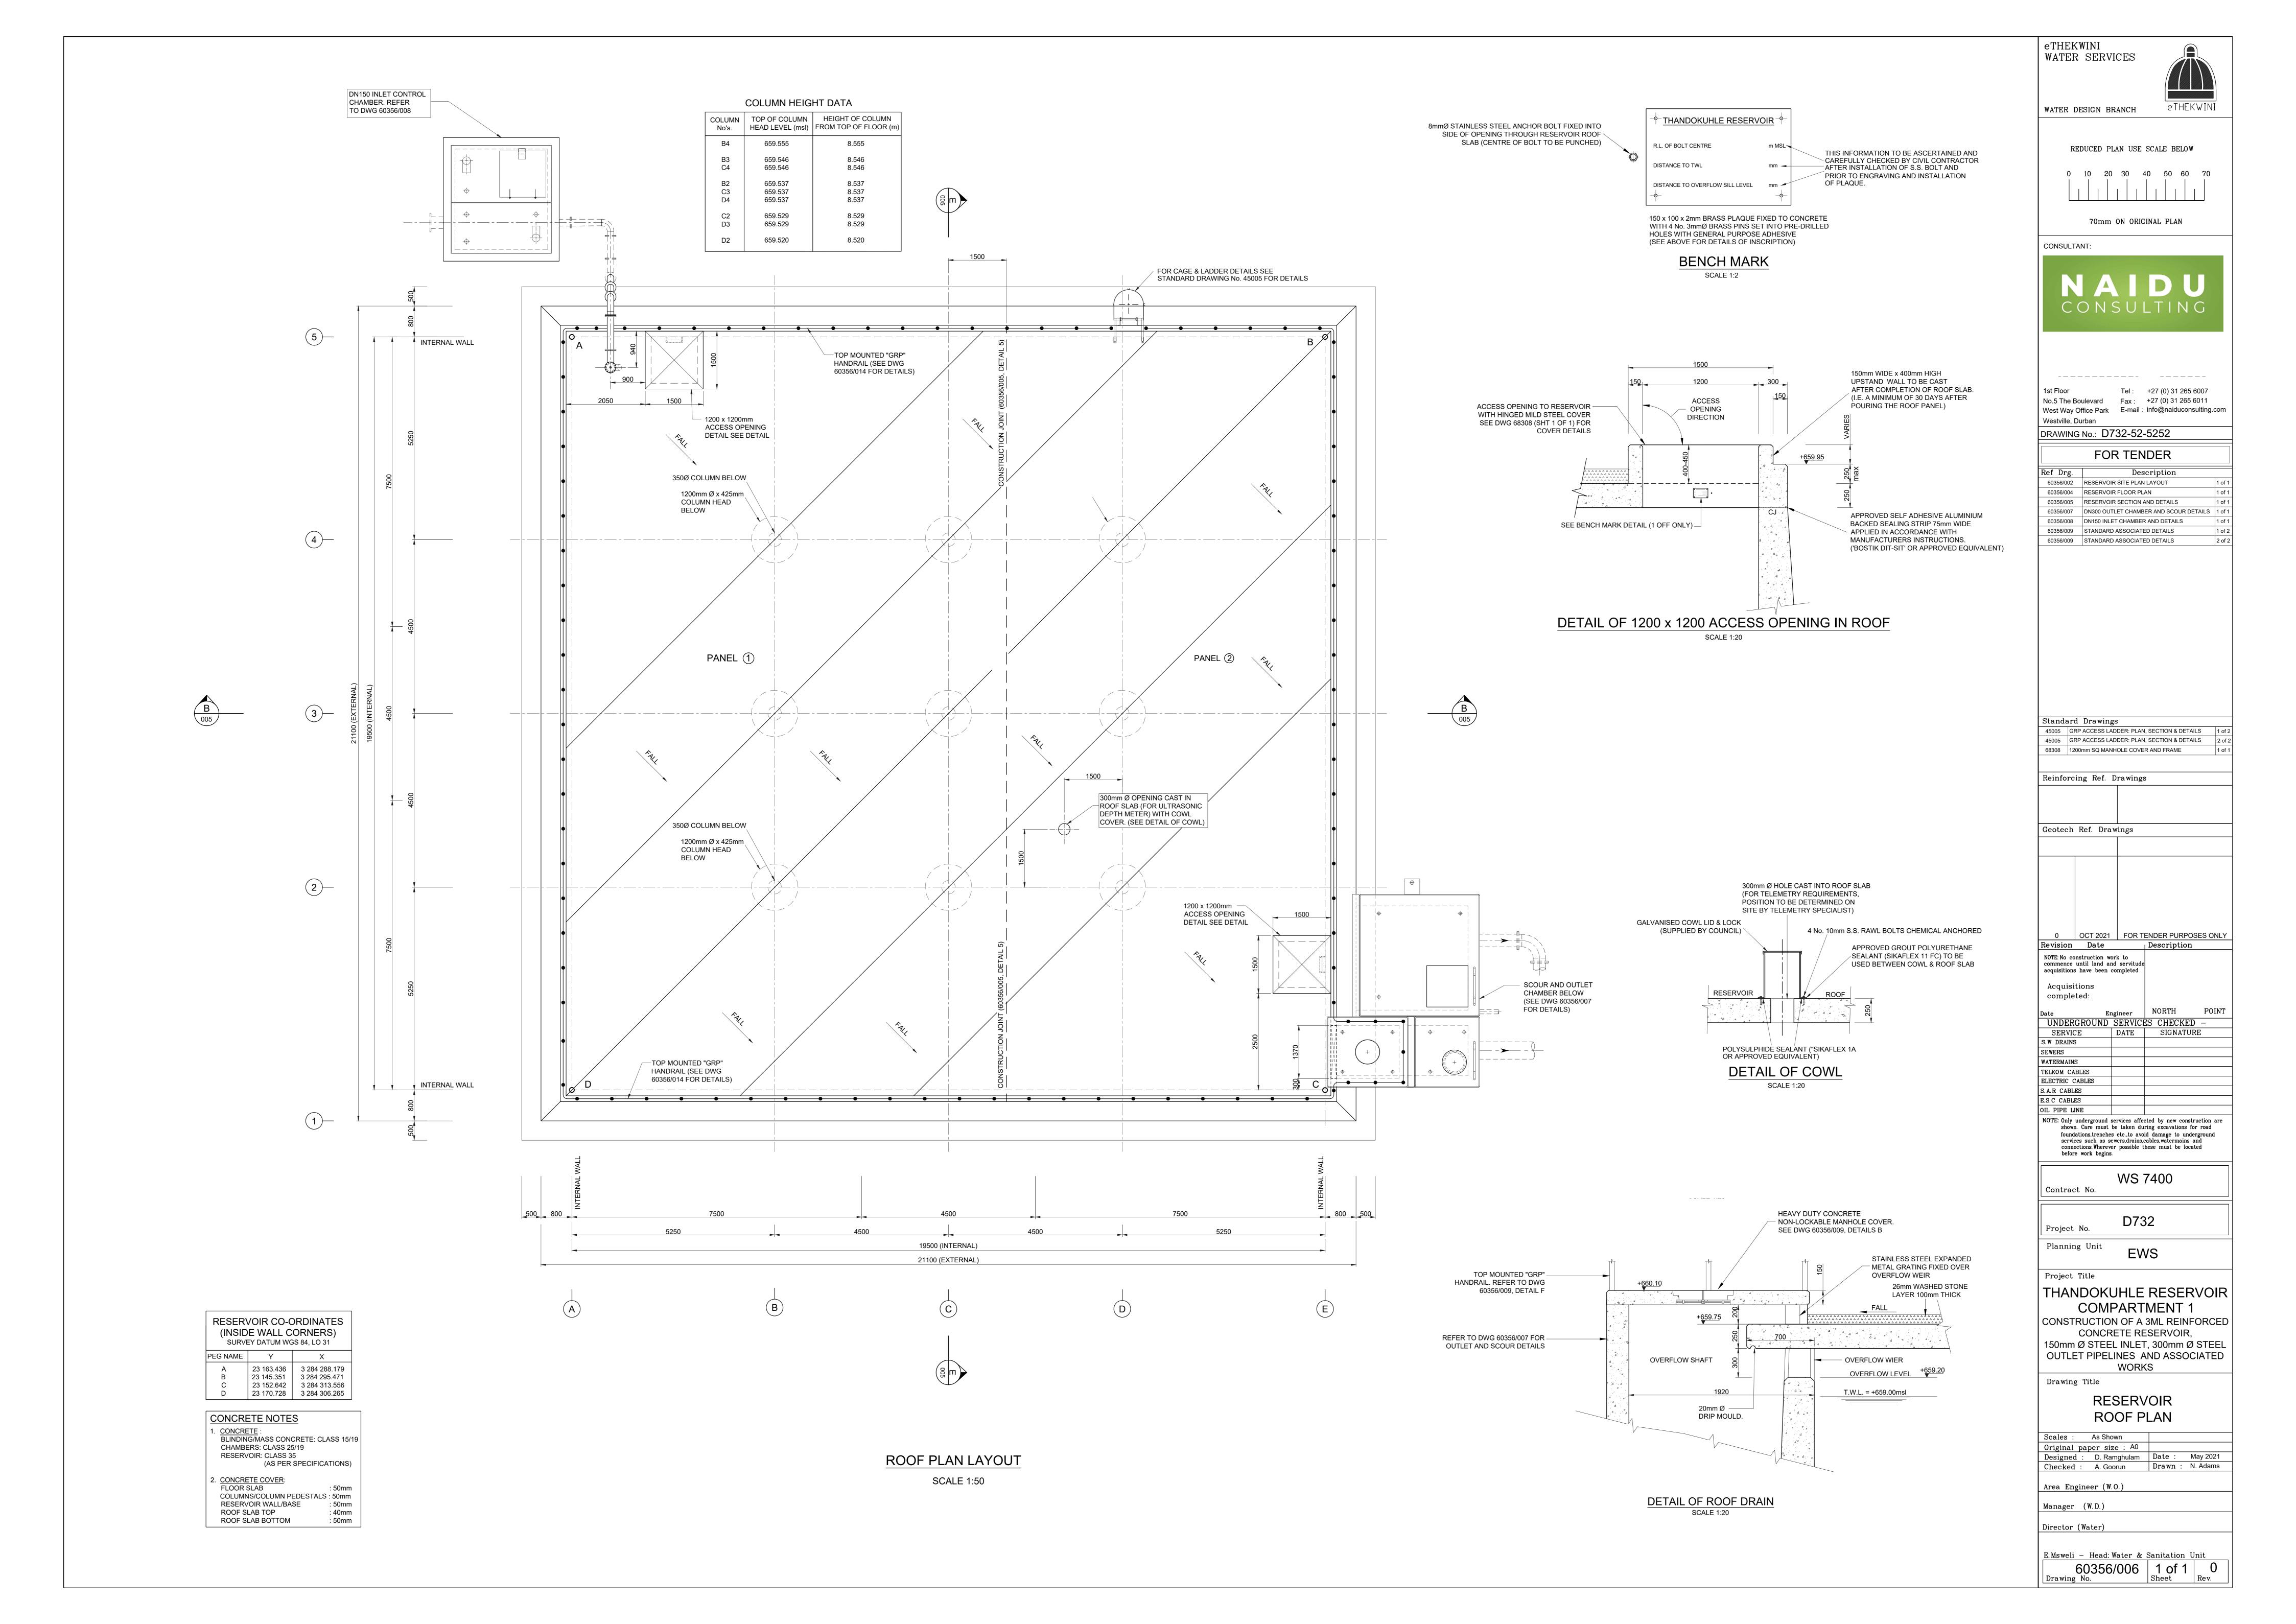


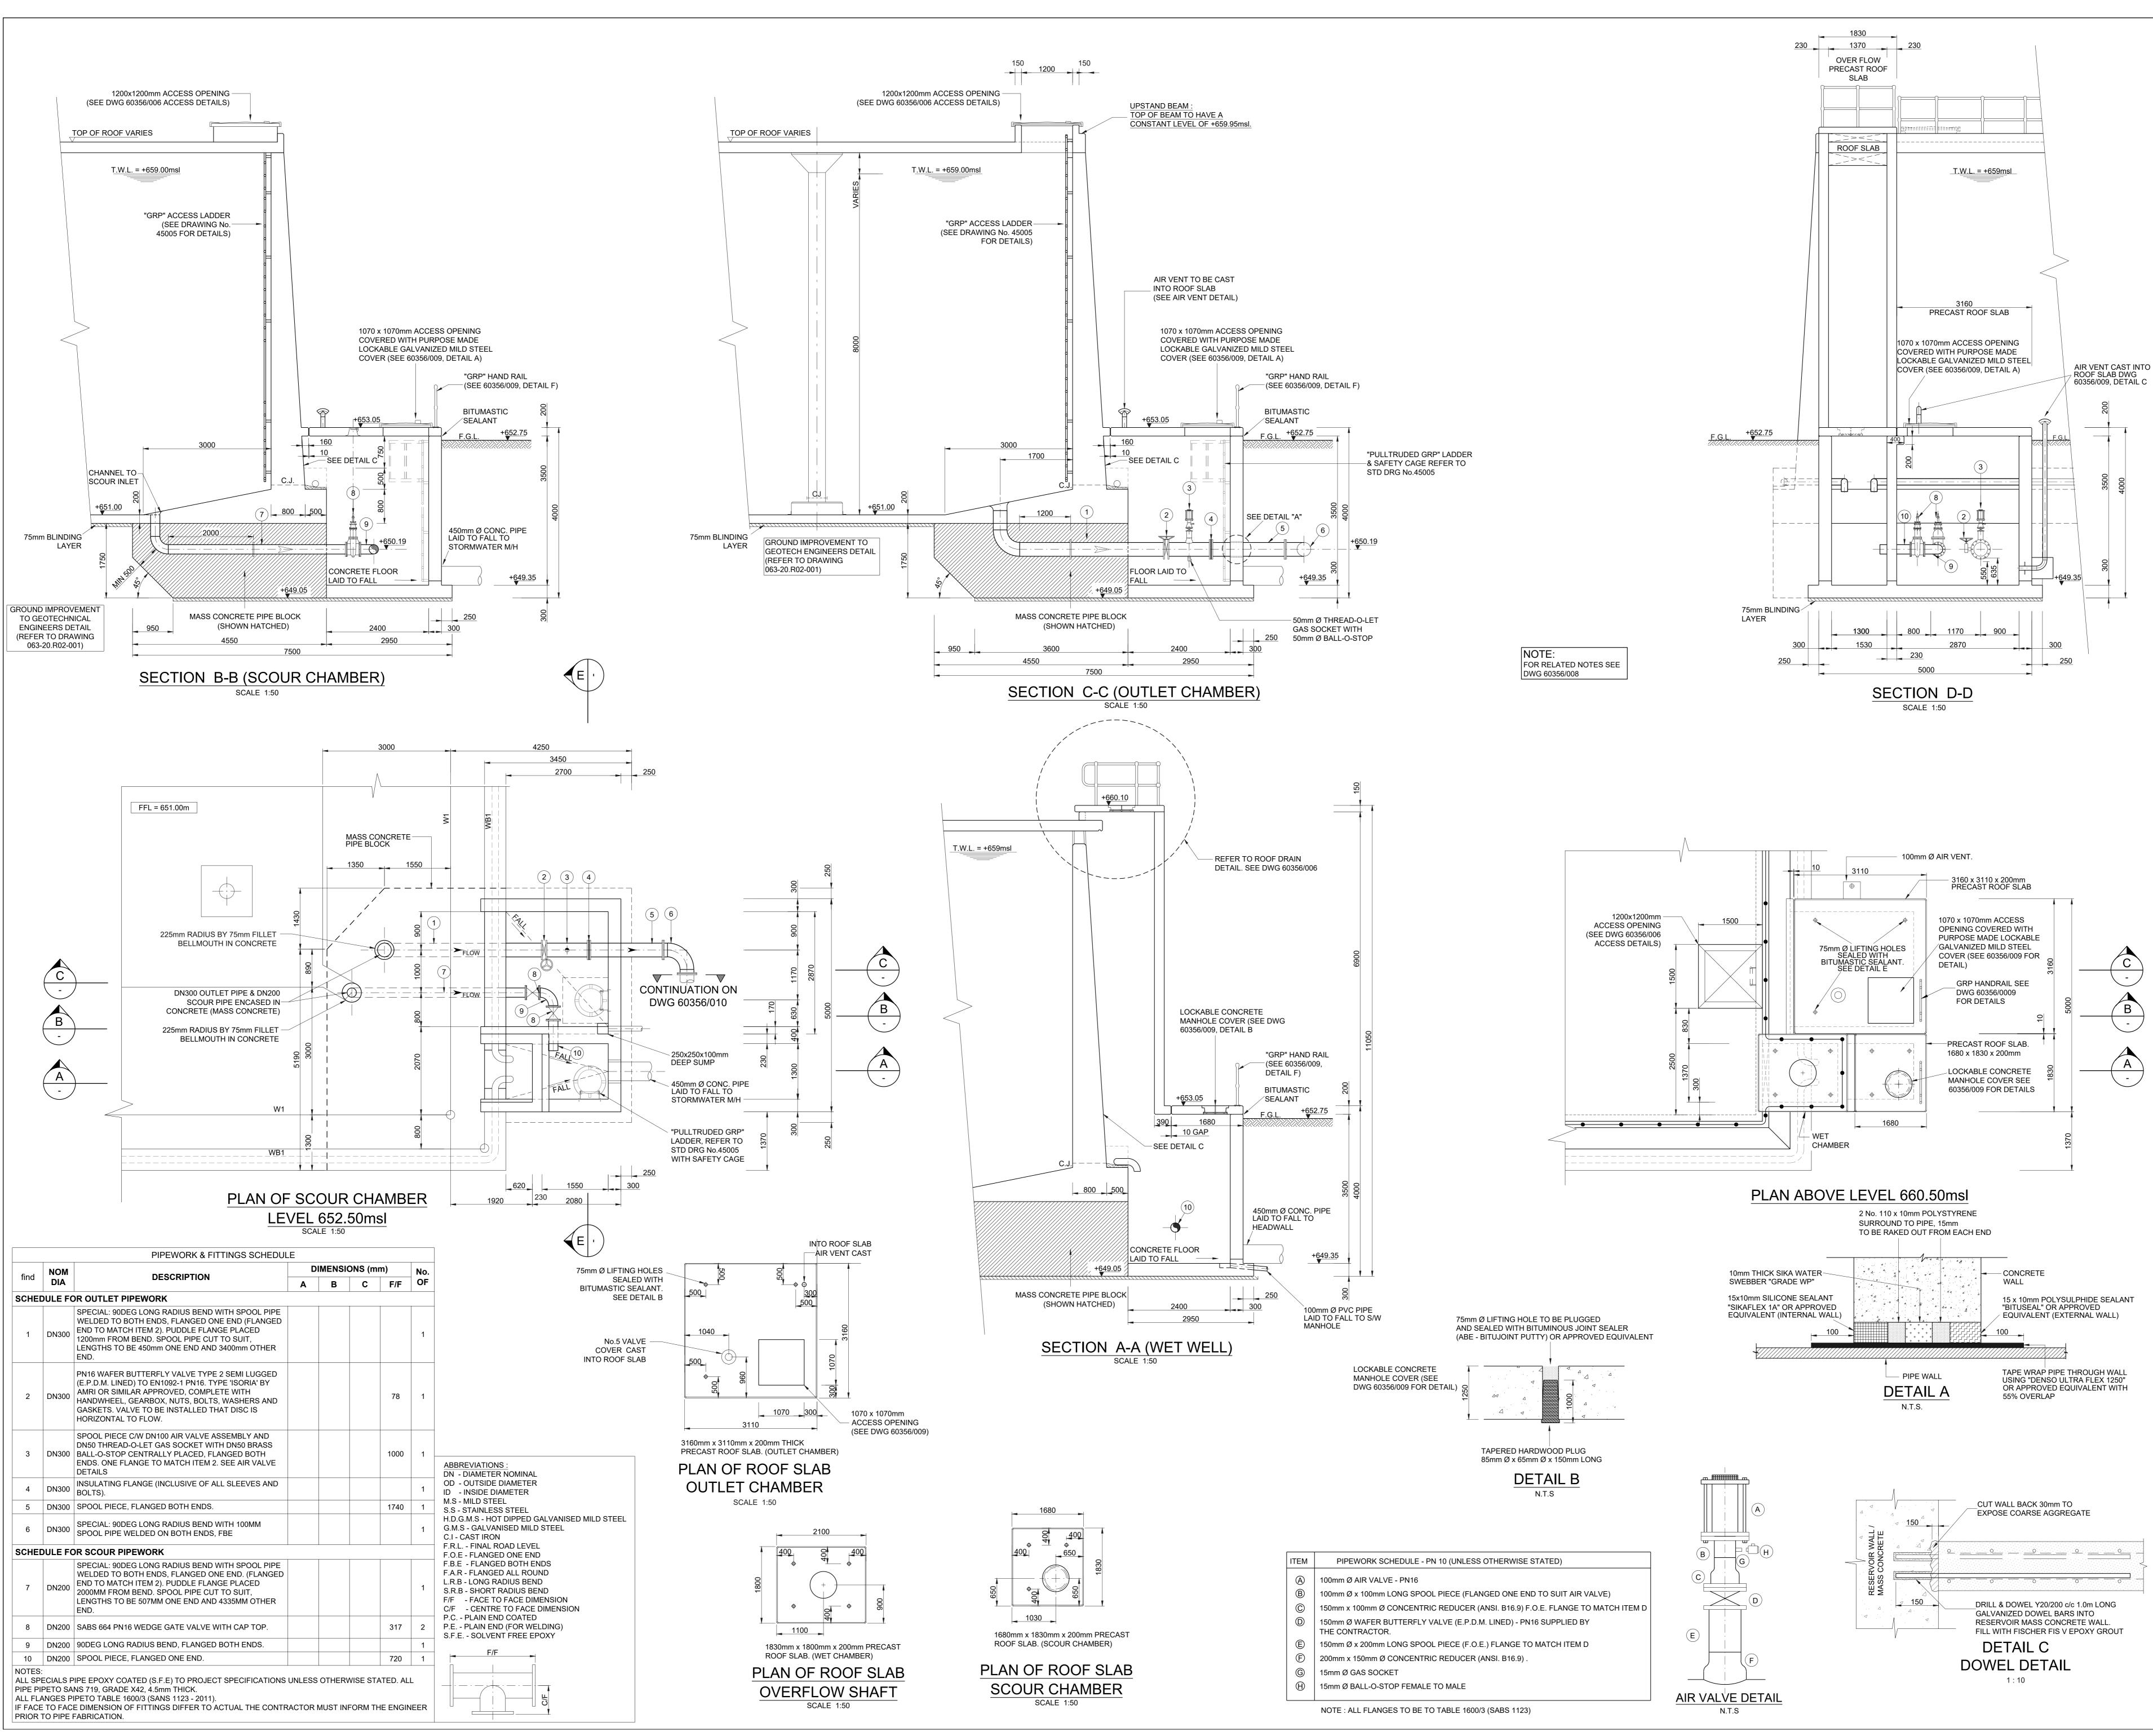

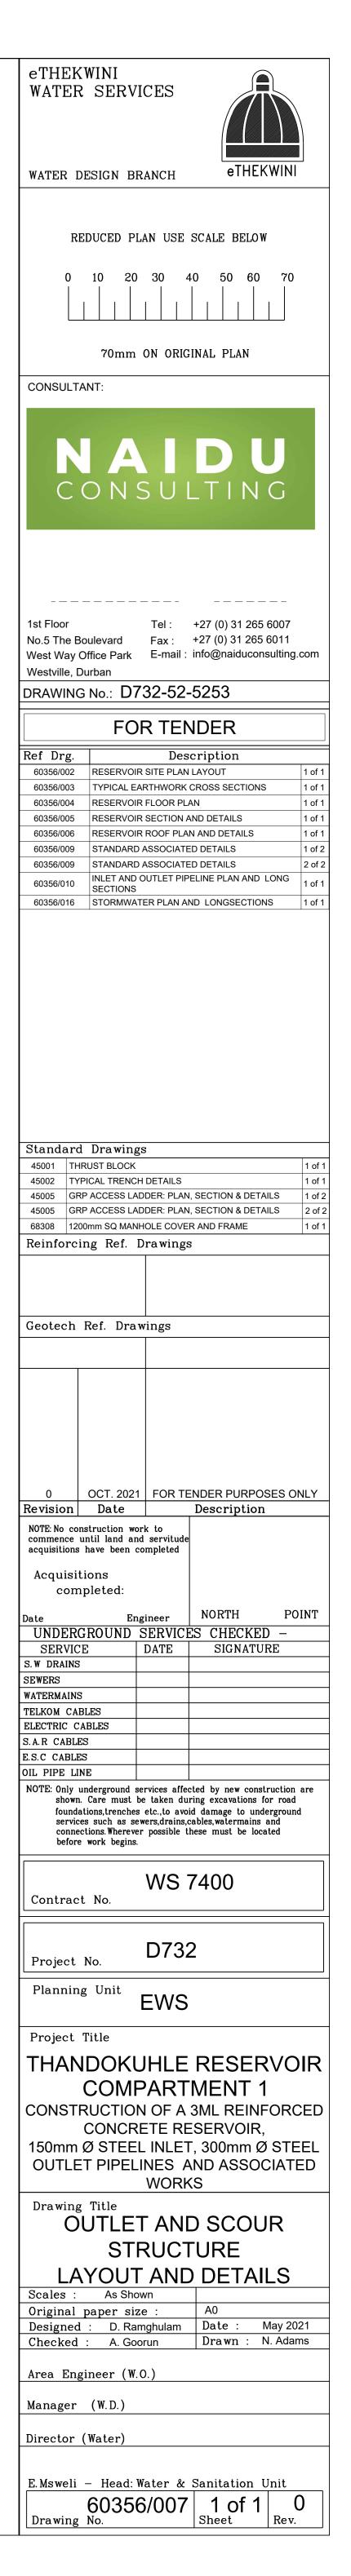


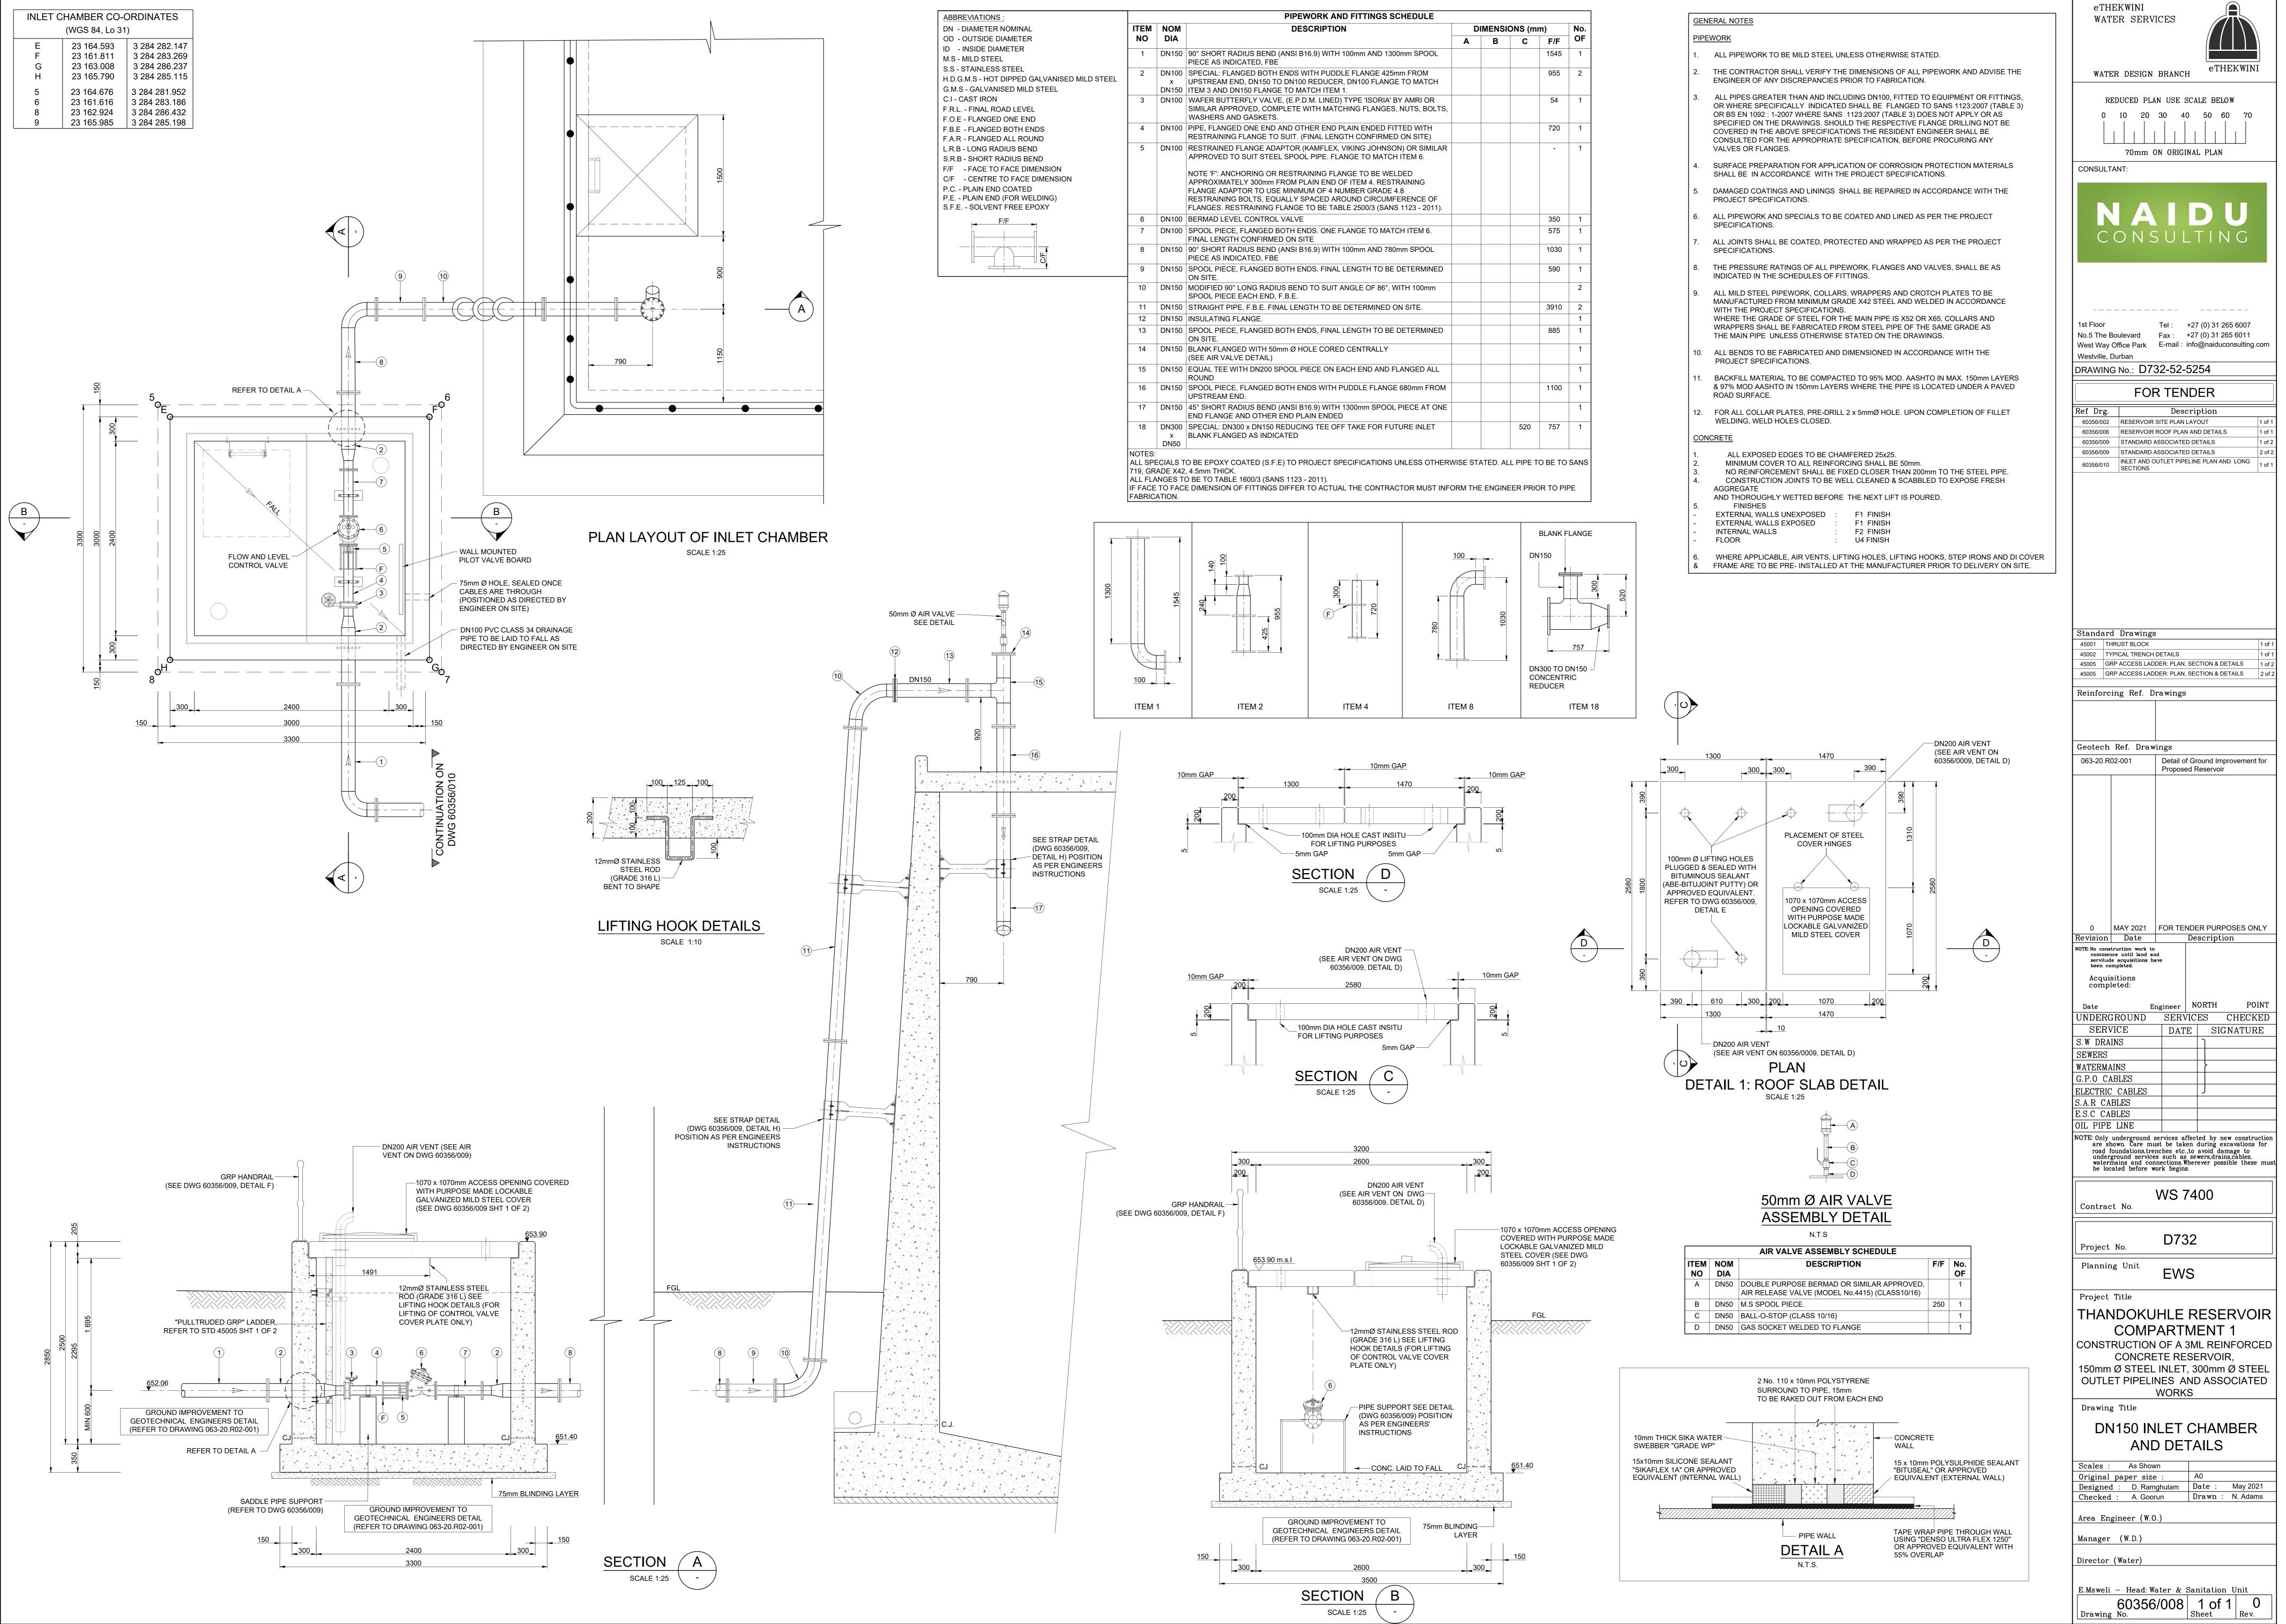

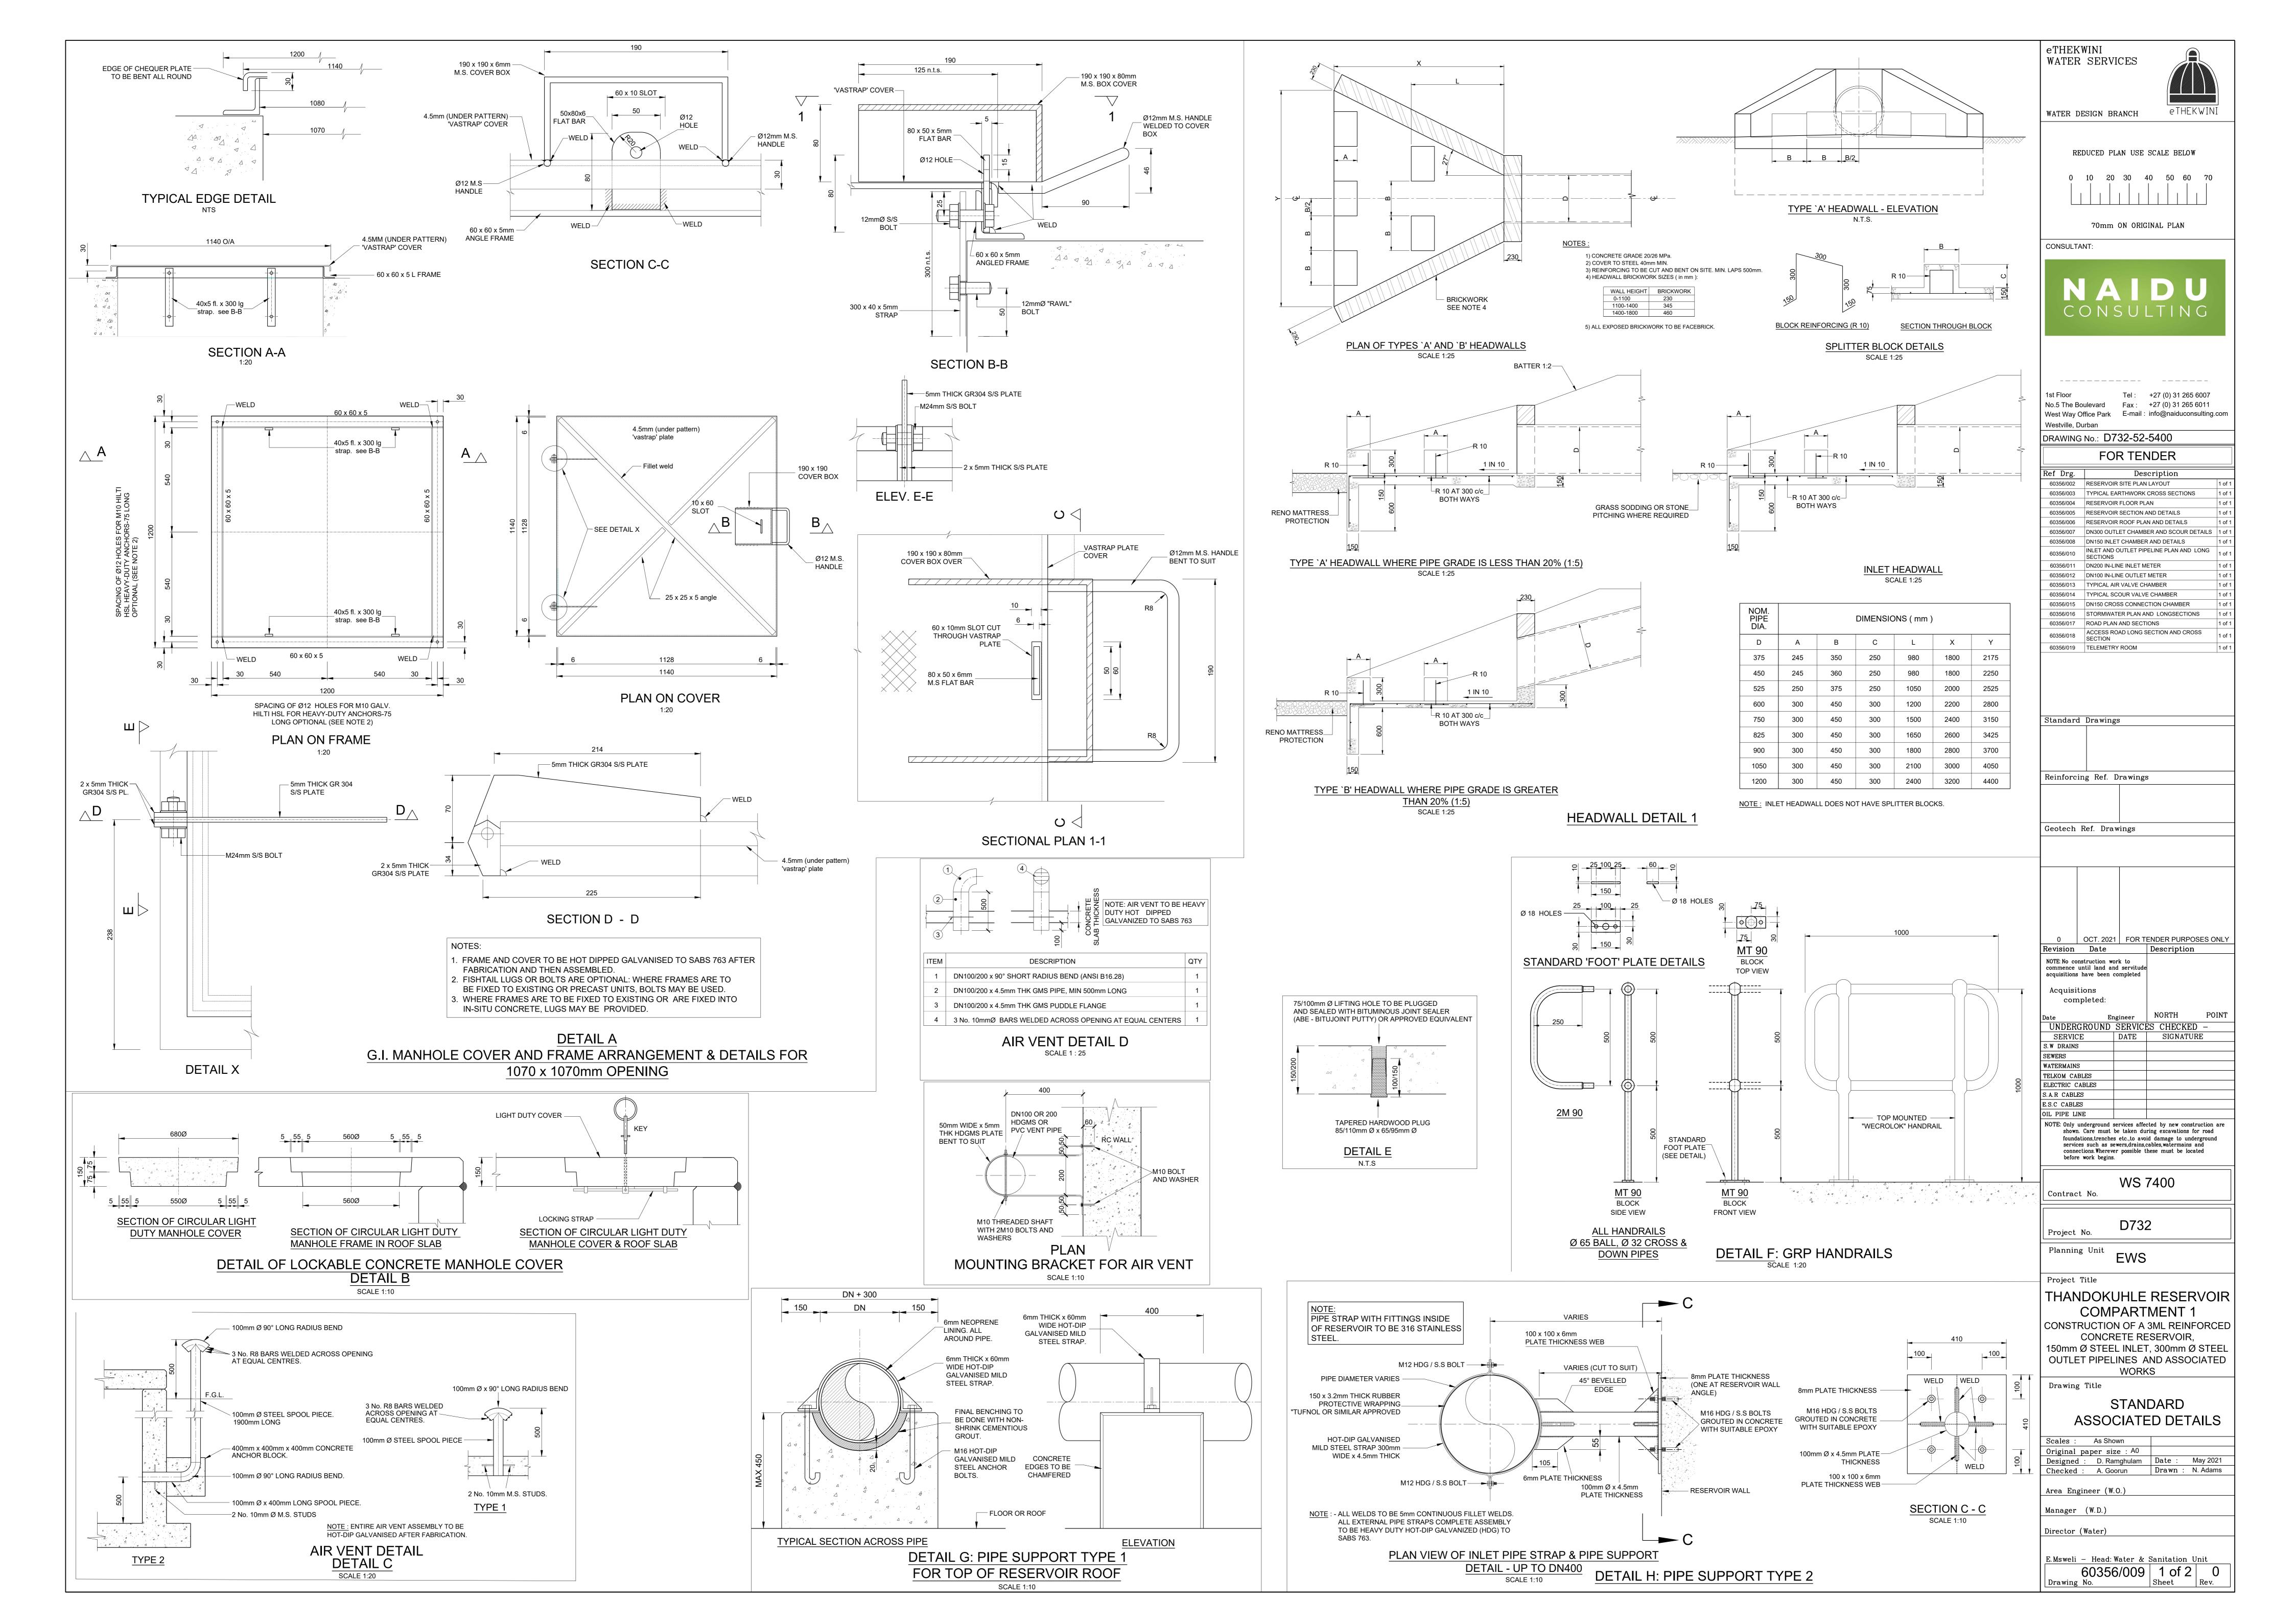


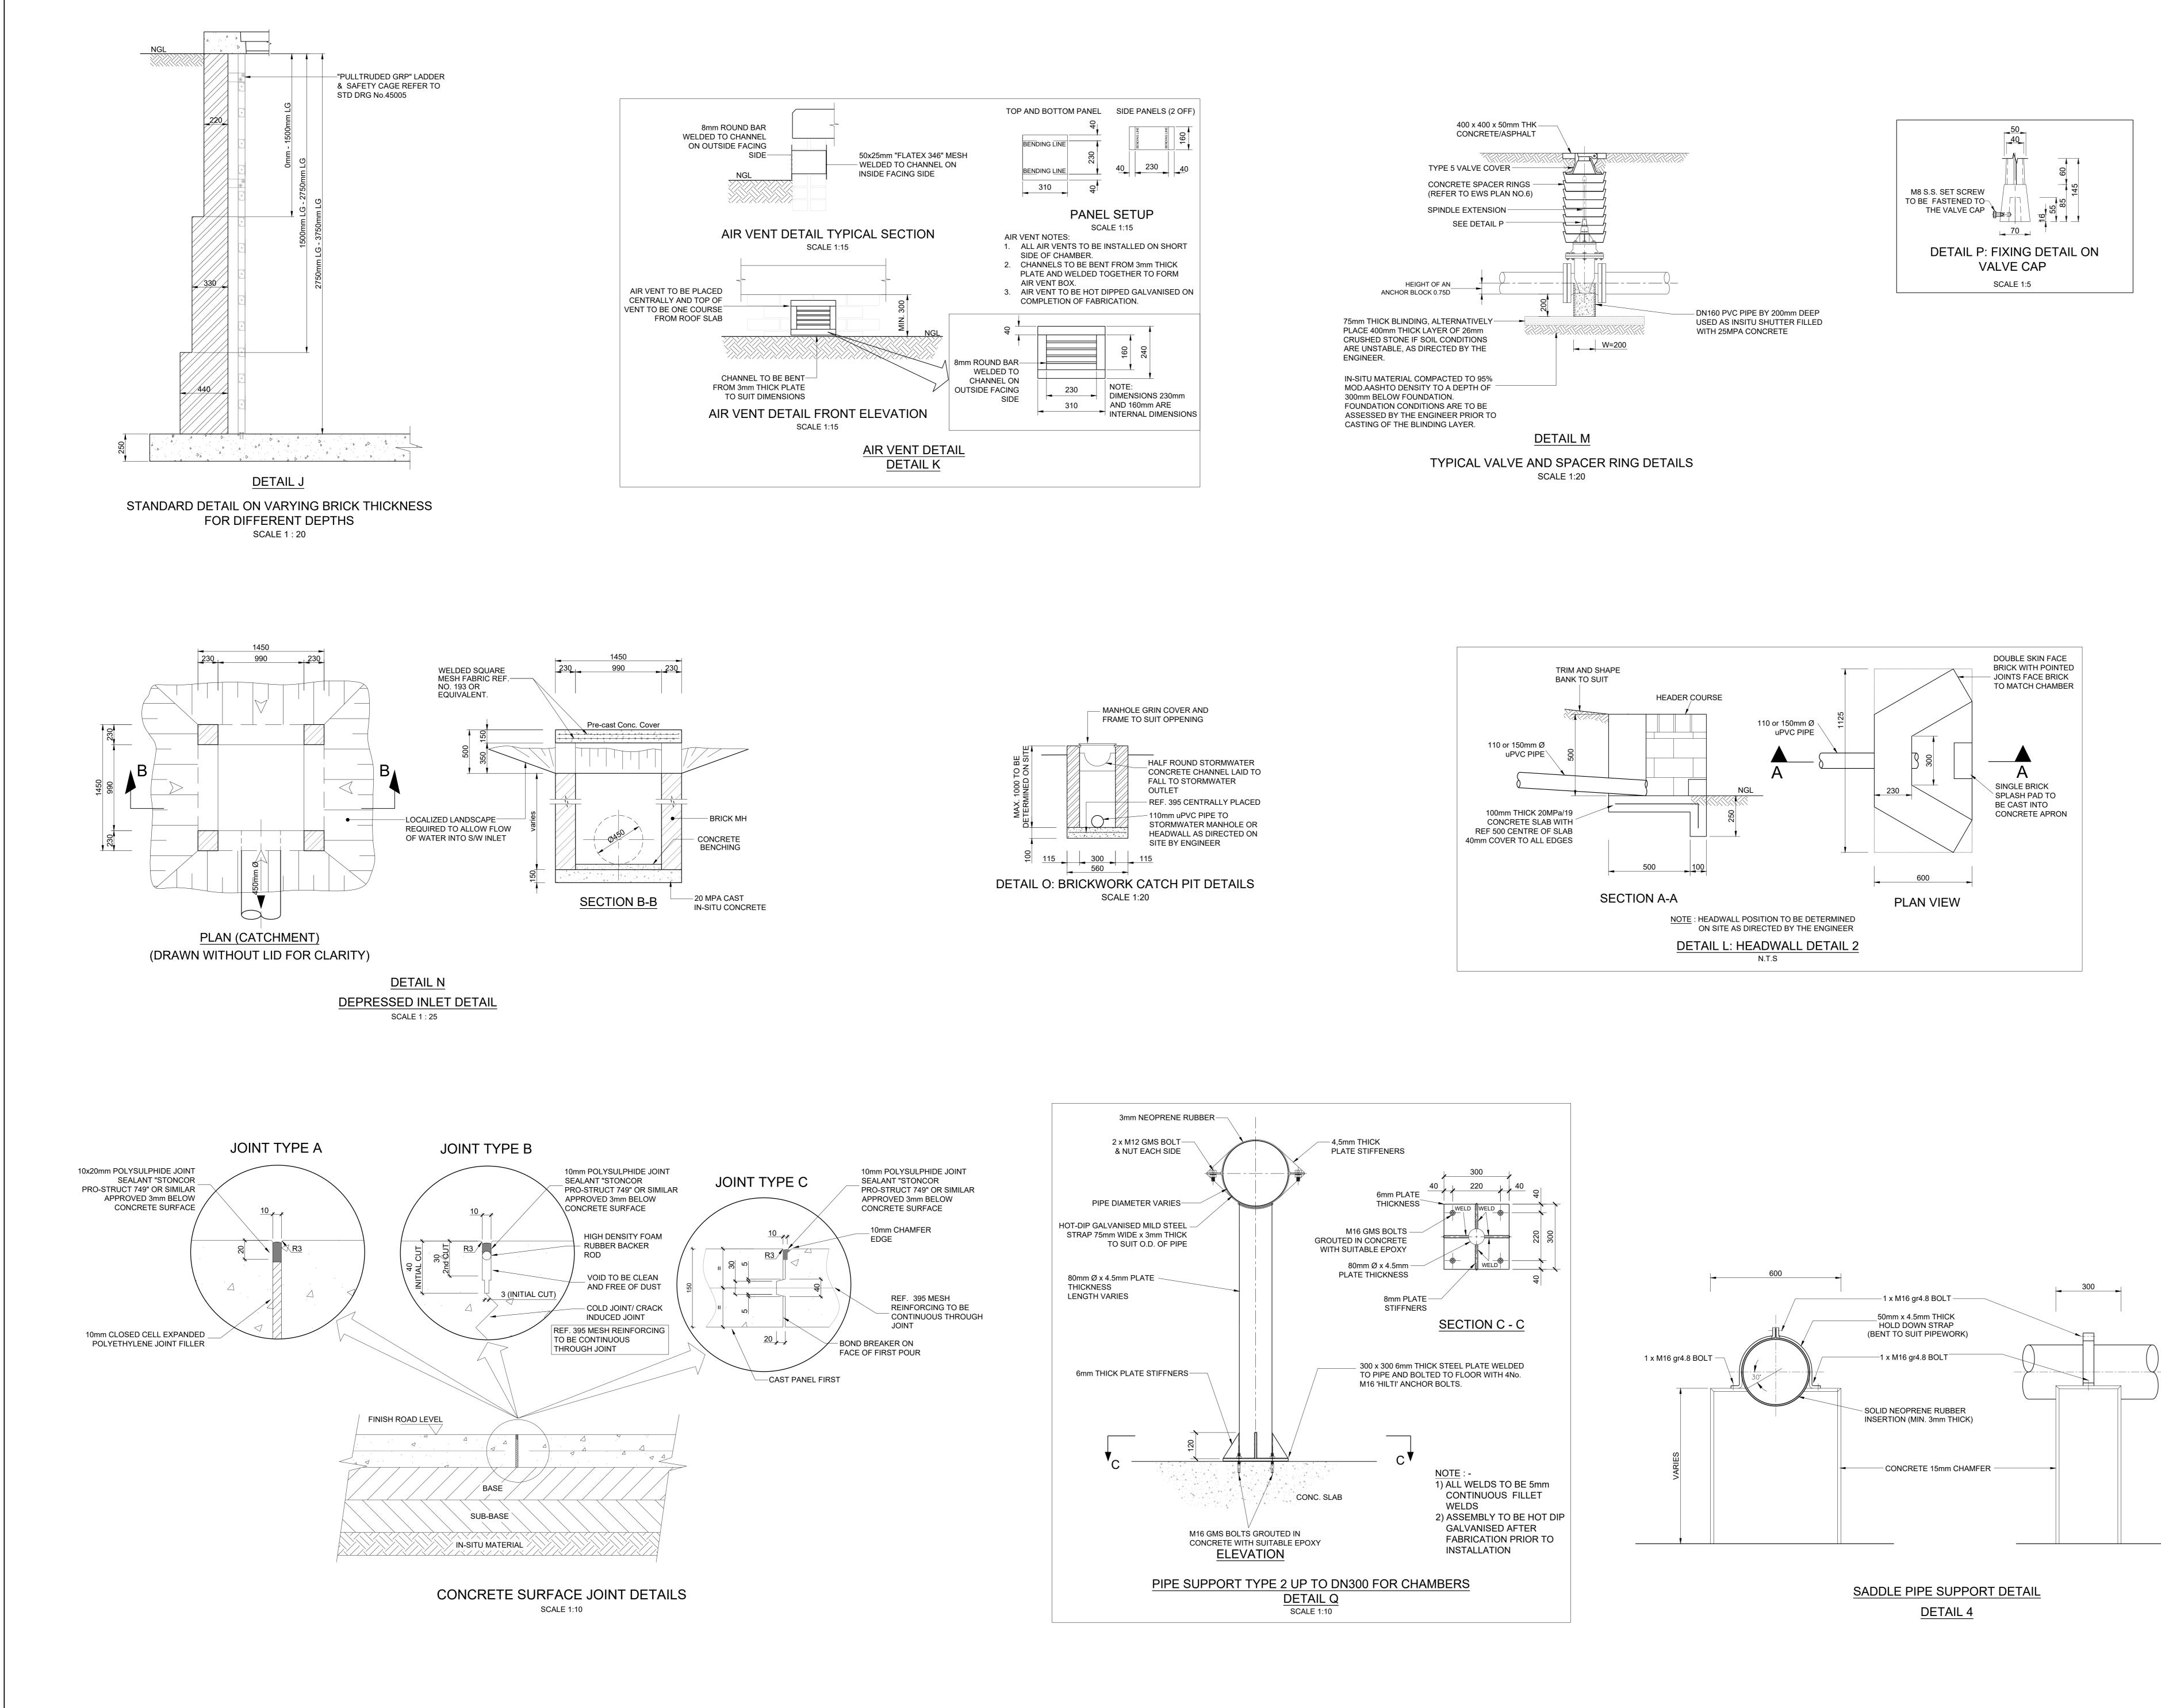

eTHEKWINI WATER SERVICES	
WATER DESIGN BRANCH eTHEKWIN	J
REDUCED PLAN USE SCALE BELOW	
0 10 20 30 40 50 60 70	
70mm ON ORIGINAL PLAN	
CONSULTANT:	
NAIDU	
CONSULTING	
1st Floor Tel : +27 (0) 31 265 6007 No.5 The Boulevard Fax : +27 (0) 31 265 6011	
West Way Office Park E-mail : info@naiduconsulting.o Westville, Durban	com
DRAWING No.: D732-52-5400	
FOR TENDER Ref Drg. Description	
60356/002RESERVOIR SITE PLAN LAYOUT60356/003TYPICAL EARTHWORK CROSS SECTIONS60356/004RESERVOIR FLOOR PLAN	1 of 1 1 of 1 1 of 1
60356/004 RESERVOIR FLOOR PLAN 60356/005 RESERVOIR SECTION AND DETAILS 60356/006 RESERVOIR ROOF PLAN AND DETAILS	1 of 1 1 of 1
60356/007 DN300 OUTLET CHAMBER AND SCOUR DETAILS 60356/008 DN150 INLET CHAMBER AND DETAILS 60356/010 INLET AND OUTLET PIPELINE PLAN AND LONG	1 of 1 1 of 1 1 of 1
60356/010 SECTIONS 60356/011 DN200 IN-LINE INLET METER 60356/012 DN100 IN-LINE OUTLET METER	1 of 1 1 of 1 1 of 1
60356/013 TYPICAL AIR VALVE CHAMBER 60356/014 TYPICAL SCOUR VALVE CHAMBER	1 of 1 1 of 1
60356/015 DN150 CROSS CONNECTION CHAMBER 60356/016 STORMWATER PLAN AND LONGSECTIONS 60356/017 ROAD PLAN AND SECTIONS	1 of 1 1 of 1 1 of 1
60356/018 ACCESS ROAD LONG SECTION AND CROSS SECTION 60356/019 TELEMETRY ROOM	1 of 1 1 of 1
Standard Drawings	
Reinforcing Ref. Drawings	
Geotech Ref. Drawings	
deoteen hei. Drawings	
0 OCT. 2021 FOR TENDER PURPOSES O	
Revision Date Description	NLY
Revision Date Description NOTE: No construction work to commence until land and servitude acquisitions have been completed August 1	NLY
NOTE: No construction work to commence until land and servitude	NLY
NOTE: No construction work to commence until land and servitude acquisitions have been completed Acquisitions completed: Date Engineer NORTH PO	
NOTE: No construction work to commence until land and servitude acquisitions have been completed Acquisitions completed Acquisitions completed: Date Engineer NORTH PO UNDERGROUND SERVICES CHECKED S.W DRAINS Image: Completed	
NOTE: No construction work to commence until land and servitude acquisitions have been completed Acquisitions completed Acquisitions completed: Date Engineer NORTH POINDERGROUND SERVICES CHECKED – SERVICE DATE SIGNATURE	
NOTE: No construction work to commence until land and servitude acquisitions have been completed Acquisitions completed Acquisitions completed: NORTH PO Date Engineer NORTH PO UNDERGROUND SERVICES CHECKED - SERVICE DATE SIGNATURE SIGNATURE S.W DRAINS SEWERS - - WATERMAINS Image: Complete Signature - - S.A.R CABLES Image: Complete Signature - -	
NOTE: No construction work to commence until land and servitude acquisitions have been completed Acquisitions completed Acquisitions completed: NORTH PO Date Engineer NORTH PO UNDERGROUND SERVICES CHECKED - SERVICE DATE SIGNATURE SIGNATURE S.W DRAINS SEWERS - - WATERMAINS SELECTRIC CABLES - - S.A.R CABLES - - - OIL PIPE LINE ONL PIPE LINE - -	
NOTE: No construction work to commence until land and servitude acquisitions have been completed Acquisitions completed: Date Engineer NORTH POT UNDERGROUND SERVICES CHECKED – SERVICE DATE SIGNATURE S.W DRAINS SEWERS WATERMAINS TELKOM CABLES ELECTRIC CABLES S.A.R CABLES OIL PIPE LINE NOTE: Only underground services affected by new construction shown. Care must be taken during excavations for road foundations, trenches etc., to avoid damage to underground services such as sewers, drains, cables, watermains and connections. Wherever possible these must be located	INT
NOTE: No construction work to commence until land and servitude acquisitions have been completed Acquisitions completed: Date Engineer NORTH PO: UNDERGROUND SERVICES CHECKED – SERVICE DATE SIGNATURE S.W DRAINS SEWERS WATERMAINS ELECTRIC CABLES S.A.R CABLES E.S.C CABLES OIL PIPE LINE NOTE: Only underground services affected by new construction shown. Care must be taken during excavations for road foundations, trenches etc., to avoid damage to underground services such as sewers, drains, cables, watermains and connections. Wherever possible these must be located before work begins.	INT
NOTE: No construction work to commence until land and servitude acquisitions have been completed Acquisitions completed: Date Engineer NORTH POT UNDERGROUND SERVICES CHECKED - SERVICE DATE SIGNATURE S.W DRAINS SEWERS WATERMAINS TELKOM CABLES ELECTRIC CABLES S.A.R CABLES OIL PIPE LINE NOTE: Only underground services affected by new construction shown. Care must be taken during excavations for road foundations, trenches etc., to avoid damage to underground services such as sewers, drains, cables, watermains and connections. Wherever possible these must be located	INT
NOTE: No construction work to commence until land and servitude acquisitions have been completed Acquisitions completed: Date Engineer NORTH PO UNDERGROUND SERVICES CHECKED - SERVICE DATE SIGNATURE S S.W DRAINS SEWERS SEWERS SEWERS SEWERS WATERMAINS SELECTRIC CABLES SELECTRIC CABLES SES SES OIL PIPE LINE NOTE: Only underground services affected by new construction shown. Care must be taken during excavations for road foundations, trenches etc., to avoid damage to underground services such as sewers, drains, cables, watermains and connections. Wherever possible these must be located before work begins. WS 7400 Contract No.	INT
NOTE: No construction work to commence until land and servitude acquisitions have been completed Acquisitions completed: Date Engineer NORTH POI UNDERGROUND SERVICES CHECKED - SERVICE DATE SIGNATURE SIGNATURE S.W DRAINS - SEWERS - WATERMAINS - ELECTRIC CABLES - S.A.R CABLES - E.S.C CABLES - OIL PIPE LINE - NOTE: Only underground services affected by new construction shown. Care must be taken during excavations for road foundations, trenches etc., to avoid damage to undergroud services such as sewers, drains, cables, watermains and connections. Wherever possible these must be located before work begins. WXS 7400 Contract No. - D732 Project No. -	INT
NOTE: No construction work to commence until land and servitude acquisitions have been completed Acquisitions completed Acquisitions completed: Date Engineer NORTH PO UNDERGROUND SERVICES CHECKED - SERVICE DATE SIGNATURE S.W DRAINS SEWERS WATERMAINS TELKOM CABLES ELECTRIC CABLES S.A.R CABLES S.A.R CABLES OIL PIPE LINE ONTE: Only underground services affected by new construction shown. Care must be taken during excavations for road foundations, trenches etc., to avoid damage to underground services such as sewers, drains, cables, watermains and connections. Wherever possible these must be located before work begins. WVS 7400 Contract No. Project No. D732 Planning Unit EWS	INT
NOTE: No construction work to commence until land and servitude acquisitions have been completed Acquisitions completed: Date Engineer NORTH POI UNDERGROUND SERVICES CHECKED - SERVICE DATE SIGNATURE SIGNATURE S.W DRAINS - SEWERS - WATERMAINS - ELECTRIC CABLES - S.A.R CABLES - E.S.C CABLES - OIL PIPE LINE - NOTE: Only underground services affected by new construction shown. Care must be taken during excavations for road foundations, trenches etc., to avoid damage to undergroud services such as sewers, drains, cables, watermains and connections. Wherever possible these must be located before work begins. WXS 7400 Contract No. - D732 Project No. -	INT
NOTE: No construction work to commence until land and servitude acquisitions have been completed Acquisitions completed: Date Engineer NORTH PO. UNDERGROUND SERVICES CHECKED – SERVICE DATE SIGNATURE S.W DRAINS Image: Completed: Image: Completed: Image: Completed: Image: Completed: SERVICE DATE SIGNATURE SIGNATURE S.W DRAINS Image: Commence of the second services allows and the second services allows and the second services allows and the services such as severs, drains, cables, watermains and connections Wherever possible these must be located before work begins. Image: Commence of the second services allows and connections wherever possible these must be located before work begins. VVS 7400 Contract No. Image: Commence of the second services allows and connections wherever possible these must be located before work begins. Project No. D732 Planning Unit EWS Project Title THANDOKUHLE RESERVO COMPARTMENT 1 CONSTRUCTION OF A 3ML REINFORCE COMPARTMENT 1	
NOTE: No construction work to commence until land and servitude acquisitions have been completed Acquisitions completed: Date Engineer NORTH PO UNDERGROUND SERVICES CHECKED - SERVICE DATE SIGNATURE - S.W DRAINS Image: Commence of the state of th	
NOTE: No construction work to commence until land and servitude acquisitions have been completed Acquisitions completed: Date Engineer NORTH PO UNDERGROUND SERVICES CHECKED – SERVICE DATE SIGNATURE S.W DRAINS DATE SIGNATURE SEWERS MATERMAINS TELKOM CABLES E ELECTRIC CABLES SENTICE DATE SIGNATURE S.A.R CABLES SE SE SE ELECTRIC CABLES SE SE SE OIL PIPE LINE NOTE: Only underground services affected by new construction shown. Care must be taken during excavations for road foundations, therever possible these must be located before work begins. WS 7400 Contract No. D732 Project No. D732 Planning Unit EWS Project Title THANDOKUHLE RESERVO COMPARTMENT 1 CONSTRUCTION OF A 3ML REINFORCY CONCRETE RESERVOIR, 150mm Ø STEEL INLET, 300mm Ø STE OUTLET PIPELINES AND ASSOCIATE WORKS	
NOTE: No construction work to commence until land and servitude acquisitions have been completed Acquisitions completed: Date Engineer NORTH PO UNDERGROUND SERVICES CHECKED – SERVICE DATE SIGNATURE S. W DRAINS SEWERS SEWERS SEWERS WATERMAINS TELKOM CABLES SEE SEC CABLES ELECTRIC CABLES SAR CABLES SEE SEE S. A. R CABLES SEE SEE SEE S. C CABLES SEE SEE SEE OIL PIPE LINE NOTE: Only underground services affected by new construction scheme. Care must be taken during excavations for road foundations, trenches etc., to avoid damage to underground services such as sewers, drains, cables, watermains and connections. Wherever possible these must be located before work begins. VWS 7400 Contract No. Project No. D732 Planning Unit EWS Project Title THANDOKUHLE RESERVO COMPARTMENT 1 CONSTRUCTION OF A 3ML REINFORC CONCRETE RESERVOIR, 150mm Ø STEEL INLET, 300mm Ø STE OUTLET PIPELINES AND ASSOCIATE WORKS Drawing Title	
NOTE: No construction work to commence until land and servitude acquisitions have been completed Acquisitions completed: Date Engineer NORTH PO UNDERGROUND SERVICES CHECKED – SERVICE DATE SIGNATURE S.W DRAINS DATE SIGNATURE SEWERS MATERMAINS TELKOM CABLES E ELECTRIC CABLES SENTICE DATE SIGNATURE S.A.R CABLES SE SE SE ELECTRIC CABLES SE SE SE OIL PIPE LINE NOTE: Only underground services affected by new construction shown. Care must be taken during excavations for road foundations, therever possible these must be located before work begins. WS 7400 Contract No. D732 Project No. D732 Planning Unit EWS Project Title THANDOKUHLE RESERVO COMPARTMENT 1 CONSTRUCTION OF A 3ML REINFORCY CONCRETE RESERVOIR, 150mm Ø STEEL INLET, 300mm Ø STE OUTLET PIPELINES AND ASSOCIATE WORKS	
NOTE: No construction work to commence until land and servitude acquisitions have been completed Acquisitions completed: Acquisitions completed: NORTH PO Date Engineer NORTH PO UNDERGROUND SERVICES CHECKED - SERVICE DATE SIGNATURE S.W DRAINS SEWERS SEWERS SEWERS SEWERS SEWERS WATERMAINS TELKOM CABLES EECTRIC CABLES SESC	
NOTE: No construction work to commence until land and servitude acquisitions have been completed Acquisitions completed: Acquisitions completed: NORTH PO UNDERGROUND SERVICES CHECKED - SERVICE DATE SIGNATURE S.W DRAINS SERVICE DATE SIGNATURE S.W DRAINS SERVICE DATE SIGNATURE SEWERS WATERMAINS SEVERS Severes WATERMAINS SEVERS Severes Severes WATERMAINS SEVERS Severes Severes SAR CABLES Severes Severes Severes Solar CABLES Severes Severes Severes NOTE: Only underground services affected by new construction shown. Care must be taken during excavations for road foundations, trenewer possible these must be located before work begins. Severes Vortract No. D732 Project No. D732 Project No. D732 Project Title THANDOKUHLE RESERVOO COMPARTMENT 1 CONSTRUCTION OF A 3ML REINFORCY CONCRETE RESERVOIR, 150mm Ø STEEL INLET, 300mm Ø STEE OUTLET PIPELINES AND ASSOCIATE WORKS Drawing Title STANDARD ASSOCIATED DETAILS Scales : As Shown Stale Shown	
NOTE: No construction work to commence until land and servitude acquisitions have been completed Acquisitions completed: Acquisitions completed: NORTH PO Date Engineer NORTH PO UNDERGROUND SERVICES CHECKED – SERVICE DATE SIGNATURE S.W DRAINS SEWERS SEWERS SEWERS SEWERS WATERMAINS TELKOM CABLES EECTRIC CABLES SEEC CABLES <td< td=""><td></td></td<>	
NOTE: No construction work to commence until land and servitude acquisitions completed: NORTH PO Date Engineer NORTH PO UNDERGROUND SERVICES CHECKED - SERVICE SIGNATURE S.W DRAINS Image: Checked - SERVICE SIGNATURE S.W DRAINS Image: Checked - SERVICE SIGNATURE SEWERS Image: Checked - SERVICE SIGNATURE NOTE: Only underground services affected by new construction shown. Care must be taken during exceavations for road foundations.trenches etc., to avoid damage to underground services such as sewers/drains.cables, weitermins and connections.Wherever possible these must be located before work begins. VC D732 Project No. D732 Project No. D732 Project Title ThANDOKUHLE RESERVO CONCRETE RESERVOIR, 150mm Ø STEEL INLET, 300mm Ø STE OUTLET PIPELINES AND ASSOCIATE WORKS	
NOTE No construction work to commence until land and servitude acquisitions completed: NORTH PO Date Engineer NORTH PO UNDERGROUND SERVICES CHECKED SERVICE DATE SIGNATURE SIW DRAINS Image: Checked in the second in the seco	
NOTE: No construction work to commence until land and servitude acquisitions completed: NORTH PO Date Engineer NORTH PO UNDERGROUND SERVICES CHECKED - SERVICE SIGNATURE S.W DRAINS Image: Checked - SERVICE SIGNATURE S.W DRAINS Image: Checked - SERVICE SIGNATURE SEWERS Image: Checked - SERVICE SIGNATURE NOTE: Only underground services affected by new construction shown. Care must be taken during exceavations for road foundations.trenches etc., to avoid damage to underground services such as sewers/drains.cables, weitermins and connections.Wherever possible these must be located before work begins. VC D732 Project No. D732 Project No. D732 Project Title ThANDOKUHLE RESERVO CONCRETE RESERVOIR, 150mm Ø STEEL INLET, 300mm Ø STE OUTLET PIPELINES AND ASSOCIATE WORKS	

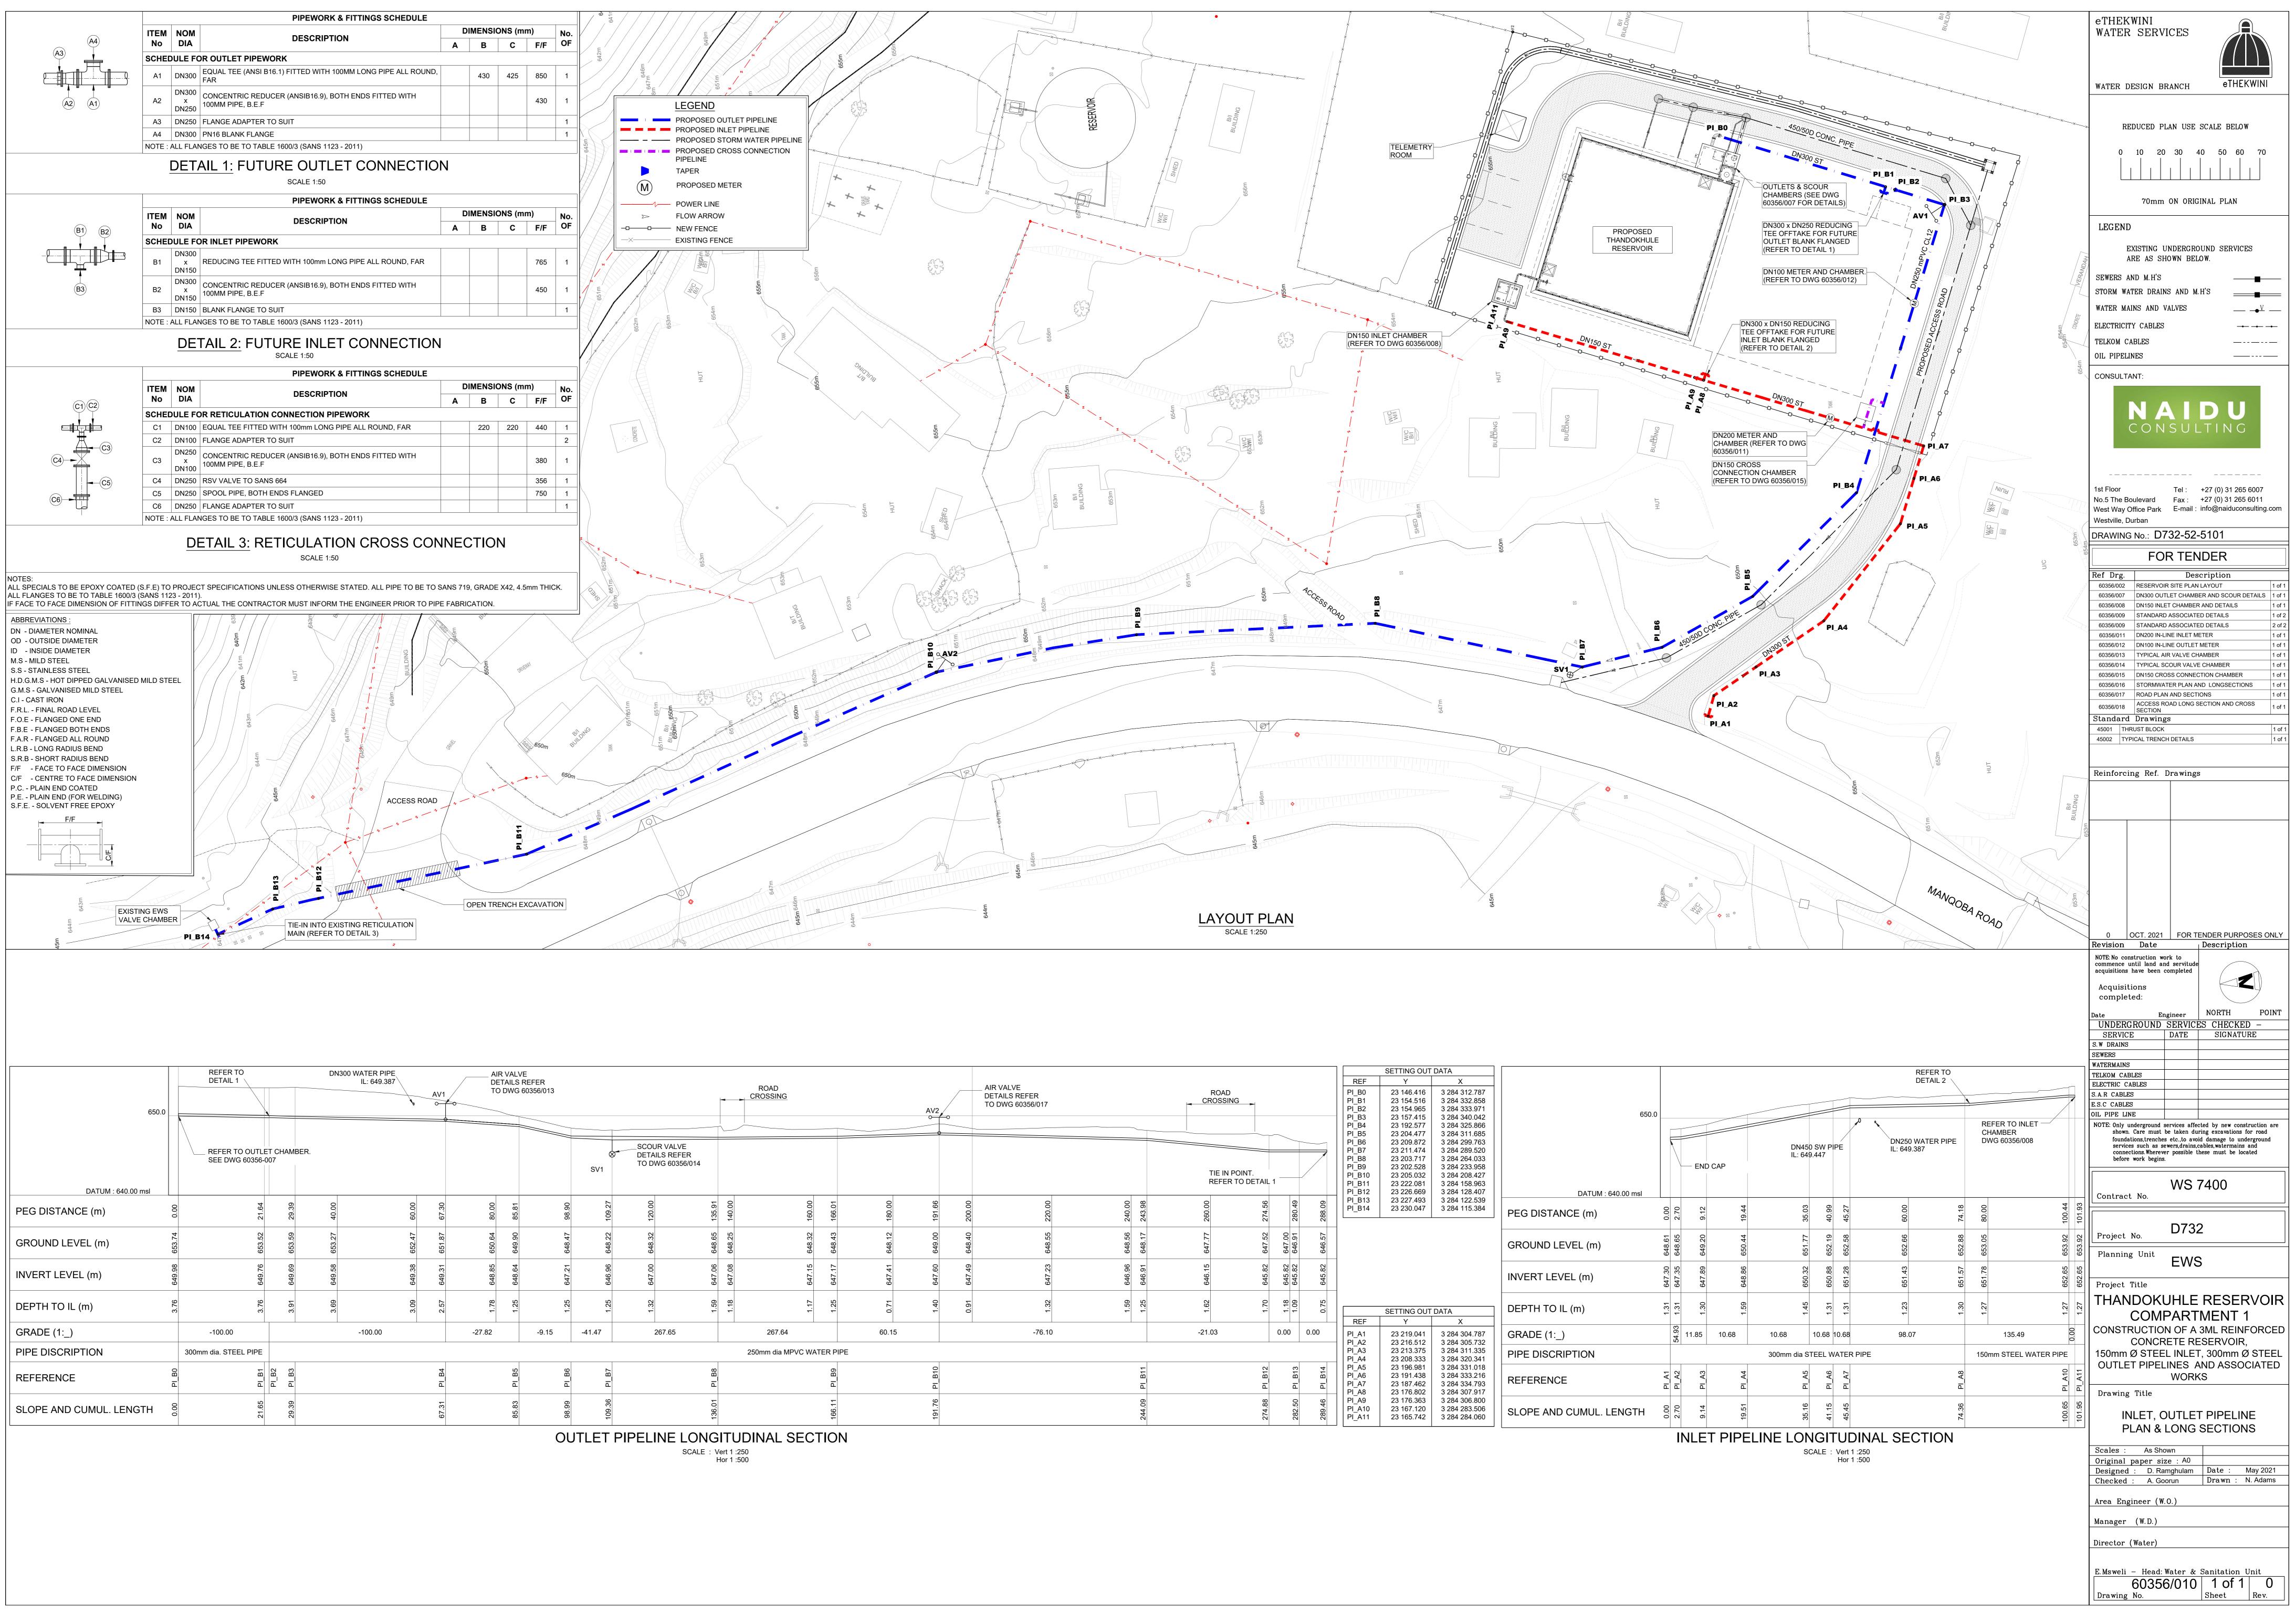

] [SETTING OUT	DATA								
				REF	Y	Х								
AD SSING				PI_B0 PI_B1 PI_B2 PI_B3	23 146.416 23 154.516 23 154.965 23 157.415	3 284 312.787 3 284 332.858 3 284 333.971 3 284 340.042	650.0							
IN POINT. ER TO DETAIL	1			PI_B4 PI_B5 PI_B6 PI_B7 PI_B8 PI_B9 PI_B10 PI_B11 PI_B12	23 192.577 23 204.477 23 209.872 23 211.474 23 203.717 23 202.528 23 205.032 23 222.081 23 226.669	3 284 325.866 3 284 311.685 3 284 299.763 3 284 289.520 3 284 264.033 3 284 233.958 3 284 208.427 3 284 158.963 3 284 128.407	DATUM : 640.00 msl			END	0 CAP		50 SW P 49.447	IPE
9		ဂ	ര	PI_B13	23 227.493	3 284 122.539	DATOM: 640.00 INSI						+	
274.56		280.49	288.09	PI_B14	23 230.047	3 284 115.384	PEG DISTANCE (m)	00.0	2.70	9.12	19.44	35 03 35	40.99	AE 07
647.52	647.00	646.91	646.57	_			GROUND LEVEL (m)	648.61	648.65	649.20	650.44	651 77	652.19	<u>с</u> ер <u>с</u> в
645.82	645.82	645.82	645.82				INVERT LEVEL (m)	647.30		647.89	648.86	650 30 650 30	650.88	<u>е</u> е1 од
1.70	1.18	1.09	0.75	REF	SETTING OUT	DATA X	DEPTH TO IL (m)	1.31		1.30	1.59	1 45	1.31	1 21
	0.00	כ	0.00	PI_A1 PI_A2	23 219.041 23 216.512	3 284 304.787 3 284 305.732	GRADE (1:_)		54.93	11.85	10.68	10.68	10.68	10.6
				PI_A3	23 213.375 23 208.333	3 284 311.335 3 284 320.341	PIPE DISCRIPTION					300mm dia S	STEEL W	VATE
PI_B12		PI_B13	Pl_B14	PI_A5 PI_A6 PI_A7 PI_A8	23 196.981 23 191.438 23 187.462 23 176.802	3 284 331.018 3 284 333.216 3 284 334.793 3 284 307.917	REFERENCE	PI A1		PI_A3	PI_A4		1 1	
274.88		282.50	289.46	PI_A9 PI_A10 PI_A11	23 176.363 23 167.120 23 165.742	3 284 306.800 3 284 283.506 3 284 284.060	SLOPE AND CUMUL. LENGTH	0.00	2.70	9.14	19.51	אד 16 אד 16	41.15	15 15
										NLE	T PIPE	LINE LOI د	NGIT	

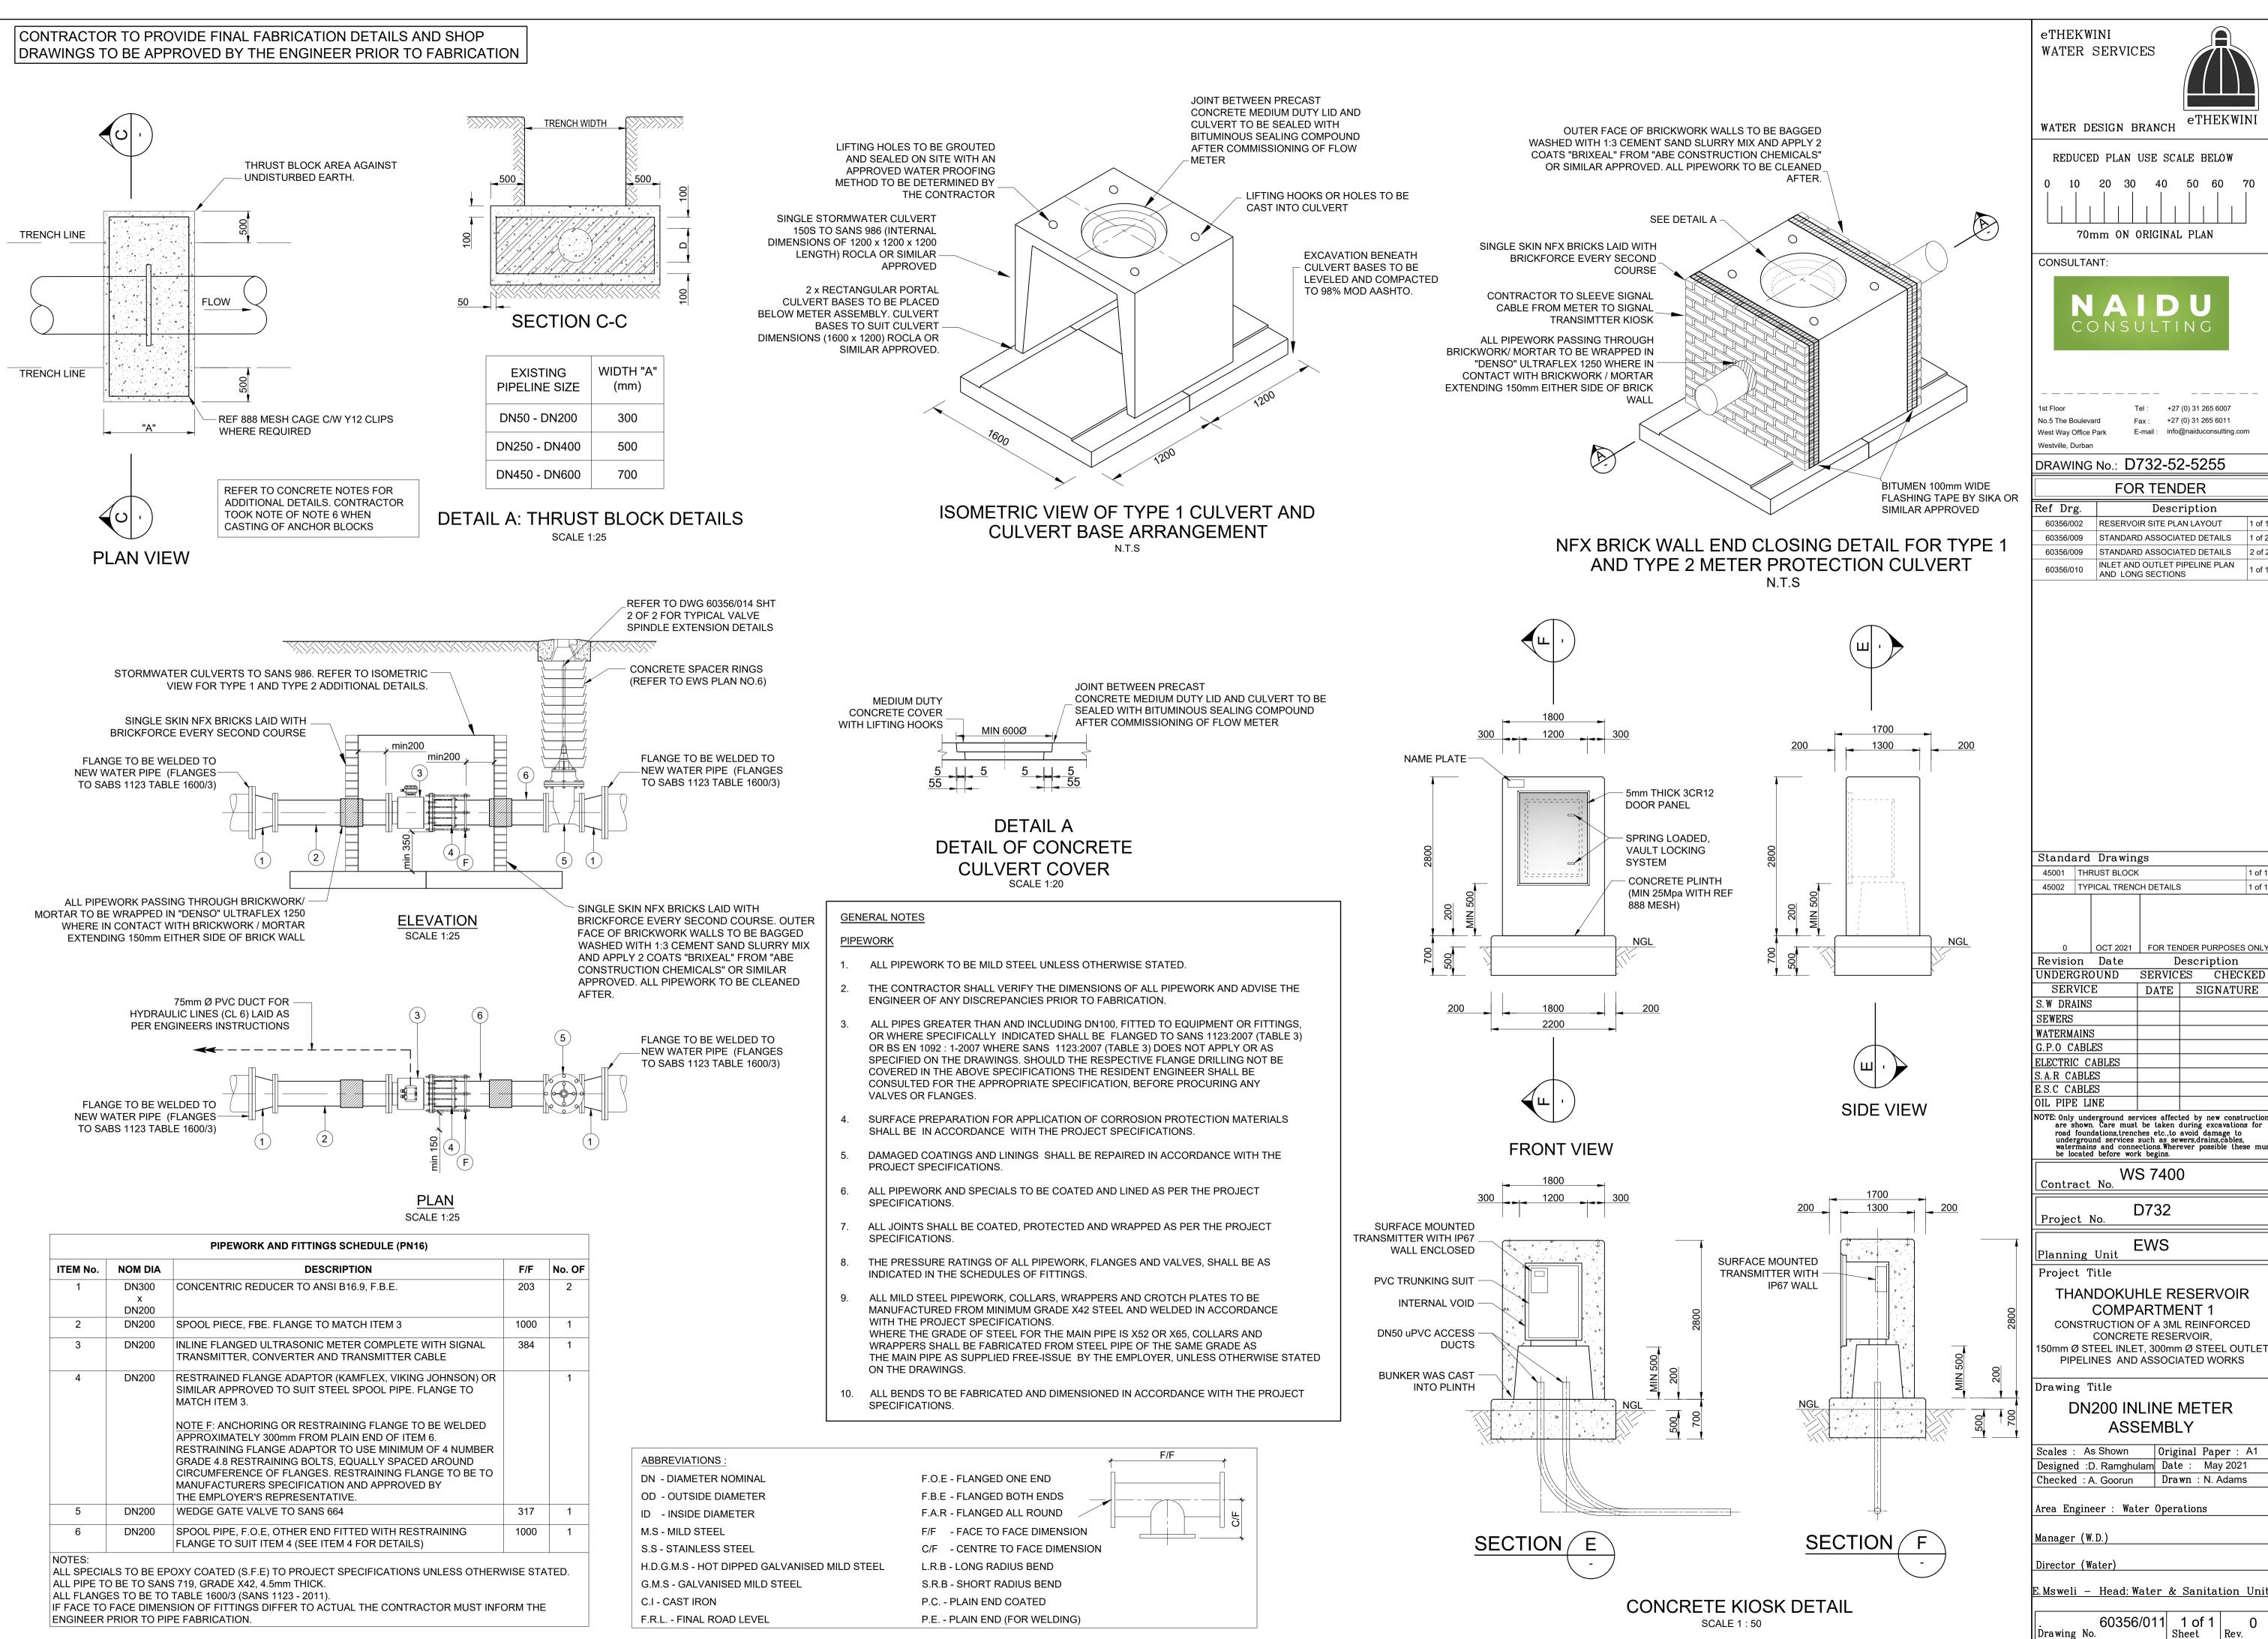

70


1 of 1

1 of


1 of 1


1 of 1

0

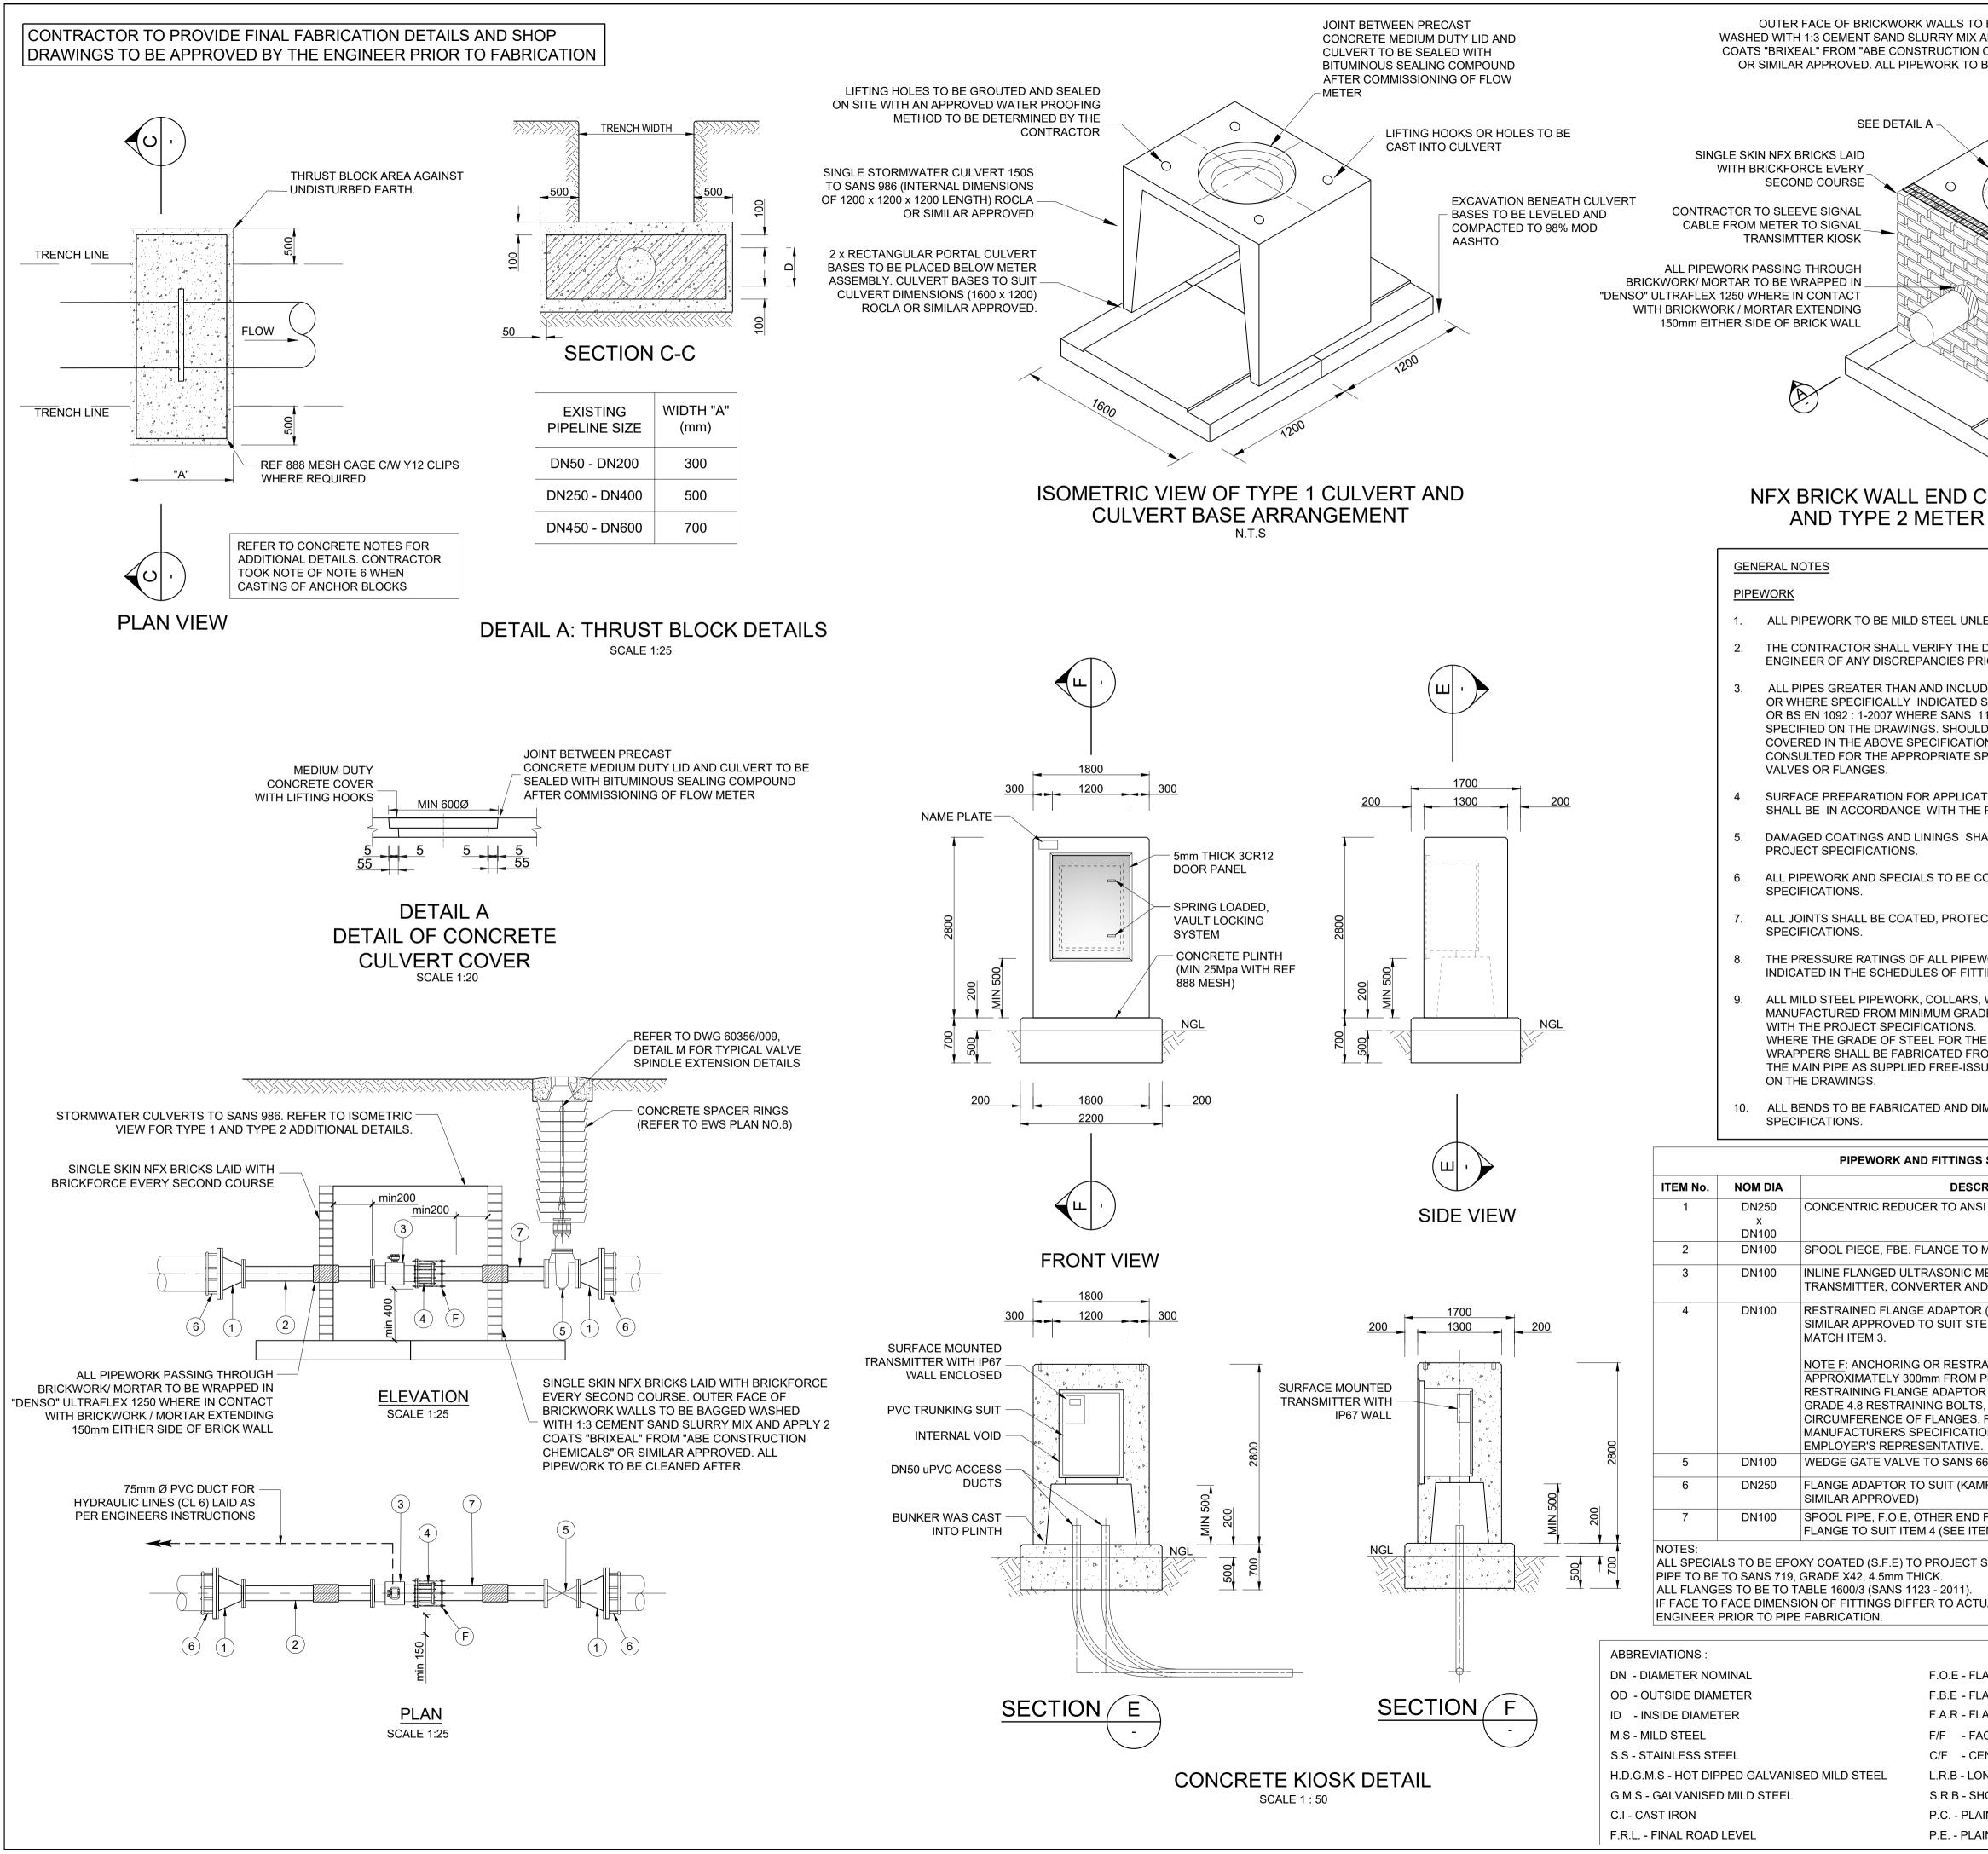



D BE BAGGED AND APPLY 2 CHEMICALS" BE CLEANED AFTER.		eTHEKWINI WATER SERVIC	ES
		WATER DESIGN BI	eTHEKWINI
	J.		JSE SCALE BELOW
		0 10 20 30	40 50 60 70
	\geq	CONSULTANT:	DU
BITUMEN 100n FLASHING TAF SIMILAR APPR	PE BY SIKA OR OVED	No.5 The Boulevard Fa	
R PROTECTION CULVE		DRAWING No.: D7	732-52-5256 R TENDER
		Ref Drg.	Description
LESS OTHERWISE STATED. DIMENSIONS OF ALL PIPEWORK AND AI RIOR TO FABRICATION.	DVISE THE	60356/009 STANDARE 60356/009 STANDARE 60356/010 INLET AND	R SITE PLAN LAYOUT1 of 10 ASSOCIATED DETAILS1 of 20 ASSOCIATED DETAILS2 of 20 UTLET PIPELINE PLAN1 of 10 SECTIONS1
DING DN100, FITTED TO EQUIPMENT OR SHALL BE FLANGED TO SANS 1123:2007 1123:2007 (TABLE 3) DOES NOT APPLY O D THE RESPECTIVE FLANGE DRILLING N DNS THE RESIDENT ENGINEER SHALL BI SPECIFICATION, BEFORE PROCURING AN	7 (TABLE 3) R AS NOT BE E		
TION OF CORROSION PROTECTION MATER PROJECT SPECIFICATIONS.	FERIALS		
IALL BE REPAIRED IN ACCORDANCE WIT	'H THE		
COATED AND LINED AS PER THE PROJEC	т		
CTED AND WRAPPED AS PER THE PRO	IECT		
WORK, FLANGES AND VALVES, SHALL BI TINGS.	EAS	Standard Drawing 45001 THRUST BLOCK	
, WRAPPERS AND CROTCH PLATES TO E DE X42 STEEL AND WELDED IN ACCORD		45002 TYPICAL TRENC	H DETAILS 1 of 1
E MAIN PIPE IS X52 OR X65, COLLARS AI OM STEEL PIPE OF THE SAME GRADE A			
UE BY THE EMPLOYER, UNLESS OTHER		0 OCT 2021 Revision Date UNDERGROUND	FOR TENDER PURPOSES ONLY Description SERVICES CHECKED
IMENSIONED IN ACCORDANCE WITH TH	E PROJECT	SERVICE S. W DRAINS SEWERS	DATE SIGNATURE
S SCHEDULE (PN16)		WATERMAINS G.P.O CABLES	
	//F No. OF 12 2	ELECTRIC CABLES S.A.R CABLES E.S.C CABLES	
MATCH ITEM 3 10	000 1	OIL PIPE LINE	vices affected by new construction
	50 1	are shown. Care must road foundations,trench underground services s watermains and conne- be located before work	vices affected by new construction be taken during excavations for use etc., to avoid damage to such as sewers, drains, cables, ctions. Wherever possible these must begins.
R (KAMFLEX, VIKING JOHNSON) OR EEL SPOOL PIPE. FLANGE TO	1		5 7400
AINING FLANGE TO BE WELDED PLAIN END OF ITEM 7. R TO USE MINIMUM OF 4 NUMBER S, EQUALLY SPACED AROUND RESTRAINING FLANGE TO BE TO		Project No.	0732 EWS
ON AND APPROVED BY THE		Project Title THANDOKUH	ILE RESERVOIR
64 2 MFLEX, VIKING JOHNSON OR	54 1 2	COMPA	RTMENT 1
FITTED WITH RESTRAINING 10	000 1	CONCRET 150mm Ø STEEL INLET	F A 3ML REINFORCED E RESERVOIR, 7, 300mm Ø STEEL OUTLET ASSOCIATED WORKS
EM 4 FOR DETAILS) SPECIFICATIONS UNLESS OTHERWISE		Drawing Title	
UAL THE CONTRACTOR MUST INFORM 1		DN100 INI	LINE METER EMBLY
]	Scales : As Shown	Original Paper : A1 am Date : May 2021
	Π	Designed :D. Ramghul Checked : A. Goorun	am Date : May 2021 Drawn : N. Adams
ANGED BOTH ENDS		Area Engineer : Wate	er Operations
ANGED ALL ROUND		Manager (W.D.)	
ENTRE TO FACE DIMENSION		Director (Water)	
ONG RADIUS BEND HORT RADIUS BEND		E.Msweli - Head:Wa	ater & Sanitation Unit
AIN END COATED		60356/0	012 1 of 1 0
IN END (FOR WELDING)		Drawing No.	Sheet Rev.

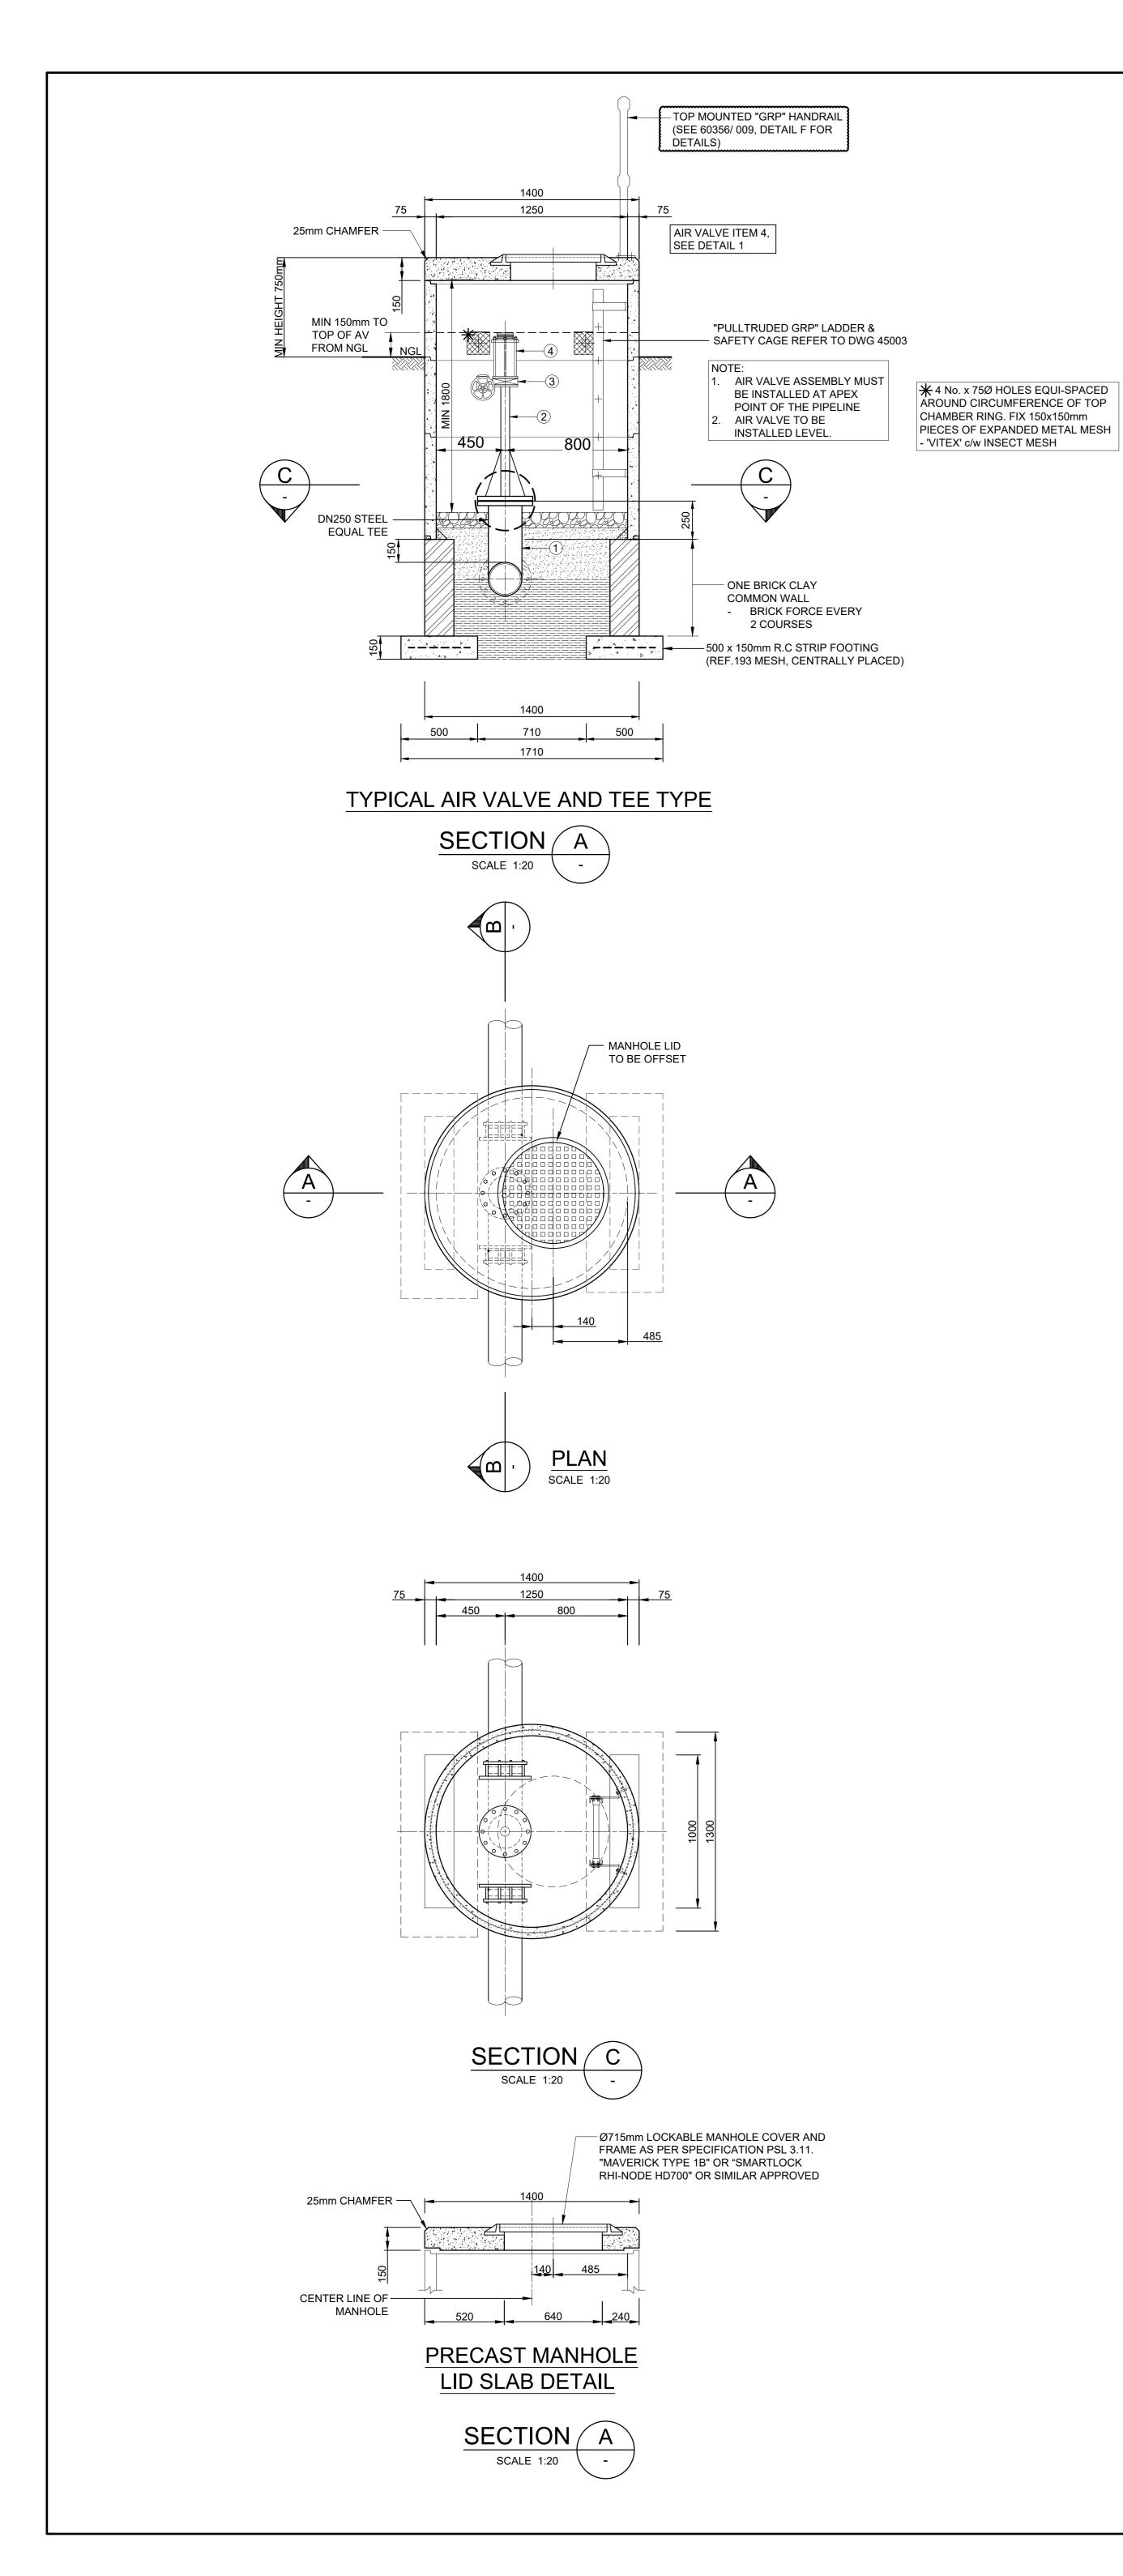


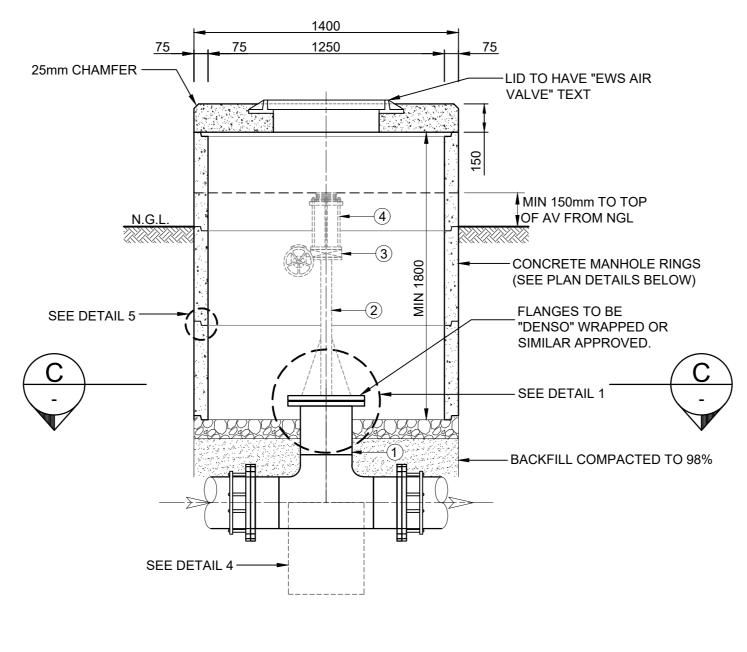


SECTION B -

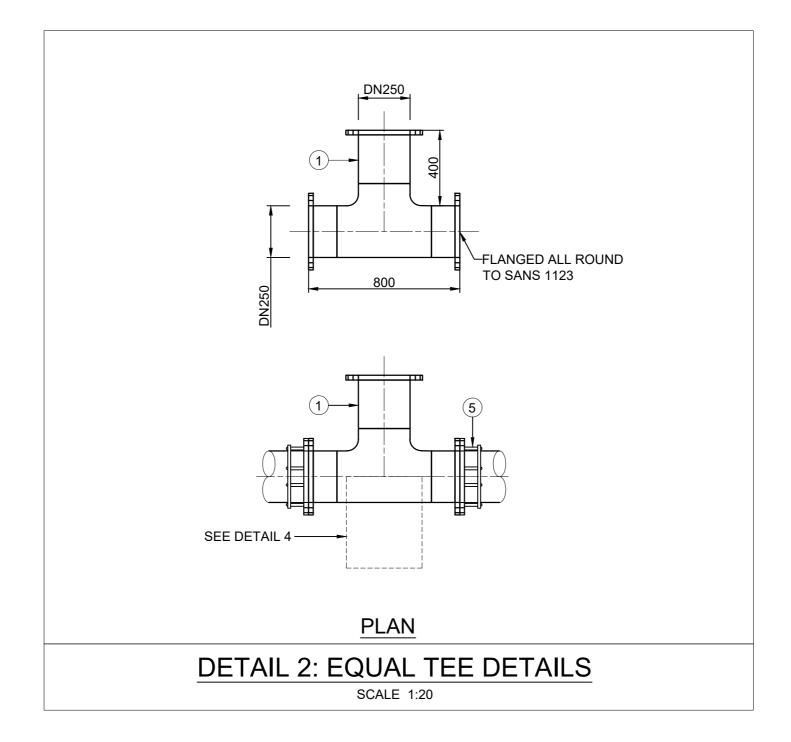

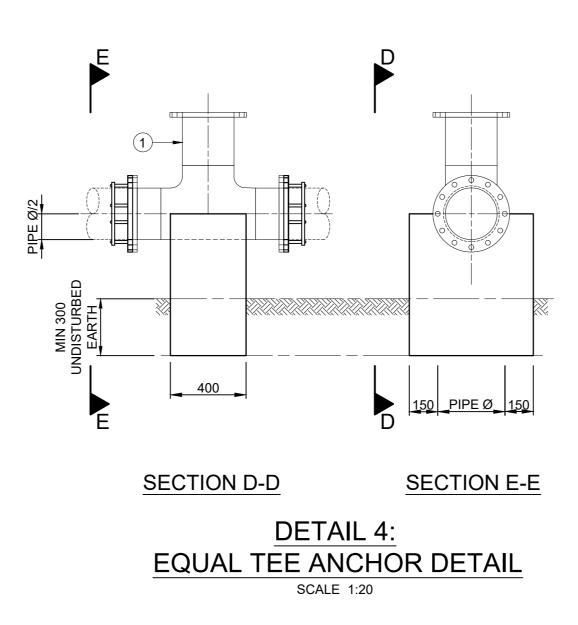

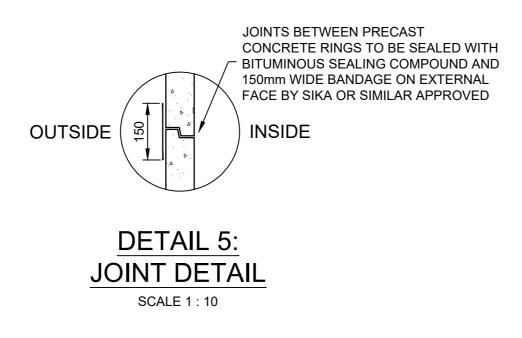

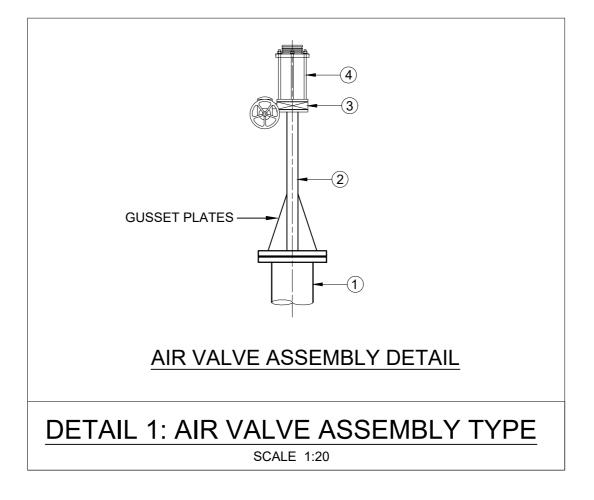

F/F	-
<mark>≺ C</mark> ►	
TEE	

ITEM NO	NOM DIA	DESCRIPTION	NO. O
1	DN250	EQUAL TEE (ANSI B16.9) F.A.R. TO PROJECT SPECIFICATIONS SANS 1123, PRESSURE RATING AS PER TABLE 1	1
2	DN50	SPOOL PIECE, B.E.F WITH DN250 FLANGE ON ONE END AND DN50 FLANGE ON OTHER END. LENGTH TO SUIT SITE CONDITIONS (APPROX = 1000mm). 3*5mm THICK GUSSET PLATES (300mm HIGH x 85mm WIDE) TO BE WELDED TO BOTH PIPE AND DN250 FLANGE AT 120deg SPACES	1
3	DN50	EPOXY COATED AND LINED WAFER BUTTERFLY VALVE TO BS 5155/ EN593 AND EWS PARTICULAR SPECIFICATION COMPLETE WITH HAND WHEEL. REFER TO TABLE 1 FOR VALVE PRESSURE RATING.	1
4	DN50	"VARIANT MODEL LX" OR SIMILAR APPROVED DOUBLE ACTING ANTI-THEFT FLANGED AIR VALVE. BASE FLANGE TO 304 SS COMPLETE WITH INSULATING BOLT, WASHER AND NUT KIT FOR DISSIMILAR METALS BETWEEN FLANGES WITH A MINIMUM AIR INTAKE @ 3.5m VACUUM OF 190 I/s. NOTE: AIR VALVES TO BE ABLE TO BE MAINTAINED UNDER FULL PIPELINE WORKING PRESSURE WITHOUT THE NEED TO ISOLATE THE AIR VALVE.	1
5	DN250	FLANGE ADPATER TO SUIT. (KAMFLEX, VIKING JOHNSON OS SIMILAR APPROVED.	2


TABLE 1: AIR VALVE PRESSURE RATINGS						
ITEM NO.	FITTING REF	SELECTED FITTING RATING (PN)	AIR VALVE ASSEMBLY SIZE	CHAINAGE (m)		
1	AV 1	16	DN50	67.3		
2	AV 2	16	DN50	191.66		

TABLE 2:TOTAL AIR VALVE CHAMBER QUANTITIES					
DN	PN	QUANTITIES			
DN50	16	2			
	TOTAL AIR VALVES	2			

ADDITIONAL NOTES:


- ALL SPECIALS TO BE COATED AND LINED TO PROJECT SPECIFICATIONS UNLESS OTHERWISE STATED. 2. ALL PIPES LESS THAN OR EQUAL TO DN150 TO BE FABRICATED IN ACCORDANCE WITH SANS 62 - 1 (MEDIUM CLASS).
- 3. ALL MILD STEEL PIPEWORK AND FITTINGS GREATER THAN DN150 TO BE FABRICATED IN ACCORDANCE TO API 5L GRADE X42 OR SANS 719 GRADE C, THICKNESS AS SHOWN.
- 4. ALL SPECIALS TO BE EPOXY COATED (S.F.E) TO PROJECT SPECIFICATIONS UNLESS OTHERWISE STATED. ALL PIPE TO BE TO SANS 719, GRADE X42, 4.5mm THICK. DIMENSIONS OF ALL PIPES, FITTINGS AND SPECIALS SCHEDULED ABOVE ARE FOR INFORMATION PURPOSES ONLY AND TO
- BE VERIFIED ON SITE PRIOR TO MANUFACTURE. ALL PIPEWORK, VALVES AND FITTING SHALL COMPLY WITH PROJECT SPECIFICATION.
- PRESSURE RATINGS OF VALVES AND FITTINGS TO SUIT PRESSURE RATING INDICATED IN SCHEDULE. THE USE OF PROPRIETARY NAMES IN NO WAY INDICATES PREFERENCE FOR A PARTICULAR PRODUCT. RATHER, THIS USAGE IS TO ILLUSTRATE TO THE TENDERER THE TYPE AND NATURE OF PRODUCT SOUGHT BY EWS. EQUIPMENT WITH SIMILAR MATERIALS OF CONSTRUCTIONS, SIMILAR FUNCTIONALITY AND NO MATERIAL DEVIATION FROM THE PRODUCT USED FOR
- ILLUSTRATIVE PURPOSES WILL BE DEEMED TO BE "SIMILAR APPROVED". 9. ALL RESTRAINED TYPE FITTINGS & COUPLINGS SHALL COMPLY TO PROJECT SPECIFICATIONS.

PIPEWORK NOTES:	eTHEKWINI WATER SERVICES
 ALL MATERIAL TO BE SANS APPROVED. ALL FLANGES AND RESTRAINING FLANGES SHALL BE RATED AND DRILLED TO SANS 1123, TABLE AS SPECIFIED IN 	
PIPEWORK AND FITTINGS SCHEDULE. 2.1. THRUST PUDDLE FLANGES SHALL MATCH PIPEWORK	
 FLANGES TO SANS 1123 AND SHALL BE UNDRILLED. 2.2. WHERE PUDDLE PLATES ARE REQUIRED OVER THRUST PUDDLE FLANGES, THE THICKNESS AND OUTSIDE DIAMETER SHALL BE SPECIFIED IN PIPEWORK AND FITTINGS SCHEDULE. 	WATER DESIGN BRANCH eTHEKWINI
3. ALL BOLTS AND TIE BOLTS TO BE GRADE 4.8. BOLTS, NUTS AND WASHERS SHALL BE HOT DIPPED GALVANISED TO SANS	REDUCED PLAN USE SCALE BELOW
 121/ ISO 1461, WITH A HEAVY FILM THICKNESS OF 85 ±10 MICRON. 4. ALL MILD STEEL ITEMS (APART FROM PIPING/PIPE FITTINGS) 	0 10 20 30 40 50 60 70
 TO BE HEAVY DUTY HOT DIPPED GALVANIZED TO ISO 1461 AND SANS 121, WITH A HEAVY FILM THICKNESS OF 85 ±10 MICRO INTERNALLY AND EXTERNALLY APPLIED. 5. ALL PIPE FITTINGS TO BE CHECKED ON SITE, ANY 	70mm ON ORIGINAL PLAN
DISCREPANCIES TO BE REPORTED TO THE ENGINEER PRIOR TO MANUFACTURE. 6. ALL PIPES LESS THAN OR EQUAL TO DN150 TO BE	CONSULTANT:
FABRICATED IN ACCORDANCE WITH SANS 62 - 1 (MEDIUM CLASS) UNLESS OTHERWISE SPECIFIED.	
 ALL MILD STEEL PIPEWORK AND FITTINGS GREATER THAN DN150 TO BE FABRICATED IN ACCORDANCE WITH SANS 719 EDITION 3.1 2008 AND WELDED IN ACCORDANCE WITH API 1104. PIPEWORK GRADE AND WALL THICKNESS SHALL MATCH SCHEDULE OF FITTINGS TABLE. 	NAIDU CONSULTING
 ALL STAINLESS STEEL PIPE AND FITTINGS TO BE GRADE 316L AND WALL THICKNESS SHALL MATCH SCHEDULE OF FITTINGS TABLE. 	
 ENSURE THERE IS AT LEAST 75mm COVER BETWEEN THE REINFORCING BARS AND PUDDLE FLANGE/ PLATE. DESTRAINING FLANCE ADAPTOR LISE MINIMUM 4. No CRADE 	1st Floor Tel : +27 (0) 31 265 6007
10. RESTRAINING FLANGE ADAPTOR USE MINIMUM 4. № GRADE 4.8 RESTRAINING BOLTS, EQUALLY SPACED AROUND CIRCUMFERENCE OF FLANGES UNLESS OTHER SHOWN	No.5 The BoulevardFax : +27 (0) 31 265 6011West Way Office ParkE-mail : info@naiduconsulting.comWestville, Durban
UNDER ITEM DESCRIPTION. <u>NOTE:</u> ALL THE BOLTS FROM THE FLANGE ON THE VALVE ADJACENT TO A RESTRAINING FLANGE TO BE TAKEN THROUGH TO THE RESTRAINING	DRAWING No.: D732-52-5257
FLANGE WITH NUTS AND WASHERS BOTH SIDES OF RESTRAINING FLANGE. 11. ALL BURIED FLANGES TO BE CATHODICALLY BONDED	FOR TENDER
INSULATED CABLE THERMALLY WELDED TO PIPE AS DIRECTED BY CATHODIC SPECIALIST .	Ref Drg. Description 60356/002 RESERVOIR SITE PLAN LAYOUT 1 of 1
COATING AND LINING NOTES:	60356/009STANDARD ASSOCIATED DETAILS1 of 260356/009STANDARD ASSOCIATED DETAILS2 of 260356/010INLET AND OUTLET PIPELINE PLAN AND LONG OF STANDARD1 of 1
 SURFACE PREPARATION - GRIT BLAST TO SIS 05 590, GRADE SA 2.5. SFE LINING/COATING TO MILD STEEL PIPING GREATER THAN 	SECTIONS
DN200 (UNLESS OTHERWISE STATED): TO EWS PARTICULAR SPECIFICATION FOR 164mm TO 2230mm DIAMETER STEEL PIPE,SPECIALS,COATINGS AND LININGS WITH A MINIMUM DFT	
OF 406micron, INTERNALLY AND EXTERNALLY APPLIED. 19. MILD STEEL PIPING LESS THAN OR EQUAL TO DN200 TO BE	
HEAVY DUTY HOT-DIPPED GALVANISED (UNLESS OTHERWISE STATED): TO ISO 1461 AND SANS 121, WITH A HEAVY FILM THICKNESS OF 85 ±10 MICRON, INTERNALLY AND EXTERNALLY	
APPLIED. 19.1. PIPE BELOW GROUND, AFTER GALVANISING TO BE WRAPPED WITH 'DENSO ULTRAFLEX 1250 TAPE' OR	
SIMILAR APPROVED. 19.2. PIPE ABOVE GROUND, AFTER GALVANISING TO BE	
WRAPPED WITH 'ACRYLIC PIPELINE TAPE' OR SIMILAR APPROVED. 20. CEMENT MORTAR LINING TO EWS SPECIFICATIONS - STEEL	
PIPE, LINING & COATING. 21. DAMAGED COATING AND LININGS TO BE REPAIRED IN	
ACCORDANCE WITH PROJECT SPECIFICATION 22. DAMAGED H.D.G. COATING TO BE REPAIRED WITH 'GALV-O-PATCH' OR SIMILAR APPROVED PRODUCT.	
23. ALL BURIED FLANGES, BOLTS AND FLEXIBLE COUPLINGS TO BE WRAPPED WITH 'DENSO SYSTEM' OR SIMILAR APPROVED	
IN ACCORDANCE TO PROJECT SPECIFICATIONS. 24. ALL PIPEWORK THROUGH CHAMBER WALLS TO BE WRAPPED WITH 'DENSO ULTRAFLEX 1250 TAPE' OR SIMILAR APPROVED	
ON EACH SIDE OF THE PUDDLE FLANGE. THIS WRAPPING TO EXTEND 150mm BEYOND THE FACE OF THE WALL EACH SIDE. PUDDLE FLANGE/ PLATE NOT TO BE WRAPPED.	
NB: 25. ALL CERTIFICATES SHALL BE PROVIDED FOR <u>ALL MATERIALS</u>	
26. ALL WELDING TO BE API 1104.27. ALL WELDS TO BE 100% TESTED.	
"DENSO" OR SIMILAR APPROVED NOTES:	
ALL BURIED FLANGES, BOLTS AND FLEXIBLE COUPLINGS TO BE WRAPPED WITH 'DENSO SYSTEM' OR SIMILAR APPROVED AS DESCRIBED BELOW:	Standard Drawings 45001 THRUST BLOCK 1 of 1
1. <u>"MASTIC" PROFILING PUTTY OR SIMILAR APPROVED</u> NARROW STRIPS CUT FROM "DENSO PROFILING PUTTY" OR SIMILAR	45002TYPICAL TRENCH DETAILS1 of 145005GRP ACCESS LADDER: PLAN, SECTION & DETAILS1 of 245005GRP ACCESS LADDER: PLAN, SECTION & DETAILS2 of 2
APPROVED SHALL BE APPLIED TO THE JOINT TO ACHIEVE A SMOOTH PROFILE WITH A 50mm SPLAYED FILLET BEING FORMED AT THE JOINT/PIPE INTERFACE. CARE SHALL BE TAKEN, PARTICULARLY AT BOLTS, TO AVOID	68184 WIRE MESH SECURITY FENCE & GATE 1 of 1
THE FORMATION OF AIR POCKETS. "DENSO PETROLATUM TAPE" OR SIMILAI APPROVED SHALL THEN BE APPLIED (MASTIC SIDE DOWN) TO THE JOINT UNTIL THE JOINT IS COMPLETELY ENVELOPED.	
2. <u>"DENSO" WRAPPING OR SIMILAR APPROVED.</u>	0 OCT 2021 FOR TENDER PURPOSES ONLY Revision Date Description NOTE: No construction work to Image: Construction work to
THE ENDS OF THE BLANKET SHALL BE BOUND TO THE BARREL OF THE PIPE ON EACH END WITH 100mm WIDE "DENSO PETROLATUM TAPE" OR SIMILAR APPROVED. "DENSO PETROLATUM TAPE" OR SIMILAR APPROVED	commence until land and servitude acquisitions have been completed
OVERLAPS SHALL BE 50mm AND SHALL EXTEND 100mm ONTO THE BLANKET AND 150mm ONTO THE PIPE BARREL. ALL EXPOSED BOLTS ON FLEXIBLE COUPLINGS AND FLANGES ADAPTORS TO BE WRAPPED.	Acquisitions completed:
3. <u>FINAL POLYETHYLENE WRAPPING</u>	DateEngineerNORTHPOINTUNDERGROUNDSERVICESCHECKED-
THE ENTIRE JOINT SHALL BE WRAPPED WITH 350 MICRON POLYETHYLENE SHEETING WHICH SHALL END 400mm BEYOND THE JOINT. THE PROTECTIVE SHEETING SHALL BE SECURED TO THE PIPE BARREL AND ALONG THE SEAN	
WITH 50mm WIDE "DENSO ADHESIVE TAPE" OR SIMILAR APPROVED.	WATERMAINS TELKOM CABLES
	ELECTRIC CABLES S.A.R CABLES ES.C. CABLES
	E.S.C CABLES OIL PIPE LINE NOTE: Only underground services affected by new construction are
	shown. Care must be taken during excavations for road foundations,trenches etc.,to avoid damage to underground services such as sewers,drains,cables,watermains and connections.Wherever possible these must be located
	before work begins.
	WS 7400 Contract No.
	Project No. D732
	Planning Unit EWS
	Project Title
	THANDOKUHLE RESERVOIR COMPARTMENT 1
	CONSTRUCTION OF A 3ML REINFORCED CONCRETE RESERVOIR,
	150mm Ø STEEL INLET, 300mm Ø STEEL OUTLET PIPELINES AND ASSOCIATED
	WORKS Drawing Title
	TYPICAL AIR VALVE DETAILS
	Scales : As Shown
	Original paper size : A0Designed :D. RamghulamDate :May 2021Checked :A. GoorunDrawn :N. Adams
	Area Engineer (W.O.)
	Manager (W.D.)
	Director (Water)
	E.Msweli – Head: Water & Sanitation Unit
	60356/013 1 of 1 0 Drawing No. Rev.

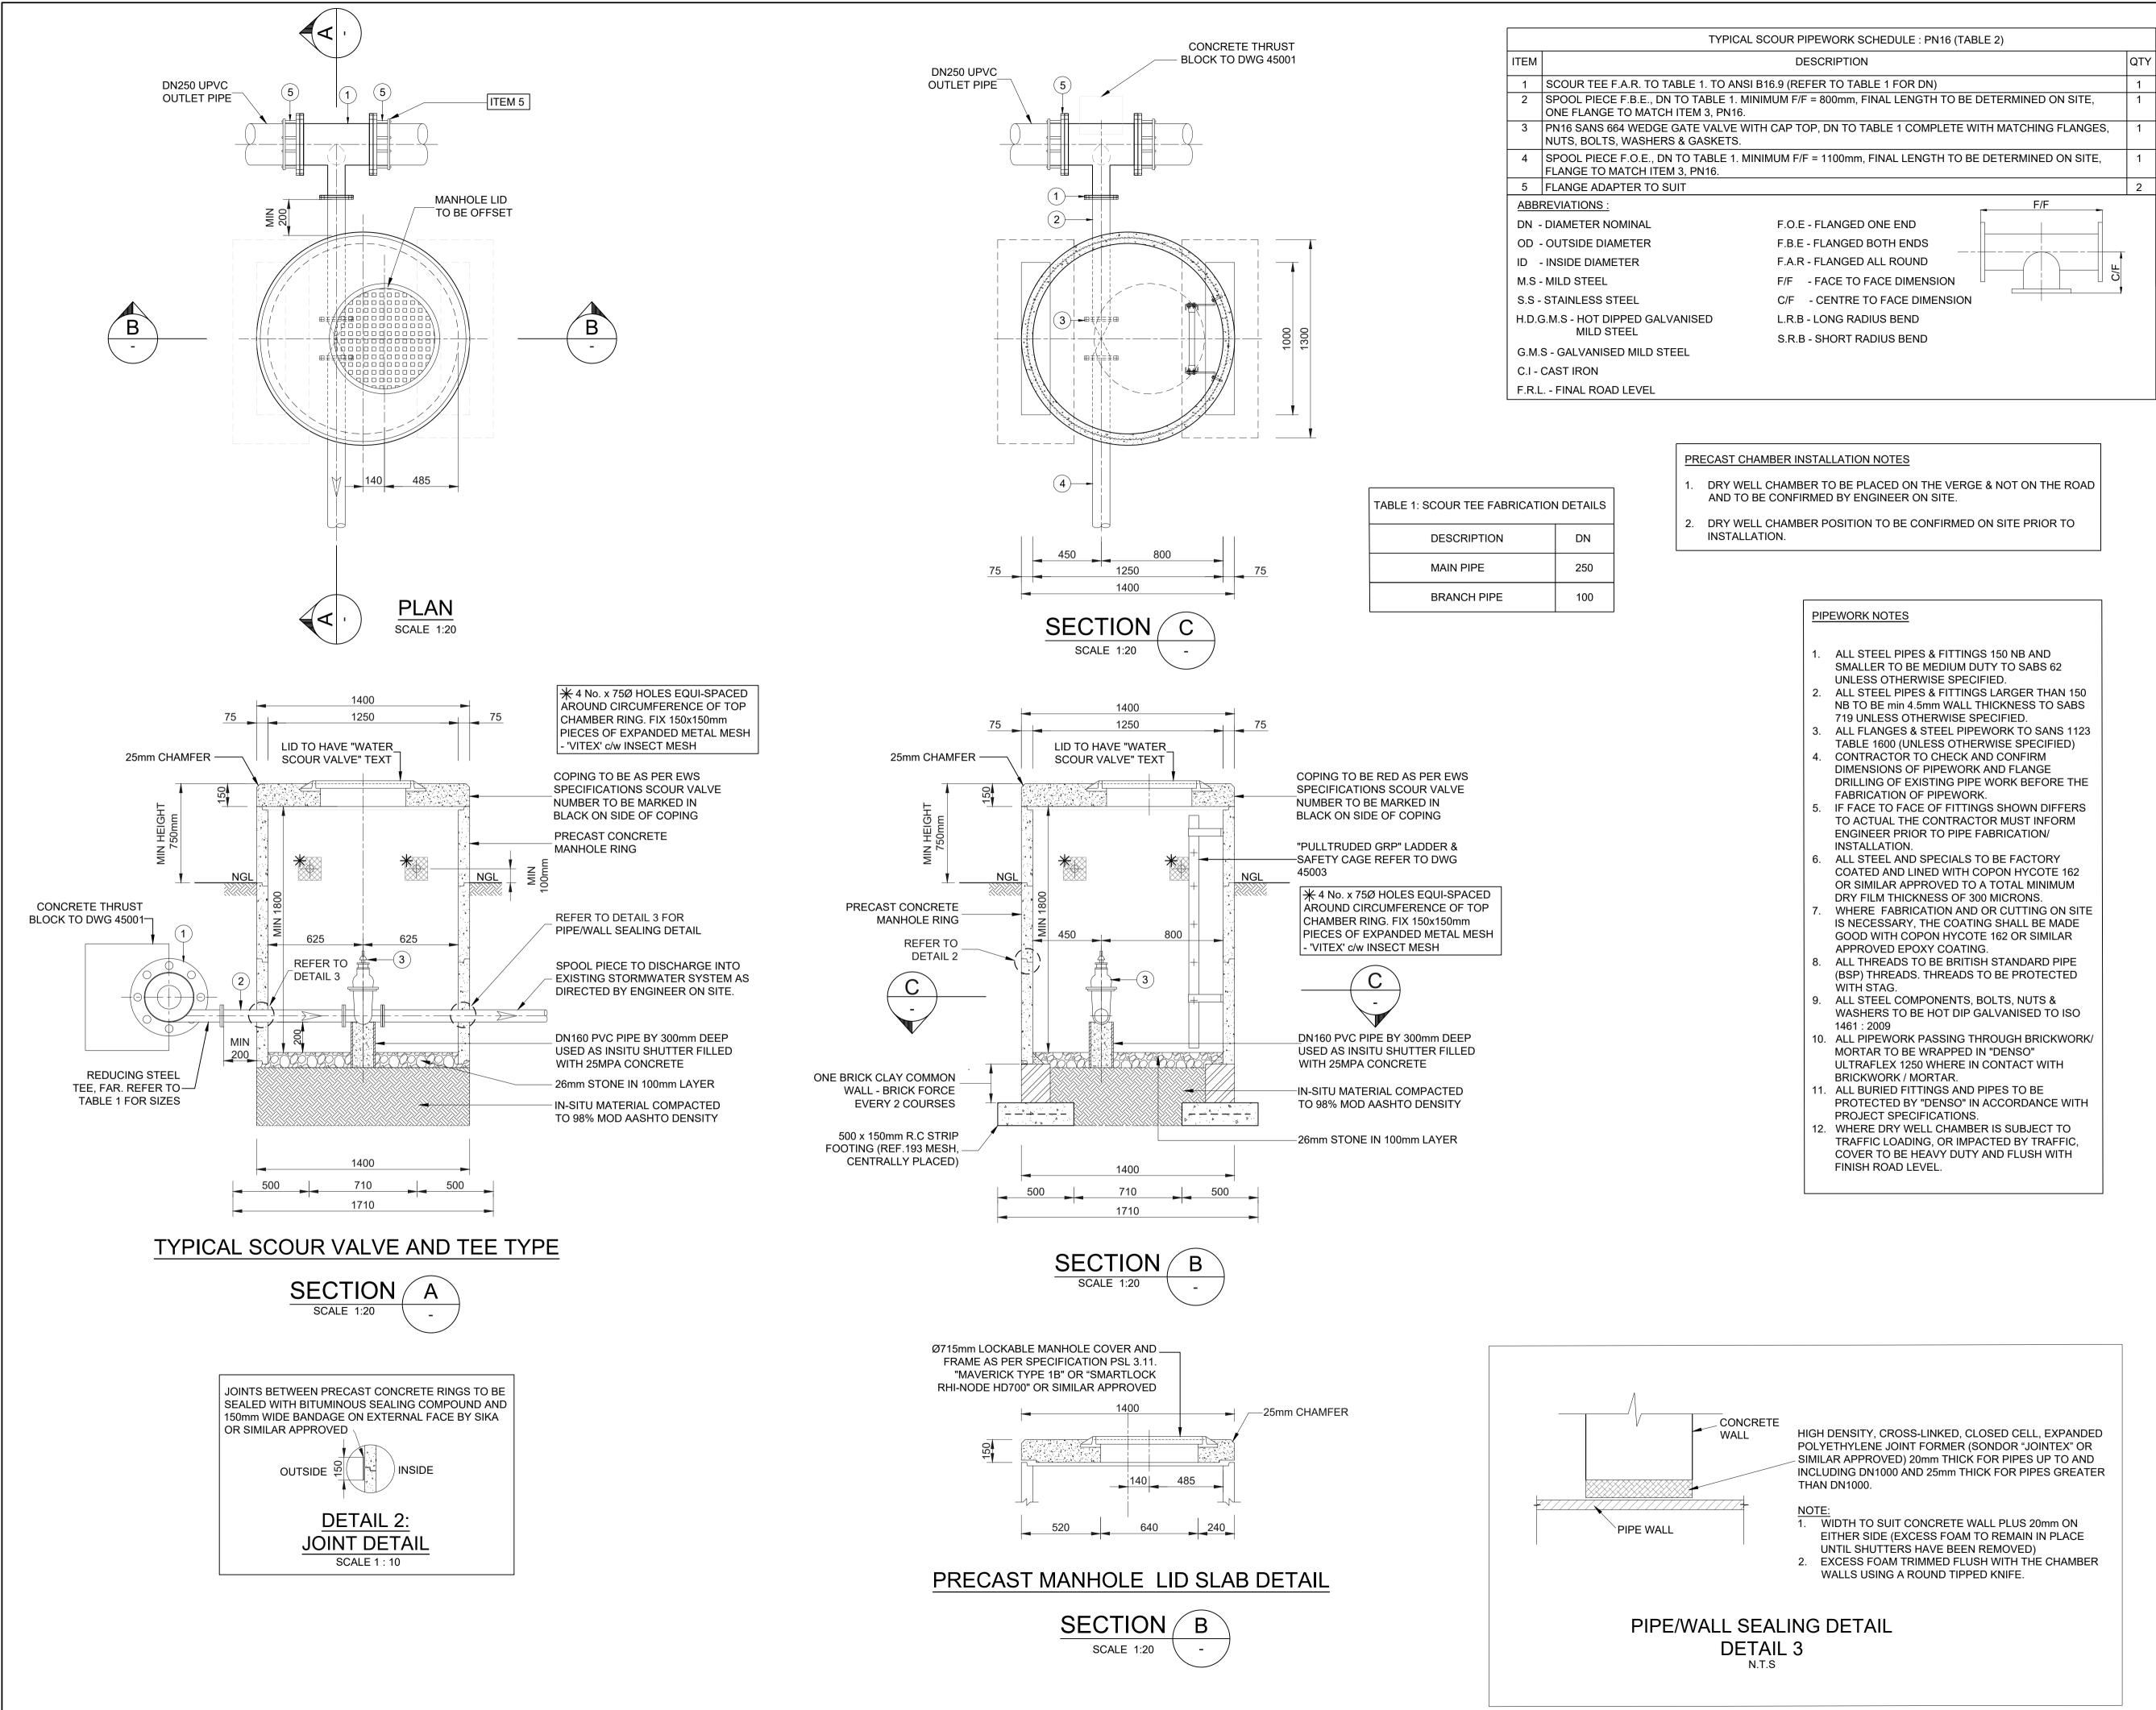

, CROSS-LINKED, CLOSED CELL, EXPANDED E JOINT FORMER (SONDOR "JOINTEX" OR OVED) 20mm THICK FOR PIPES UP TO AND 1000 AND 25mm THICK FOR PIPES GREATER	
SUIT CONCRETE WALL PLUS 20mm ON DE (EXCESS FOAM TO REMAIN IN PLACE ITTERS HAVE BEEN REMOVED) OAM TRIMMED FLUSH WITH THE CHAMBER ING A ROUND TIPPED KNIFE.	
IL	

	KWIN R Se	I RVICES			\ \
WATEF	R DESI	GN BRAN	eTH	EKWIN	I
			SCALE BE		
	0 20		40 50	60 7(0
CONSU	LTANT:			_	
		A I N S U L	D U TING		
1st Floor No.5 The B West Way (Westville, D	Office Park Purban	Fax : E-mail :	info@naiducon	6011	
DRAWIN	NG No.:		52-5258 ENDER		
Ref Dr	-	Ι	Descriptio		
60356/002 60356/009	9 STAN	DARD ASSO	PLAN LAYOUT	.S ŕ	1 of 1 1 of 2
60356/009 60356/010			CIATED DETAIL		2 of 2 1 of 1
Standa 45001 45002 45005 45005 68184	THRUST TYPICAL GRP ACC DETAILS GRP ACC DETAILS	L TRENCH DE CESS LADDE G CESS LADDE	TAILS R: PLAN, SECT R: PLAN, SECT TY FENCE & GA	ion & . ion & .	1 of 1 1 of 1 1 of 2 2 of 2 1 of 1
45001 45002 45005 45005	THRUST TYPICAL GRP AC DETAILS GRP AC DETAILS WIRE MI	ESH SECURI	R: PLAN, SECT R: PLAN, SECT	ION & . ION & . ION & .	1 of 1 1 of 2 2 of 2
45001 45002 45005 68184	THRUST TYPICAL GRP ACI DETAILS GRP ACI DETAILS WIRE MI	2021 FOR TE	R: PLAN, SECT R: PLAN, SECT TY FENCE & GA NDER PURPOS Descript	ION &	1 of 1 1 of 2 2 of 2
45001 45002 45005 68184 0	THRUST TYPICAL GRP ACI DETAILS GRP ACI DETAILS WIRE MI	2021 FOR TE te No.	R: PLAN, SECT R: PLAN, SECT TY FENCE & GA NDER PURPOS Descript	ION &	1 of 1 1 of 2 2 of 2
45001 45002 45005 68184 0 Revisio	THRUST TYPICAL GRP ACI DETAILS GRP ACI DETAILS WIRE MI	2021 FOR TE te No.	R: PLAN, SECT R: PLAN, SECT TY FENCE & GA NDER PURPOS Descript	ION &	1 of 1 1 of 2 2 of 2
45001 45002 45005 68184 0 Revisio	THRUST TYPICAL GRP ACC DETAILS GRP ACC DETAILS WIRE ME OCT. OCT.	2021 FOR TE te No.	R: PLAN, SECT R: PLAN, SECT TY FENCE & GA NDER PURPOS Descript	ION &	1 of 1 1 of 2 2 of 2
45001 45002 45005 68184 0 Revisio NC Pr Contra Planni Project THAI CONST COI STEEI	THRUST TYPICAL GRP ACI DETAILS GRP ACI DETAILS WIRE MI OCT. ON DAT OCT. OCT. OCT. OCT. OCT. OCT. OCT. OCT	2021 FOR TE CESS LADDE CESS	R: PLAN, SECT R: PLAN, SECT TY FENCE & GA NDER PURPOS Descript 732 7400	ION & I ION & I SES ONLY ion	I of 1 1 of 2 2 of 2 1 of 1 I of 1 I of 1 I of 1 I of 1 I of 2 2 of 2 I of 1 I of 2 I of 2 I of 2 I of 2 I of 1 I of 2 I of 2 I of 2 I of 1 I of 2 I of 2 I of 1 I of 2 I of 2 I of 1 I of 2 I of 2 I of 1 I of 2 I of 2
45001 45002 45005 68184 0 Revisio NC Pr Contra Planni Project THAI CONST COI STEEI	THRUST TYPICAL GRP ACI DETAILS GRP ACI DETAILS WIRE MR oject	ESH SECURIT	R: PLAN, SECT R: PLAN, SECT TY FENCE & GA Descript 732 7400 EWS ERESE TMENT A 3ML REII RVOIR, 15 D STEEL	ION & I ION & I SES ONLY ion	I of 1 1 of 2 2 of 2 1 of 1 I of 1 I of 1 I of 1 I of 1 I of 2 2 of 2 I of 1 I of 2 I of 2 I of 2 I of 2 I of 1 I of 2 I of 2 I of 2 I of 1 I of 2 I of 2 I of 1 I of 2 I of 2 I of 1 I of 2 I of 2 I of 1 I of 2 I of 2
45001 45002 45005 68184 0 Revisio NC Pr Contra Planni Project THAI CONST COI STEEI PIPEL	THRUST TYPICAL GRP ACI DETAILS GRP ACI DETAILS WIRE MI oject act No ng Un coject Act No ng Un coject NDO COI RUCT NCRET LINES g Title	ESH SECURIT	R: PLAN, SECT R: PLAN, SECT TY FENCE & GA Descript 732 7400 EWS ERESE TMENT A 3ML REII RVOIR, 15 D STEEL	ION & I ION &	I of 1 1 of 2 2 of 2 1 of 1 I of 1 I of 1 I of 1 I of 1 I of 2 2 of 2 I of 1 I of 2 I of 2 I of 2 I of 2 I of 1 I of 2 I of 2 I of 2 I of 1 I of 2 I of 2 I of 1 I of 2 I of 2 I of 1 I of 2 I of 2 I of 1 I of 2 I of 2
45001 45002 45005 68184 0 Revisio NC Pr Contra Planni Project THAI CONST COI STEEI PIPEL Drawin	THRUST TYPICAL GRP ACI DETAILS GRP ACI DETAILS WIRE MI oject act No act No act No act No col col col col col col col col col co	ESH SECURIT 2021 FOR TE CESS LADDE CESS	R: PLAN, SECT R: PLAN, SECT TY FENCE & GA NDER PURPOS Descript 732 7400 ERESE TMENT A 3ML REII RVOIR, 15 MENT A 3ML REII RVOIR A 3ML REII RVOIR A 3ML REII RVOIR A 3ML REII RVOIR A 3ML REII RVOIR A 3ML REII A 3ML		I of 1 1 of 2 2 of 2 1 of 1 I of 1 I of 1 I of 1 ED ET S
45001 45002 45005 68184 0 Revisio NC Pr Contra Planni Project THAI Project THAI Drawin	THRUST TYPICAL GRP ACI DETAILS GRP ACI DETAILS WIRE MI oject act No act No act No act No coject Act	ESH SECURIT 2021 FOR TE CESS LADDE CESS	R: PLAN, SECT R: PLAN, SECT TY FENCE & GA NDER PURPOS Descript 732 7400 EWS ERESE TMENT A 3ML REII RVOIR, 15 0 STEEL SOCIATED SOCIATED		I of 1 1 of 2 2 of 2 1 of 1 I of 1 I of 1 I of 1 ED ET S
45001 45002 45005 68184 0 Revisio NC Pr Contra Planni Project THAI Project THAI Drawin	THRUST TYPICAL GRP ACI DETAILS GRP ACI DETAILS WIRE MI oject act No act No act No act No coject Act	ESH SECURIT 2021 FOR TE CESS LADDE CESS LADE CESS	R: PLAN, SECT R: PLAN, SECT TY FENCE & GA NDER PURPOS Descript 732 7400 ERESE TMENT A 3ML REII RVOIR, 15 MOSTEEL SOCIATED SCOU ETAIL Original Pa Date : Ma Drawn : N.		I of 1 1 of 2 2 of 2 1 of 1 I of 1 I of 1 I of 1 ED ET S
45001 45002 45005 68184 0 Revisio NC Pr Contra Planni Project THAI Project THAI Drawin	THRUST TYPICAL GRP ACI DETAILS GRP ACI DETAILS WIRE MI oject act No act No act No act No col col col col col col col col col co	ESH SECURIT	R: PLAN, SECT R: PLAN, SECT TY FENCE & GA NDER PURPOS Descript 732 7400 ERESE TMENT A 3ML REII RVOIR, 15 MOSTEEL SOCIATED SCOU ETAIL Original Pa Date : Ma Drawn : N.		I of 1 1 of 2 2 of 2 1 of 1 I of 1 I of 1 I of 1 ED ET S
45001 45005 45005 68184 0 Revisio NC Pr Contra Planni Project THAI CONST COI STEEI PIPEL Drawin	THRUST TYPICAL GRP ACI DETAILS GRP ACI DETAILS WIRE MI oject act No act No act No act No ng Un c Title NDO COI FRUCT NCRET LINES g Title STYP VAL c As Sh d : D. Ri d : D. Ri d : A. Gi agineer c (W. D.) c (Wate b COI c (Wate	ESH SECURIT 2021 FOR TE CESS LADDE CESS LADE CESS	R: PLAN, SECT R: PLAN, SECT TY FENCE & GA Descript 732 7400 EWS ERESE TMENT A 3ML REII RVOIR, 15 0 STEEL SOCIATED SOCIATED Original Pa Date : Ma Drawn : N.	ESONLY ION & I ION & I ION & I SESONLY ION & I SESONLY ION & I SESONLY ION & I SESONLY ION & I SESONLY ION & I ION	I of 1 1 of 2 2 of 2 1 of 1 I of 1 I of 1 I of 1 ED ET S

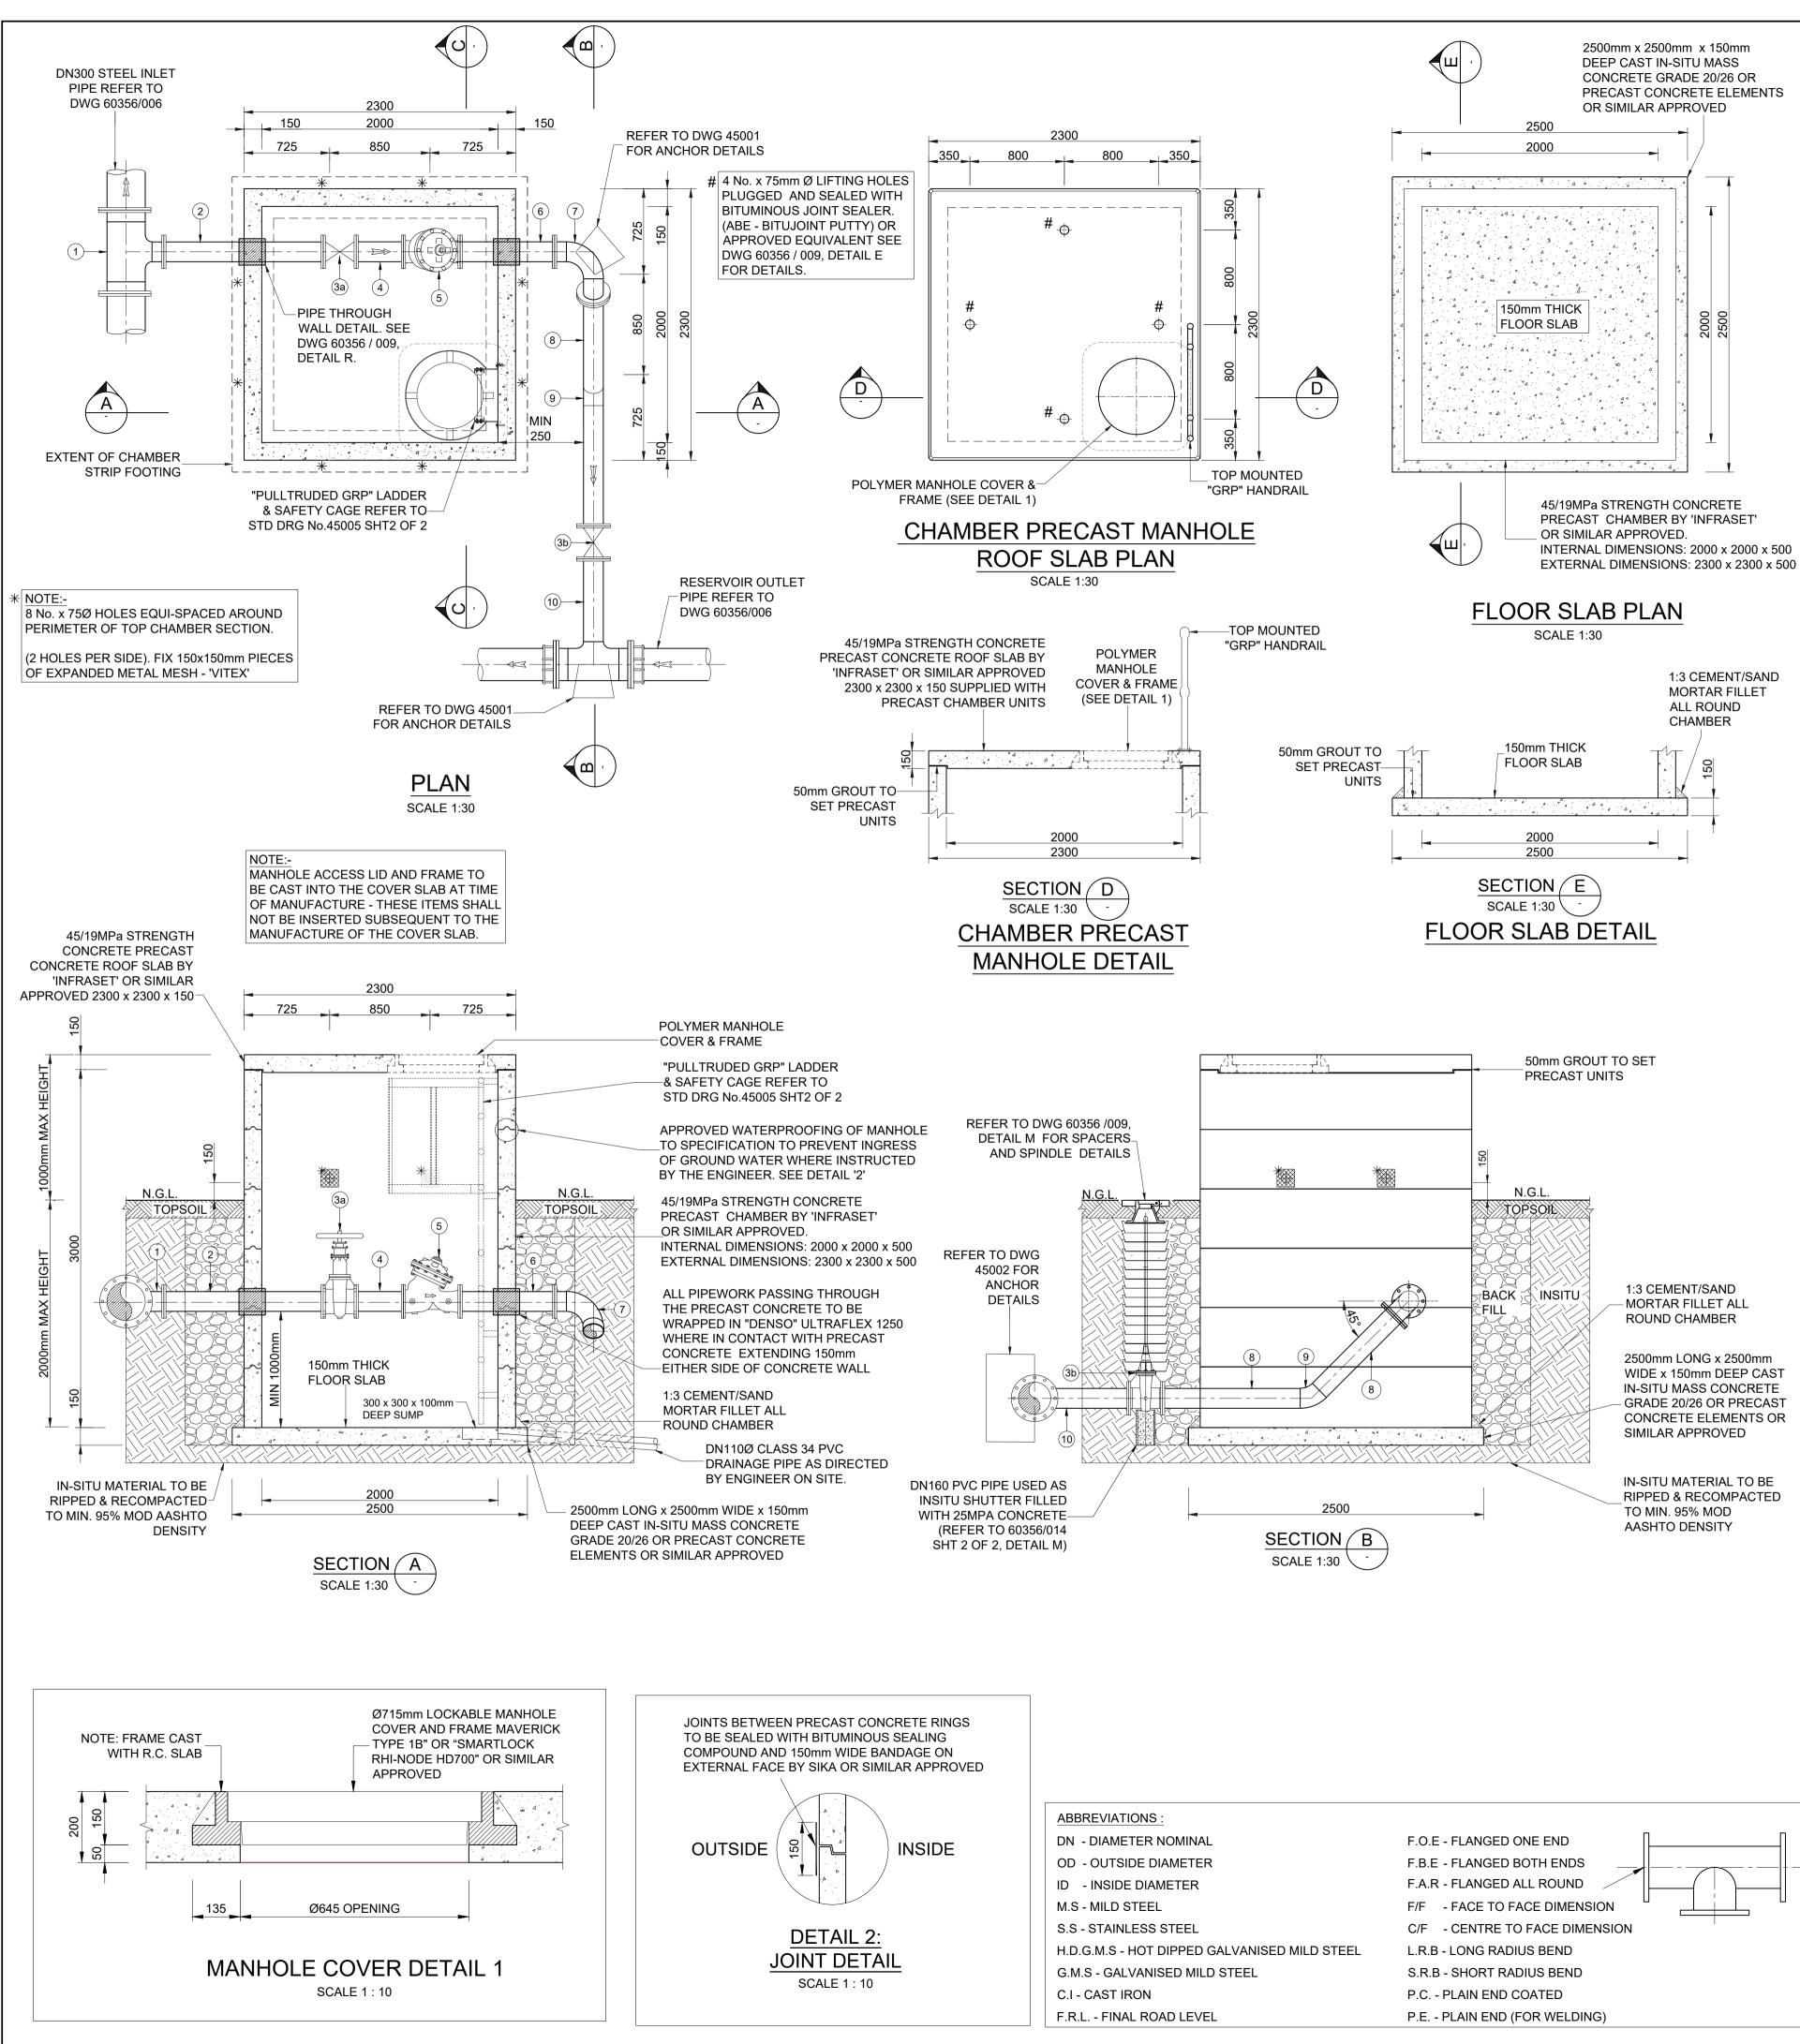

PIPEWORK NOTES:

ALL MATERIAL TO BE SANS APPROVED.

- ALL FLANGES AND RESTRAINING FLANGES SHALL BE RATED AND DRILLED TO SANS 1123, TABLE AS SPECIFIED
- IN PIPEWORK AND FITTINGS SCHEDULE ALL BOLTS AND TIE BOLTS TO BE GRADE 4.8. BOLTS, NU AND WASHERS SHALL BE HOT DIPPED GALVANISED TO SANS 121/ ISO 1461, WITH A HEAVY FILM THICKNESS OF ±10 MICRON.
- ALL MILD STEEL ITEMS (APART FROM PIPING/PIPE FITTINGS) TO BE HEAVY DUTY HOT DIPPED GALVANIZED TO ISO 1461 AND SANS 121, WITH A HEAVY FILM THICKNESS OF 85 ±10 MICRO INTERNALLY AND EXTERNALLY APPLIED.
- ALL PIPE FITTINGS TO BE CHECKED ON SITE, ANY DISCREPANCIES TO BE REPORTED TO THE ENGINEER
- PRIOR TO MANUFACTURE. ALL PIPES LESS THAN OR EQUAL TO DN150 TO BE
- FABRICATED IN ACCORDANCE WITH SANS 62 1 (MEDIUN CLASS) UNLESS OTHERWISE SPECIFIED.
- ALL MILD STEEL PIPEWORK AND FITTINGS GREATER THA DN150 TO BE FABRICATED IN ACCORDANCE WITH SANS 719 EDITION 3.1 2008 AND WELDED IN ACCORDANCE WIT API 1104. PIPEWORK GRADE AND WALL THICKNESS SHAL MATCH SCHEDULE OF FITTINGS TABLE.
- ALL STAINLESS STEEL PIPE AND FITTINGS TO BE GRADE 316L AND WALL THICKNESS SHALL MATCH SCHEDULE OF FITTINGS TABLE.
- ENSURE THERE IS AT LEAST 75mm COVER BETWEEN THE REINFORCING BARS AND PUDDLE FLANGE/ PLATE.
- **RESTRAINING FLANGE ADAPTOR USE MINIMUM 4. No** GRADE 4.8 RESTRAINING BOLTS, EQUALLY SPACED AROUND CIRCUMFERENCE OF FLANGES UNLESS OTHE SHOWN UNDER ITEM DESCRIPTION. NOTE: ALL THE BOL FROM THE FLANGE ON THE VALVE ADJACENT TO A RESTRAINING FLANGE TO BE TAKEN THROUGH TO THE
- RESTRAINING FLANGE WITH NUTS AND WASHERS BOTH SIDES OF RESTRAINING FLANGE. ALL BURIED FLANGES TO BE CATHODICALLY BONDED INSULATED CABLE THERMALLY WELDED TO PIPE AS DIRECTED BY CATHODIC SPECIALIST .

COATING AND LINING NOTES:

- 17. SURFACE PREPARATION GRIT BLAST TO SIS 05 590. GRADE SA 2.5.
- 18. SFE LINING/COATING TO MILD STEEL PIPING GREATER THAN DN200 (UNLESS OTHERWISE STATED): TO ETHEKWINI WATER (EWS) PARTICULAR SPECIFICATION FOR 164mm TO 2230mm DIAMETER STEEL PIPE, SPECIALS, COATINGS AND LININGS WITH A MINIMUM DFT OF 406micron, INTERNALLY AND EXTERNALLY APPLIED.
- 19. MILD STEEL PIPING LESS THAN OR EQUAL TO DN200 TO HEAVY DUTY HOT-DIPPED GALVANISED (UNLESS OTHERWISE STATED): TO ISO 1461 AND SANS 121, WITH HEAVY FILM THICKNESS OF 85 ±10 MICRON, INTERNALLY AND EXTERNALLY APPLIED.
- 19.1. PIPE BELOW GROUND, AFTER GALVANISING TO BE WRAPPED WITH 'DENSO ULTRAFLEX 1250 TAPE' OR SIMILAR APPROVED.
- 19.2. PIPE ABOVE GROUND, AFTER GALVANISING TO BE WRAPPED WITH 'ACRYLIC PIPELINE TAPE' OR SIMILA APPROVED.
- 20. CEMENT MORTAR LINING TO ETHEKWINI WATER (EWS) SPECIFICATIONS - STEEL PIPE, LINING & COATING.
- 21. DAMAGED COATING AND LININGS TO BE REPAIRED IN ACCORDANCE WITH PROJECT SPECIFICATION
- 22. DAMAGED H.D.G. COATING TO BE REPAIRED WITH 'GALV-O-PATCH' OR SIMILAR APPROVED PRODUCT.
- 23. ALL BURIED FLANGES, BOLTS AND FLEXIBLE COUPLINGS TO BE WRAPPED WITH 'DENSO SYSTEM' OR SIMILAR APPROVED IN ACCORDANCE TO PROJECT SPECIFICATIONS.
- 24. ALL PIPEWORK THROUGH CHAMBER WALLS TO BE WRAPPED WITH 'DENSO ULTRAFLEX 1250 TAPE' OR SIMILAR APPROVED ON EACH SIDE OF THE PUDDLE FLANGE. THIS WRAPPING TO EXTEND 150mm BEYOND TI FACE OF THE WALL EACH SIDE. PUDDLE FLANGE/ PLATE NOT TO BE WRAPPED.

25. ALL CERTIFICATES SHALL BE PROVIDED FOR ALL

MATERIALS


- 26. ALL WELDING TO BE API 1104.
- CONCRETE ELEMENTS OR 27. ALL WELDS TO BE 100% TESTED.

		PIPEWORK AND
TEM NO	NOM DIA	DESCRIPTION
		STAGE 1: TEM
1	DN300 x DN150	REDUCING TEE (ANSI B16.9) FITTED PIPE AT EACH END. (FLANGED ALL F
2	DN150	SPOOL PIPE,BOTH ENDS FLANGE.
3a	DN150	RESILIENT SEAL GATE VALVE TO SA WITH HAND WHEEL, NUTS BOLTS, W
3b	DN150	RESILIENT SEAL GATE VALVE TO SA WITH SPINDLE, NUTS BOLTS, WASH
4	DN150	SPOOL PIECE, FLANGED BOTH END
5	DN150	"BERMAD" PRESSURE CONTROL VA ES TYPE COMPLETE WITH V-PORT, I WASHERS AND GASKETS OR SIMILA
6	DN150	SPOOL PIPE, BOTH ENDS FLANGE.
7	DN150	90 deg LONG RADIUS BEND FITTED PIECE ON BOTH ENDS. BOTH ENDS ROTATED AT 45 deg ANGLE
8	DN150	SPOOL PIECE, F.O.E , OTHER END P WELDING. (FINAL LENGTH TO BE CC
9	DN150	45 deg LONG RADIUS BEND (ANSI 10 ON EACH END
10	DN250 x DN150	REDUCING TEE (ANSI B16.9) FITTED LONG SPOOL PIPE. (FLANGED ALL R
11	DN250	FLANGE ADAPTOR (KAMFLEX,VIKING SIMILAR APPROVED TO SUIT


	CON	ICRETE AND GEN	NERAL	NOTES				ethekwini 🍙
	A.	ENGINEER TO IN MATERIAL BEFO					NDING	WATER SERVICES
D	В.	ALL EXPOSED E					25.	
тs	C.	GENERAL COVE					50mm.	
85	D.	ENSURE THERE BETWEEN THE F FLANGE					DDLE	WATER DESIGN BRANCH ETHEKWINI
	E.	CONSTRUCTION						REDUCED PLAN USE SCALE BELOW
)		THOROUGHLY W POURED. CONS	VETTED	BEFO	RE THE	NEXT		
		SIKASWELL S-2 (CENTRALLY PLA	OR SIM				D	
	F.	CONCRETE DIST	ANCE					
		REINFORCEMEN WEEKS PRIOR T	O REIN	IFORCE	EMENT	BEING		
N		IN ORDER TO AL MOIST-CURING	TIME.					
٩N	G.	NO ACCESS OPE INDICATED ON D						NAIDU
Ή	Н.	NO WIRE TIES BI PERMITTED. FEF						CONSULTING
LL		FORMERS WITH WORKING SPAC	IN 40mr	m OF Sł	HUTTEF	२.		
: F	1.	EXCEED 1000mm	า.					
E	J.	REINFORCED CO TO SABS 1200G	5.5.11	TE SHA	LL BE \	WATER	IIGHT	 1st Floor Tel : +27 (0) 31 265 6007
-	K.	CONCRETE GRA			:15/19			1st Floor Tel : +27 (0) 31 265 6007 No.5 The Boulevard Fax : +27 (0) 31 265 6011 West Way Office Park E-mail : info@naiduconsulting.com
P		MASS CC	NCRET	ΓE	:20/19	_		Westville, Durban
R TS		CONCRE	TE			UNLES RWISE :		DRAWING No. D732-52-5259
		SCREED			:1:3 (C	EMENT	/SANE	D) FOR TENDER
	L.		,		,		,	
		LIFTING HOOKS, FRAME WERE PR	RE- INS	TALLE	O AT T⊢	ΙE		60356/002RESERVOIR SITE PLAN LAYOUT1 of 160356/009STANDARD ASSOCIATED DETAILS1 of 2
	M.	MANUFACTURE	RIAL AF	ROUND	STRUC	TURE	ТО ВЕ	
		COMPACTED TO MAXIMUM DENS						
	N.	ON COMPLETION EXPOSED ABOV						
		ROOF SLABS WI MARKING PAINT	TH 2 C0	OATS O	F WHIT	E ROA	D	
		CHAMBER IDENT ADVISED BY THE	FIFICAT	ION NU				
1	О.	SIGNAGE INSTR	UCTION	NS FOR				
		HEAVY DUTY PV INSIDE OF THE C						s
BE		INSTRUCTIONS						
A ′	FINI	SHING NOTES						
	P.	FORMED CONCF						
	P.1	I. HIDDEN SUF BURIED, ALL						ES
		INSIDE OF T SURFACES						
١R		VISIBLE S				SMOOT		
	Q.	CONCEA UNFORMED CON				ROUGH	-	Standard Drawings
		TOP OF E	BLINDIN		:	WOOD	FLOA	45002 TYPICAL TRENCH DETAILS 1 of 1
		TOP OF F				STEEL STEEL		
3							_	
								0 OCT 2021 FOR TENDER PURPOSES ONLY
								RevisionDateDescriptionUNDERGROUNDSERVICESCHECKED
								SERVICE DATE SIGNATURE S.W DRAINS
ΗE								SEWERS
								WATERMAINS G.P.O CABLES
								ELECTRIC CABLES S.A.R CABLES
								E.S.C CABLES
								OIL PIPE LINE NOTE: Only underground services affected by new construction are shown. Care must be taken during excavations for
								are snown. Care must be taken during excavations for road foundations, trenches etc., to avoid damage to underground services such as sewers, drains, cables, watermains and connections. Wherever possible these must be located before work begins.
) FI	TTIN	GS SCHEDULE						
-							No.	Contract No. WS 7400
/PC	RAR		Α	В	С	F/F	OF	Project No. D732
D W	ITH [·]	100mm SPOOL	700	320	355	700	1	Project Title
RC	UND)	100	520	000			THANDOKUHLE RESERVOIR
AN	S 66	4, COMPLETE				1350	1	COMPARTMENT 1 CONSTRUCTION OF A 3ML REINFORCED
		RS & GASKETS,				280	1	CONCRETE RESERVOIR, 150mm Ø
		4, COMPLETE GASKETS,				280	1	STEEL INLET, 300mm Ø STEEL OUTLET PIPELINES AND ASSOCIATED WORKS
DS		,				400	1	Drawing Title
AL\		ALVE TO BE						DN150 CROSS
		BOLTS, PROVED.				480	1	CONNECTION CHAMBER
_						500	1	Scales : As Shown Original Paper : A1
		100mm SPOOL ED. BEND				800	1	Designed :D. Ramghulam Date : May 2021 Checked : A. Goorun Drawn : B.Mhlungu
		NDED FOR 1ED ON SITE)				1000	2	Area Engineer : Water Operations
16.9	9). W	ELD ITEM 8						Manager (W.D.)
<u>יי ר</u>	/	DN250 x 400					1	Director (Water)
	UND	DN250 x 100mm)	630	800	316		1	<u> E.Msweli – Head:Water & Sanitation Unit</u>
IG .	IOH	NSON) OR					2	. 60356/015 1 of 1 0
						1	1	Drawing No.


650.0								
DATUM : 640.00 msl						_		
PEG DISTANCE (m)	0.00	4.51	11.30	20.00		37.59	40.00	44.28
GROUND LEVEL (m)	654.04	653.96	653.76	653.66		653.64	653.64	653.60
INVERT LEVEL (m)	650.10	650.07	650.02	649.93		649.77	649.75	649.72
DEPTH TO IL (m)	3.94	3.89	3.74	3.72		3.87	3.89	3.88
GRADE (1:_)		00 ⁰ 0	100.00		100.00		100	0.00
PIPE DISCRIPTION		•		dia./Class	50D - CONCRETE P	PIPI	Ξ	
	SWMH_1	SWMH_2	SWMH_3			SWMH_4		SWMH 5
STORM WA LONGITUDI SCALE	NA	۹L	SEC					

	SETTING OUT	DATA
REF	Y	Х
SWMH_1	23 140.975	3 284 305.322
SWMH_2	23 142.422	3 284 309.590
SWMH_3	23 144.314	3 284 316.115
SWMH_4	23 154.140	3 284 340.498
SWMH_5	23 160.299	3 284 343.124

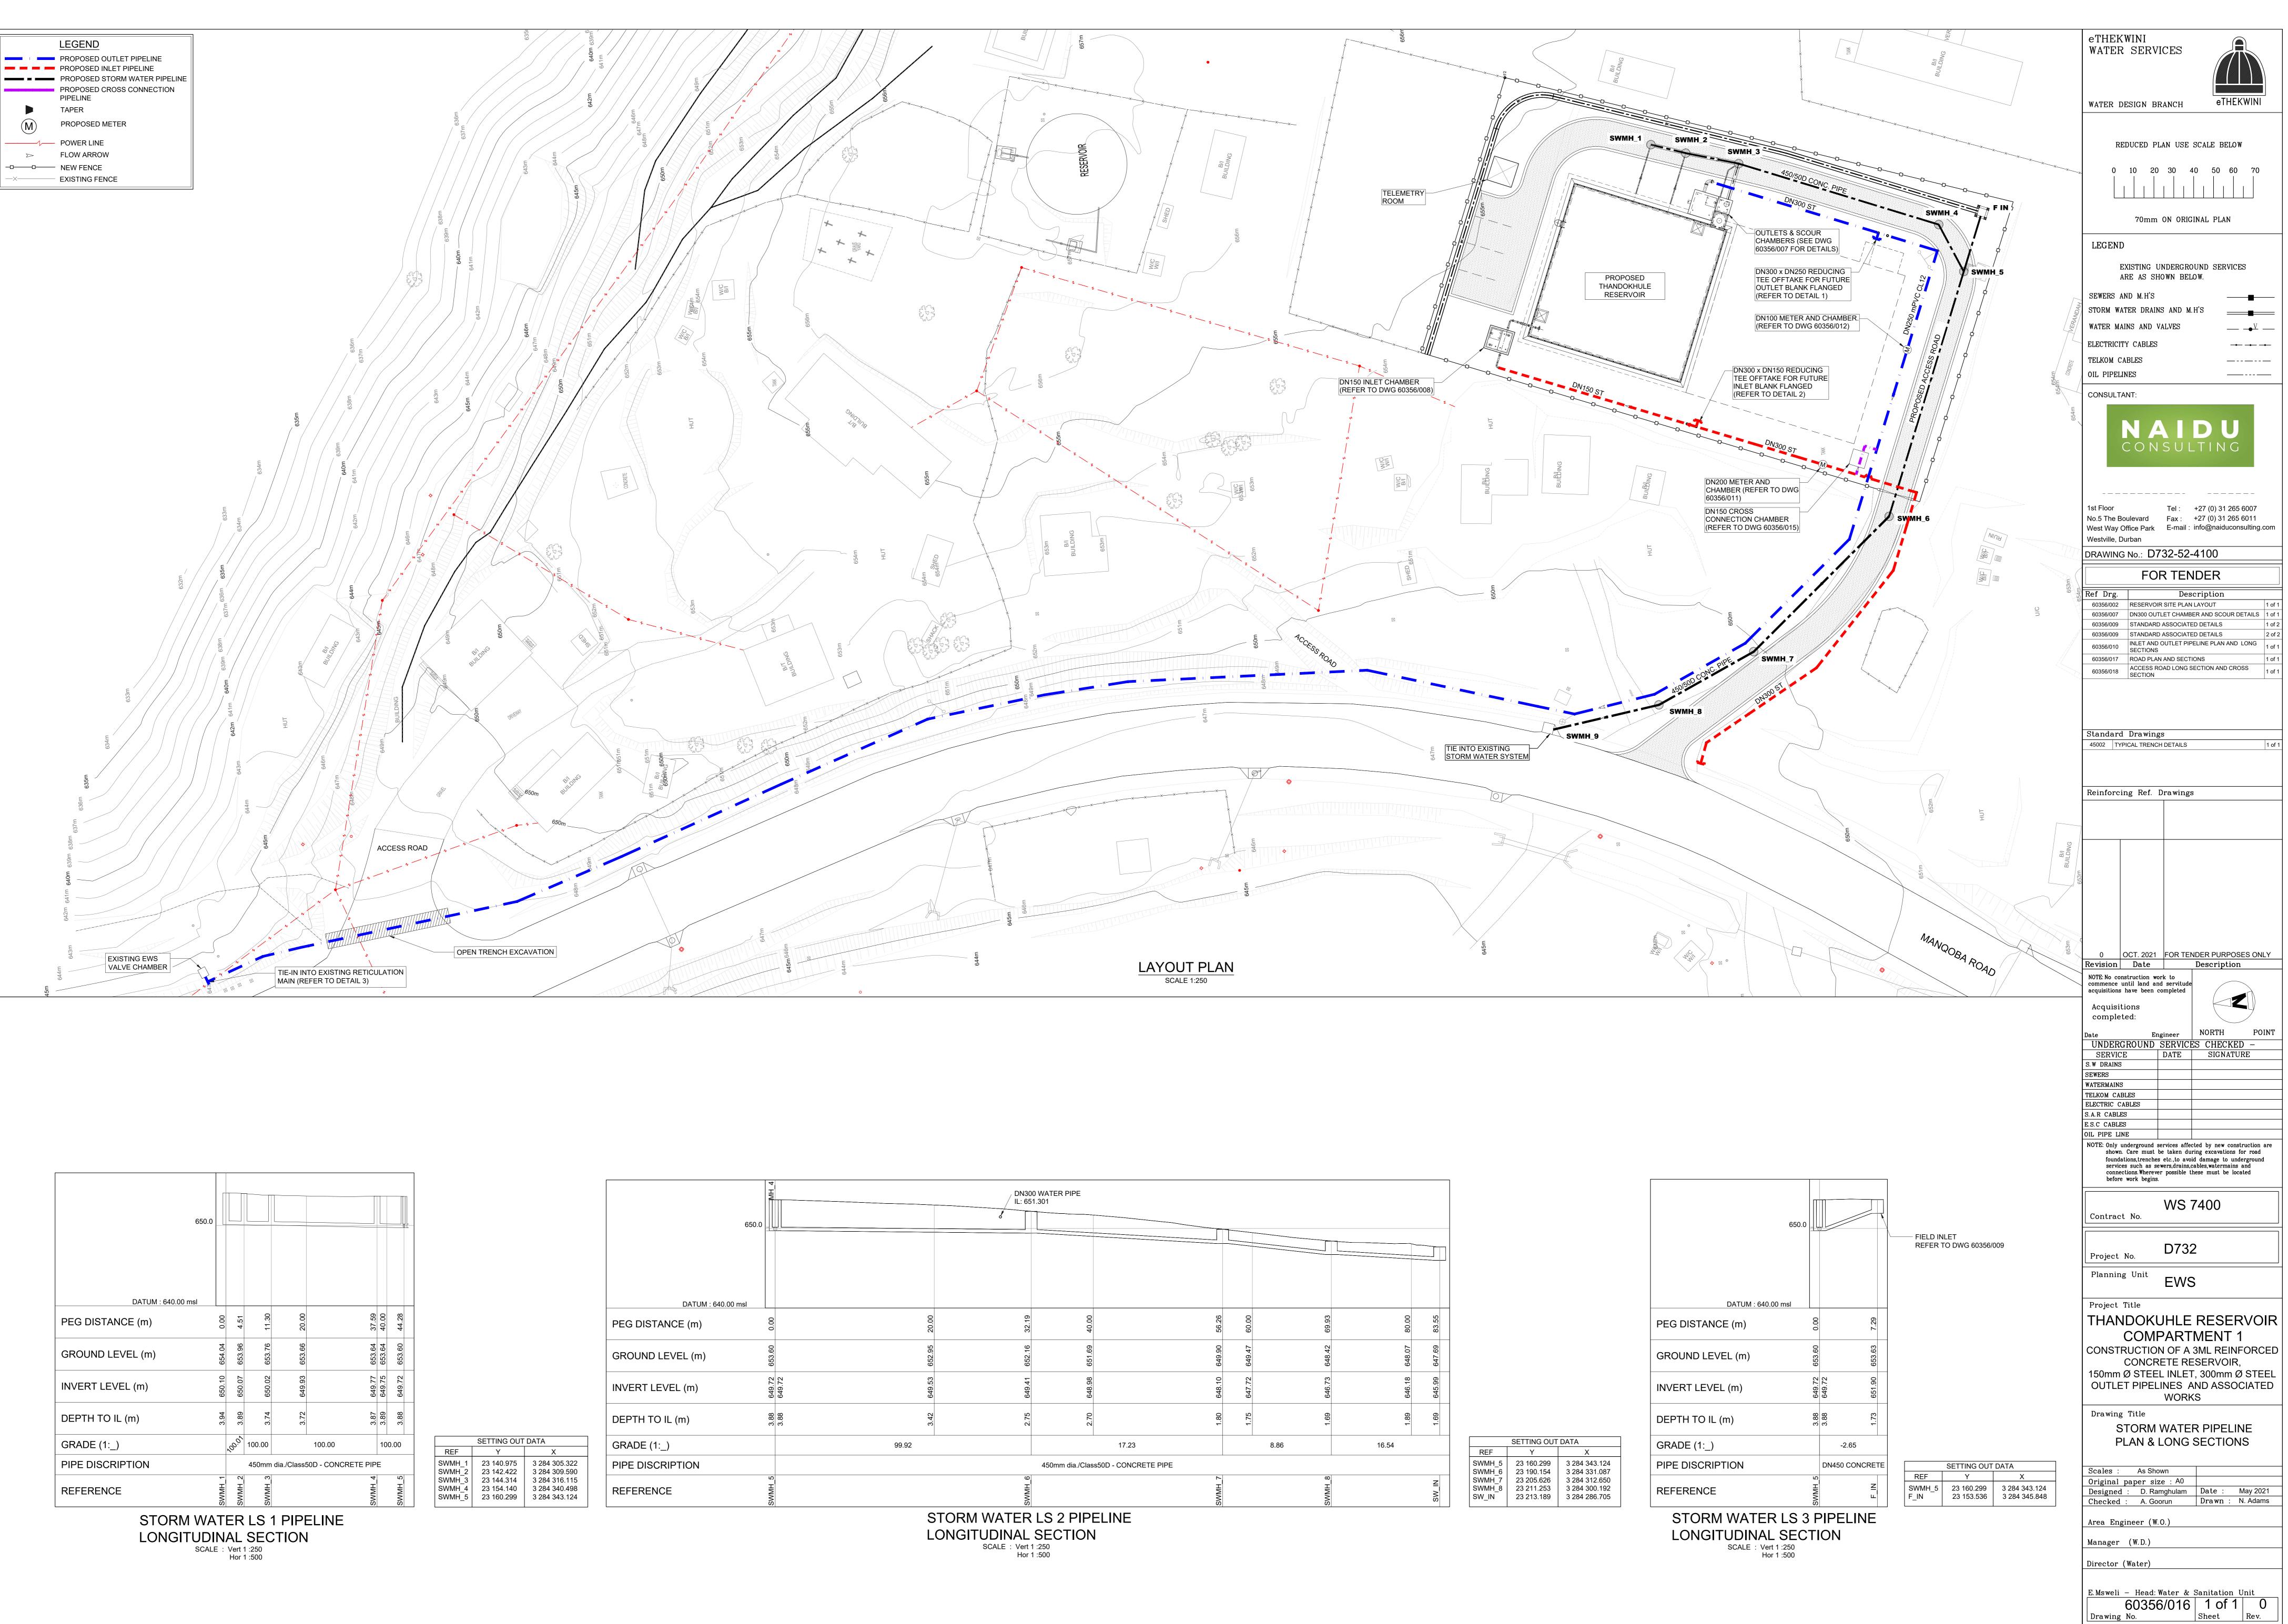



	M H 4		DN30 IL: 65	0 WATER PIPE 1.301	
	650.0		8		
DATUM : 640.00	0 msl				
		Q	თ	0	۵
PEG DISTANCE (m)	0.00	20.00	32.19	40.00	56.26
GROUND LEVEL (m)	653.60	652.95	652.16	651.69	649 _. 90
INVERT LEVEL (m)	649.72 649.72	649.53	649.41	648. <u>9</u> 8	648.10
DEPTH TO IL (m)	3.88	3.42	2.75	2.70	1.80
GRADE (1:_)		99.92			17.23
PIPE DISCRIPTION				450mm dia./Clas	ss50D - CONCRETE PIPE
REFERENCE	SWMH 5		SWMH 6		2 HMWS
		S	TORM WATER	IS2PIP	

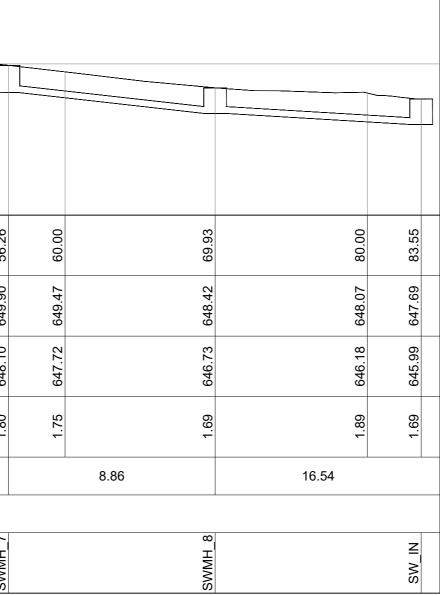


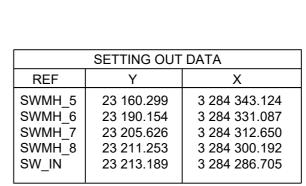


650.0		
DATUM : 640.00 msl		
PEG DISTANCE (m)	0.00	
GROUND LEVEL (m)	653.60	
INVERT LEVEL (m)	649.72	649.72
DEPTH TO IL (m)	3.88	3.88
GRADE (1:_)		-2.6
PIPE DISCRIPTION		DN450 C0
REFERENCE	SWMH 5	
STORM WATER LS 3	3 F	

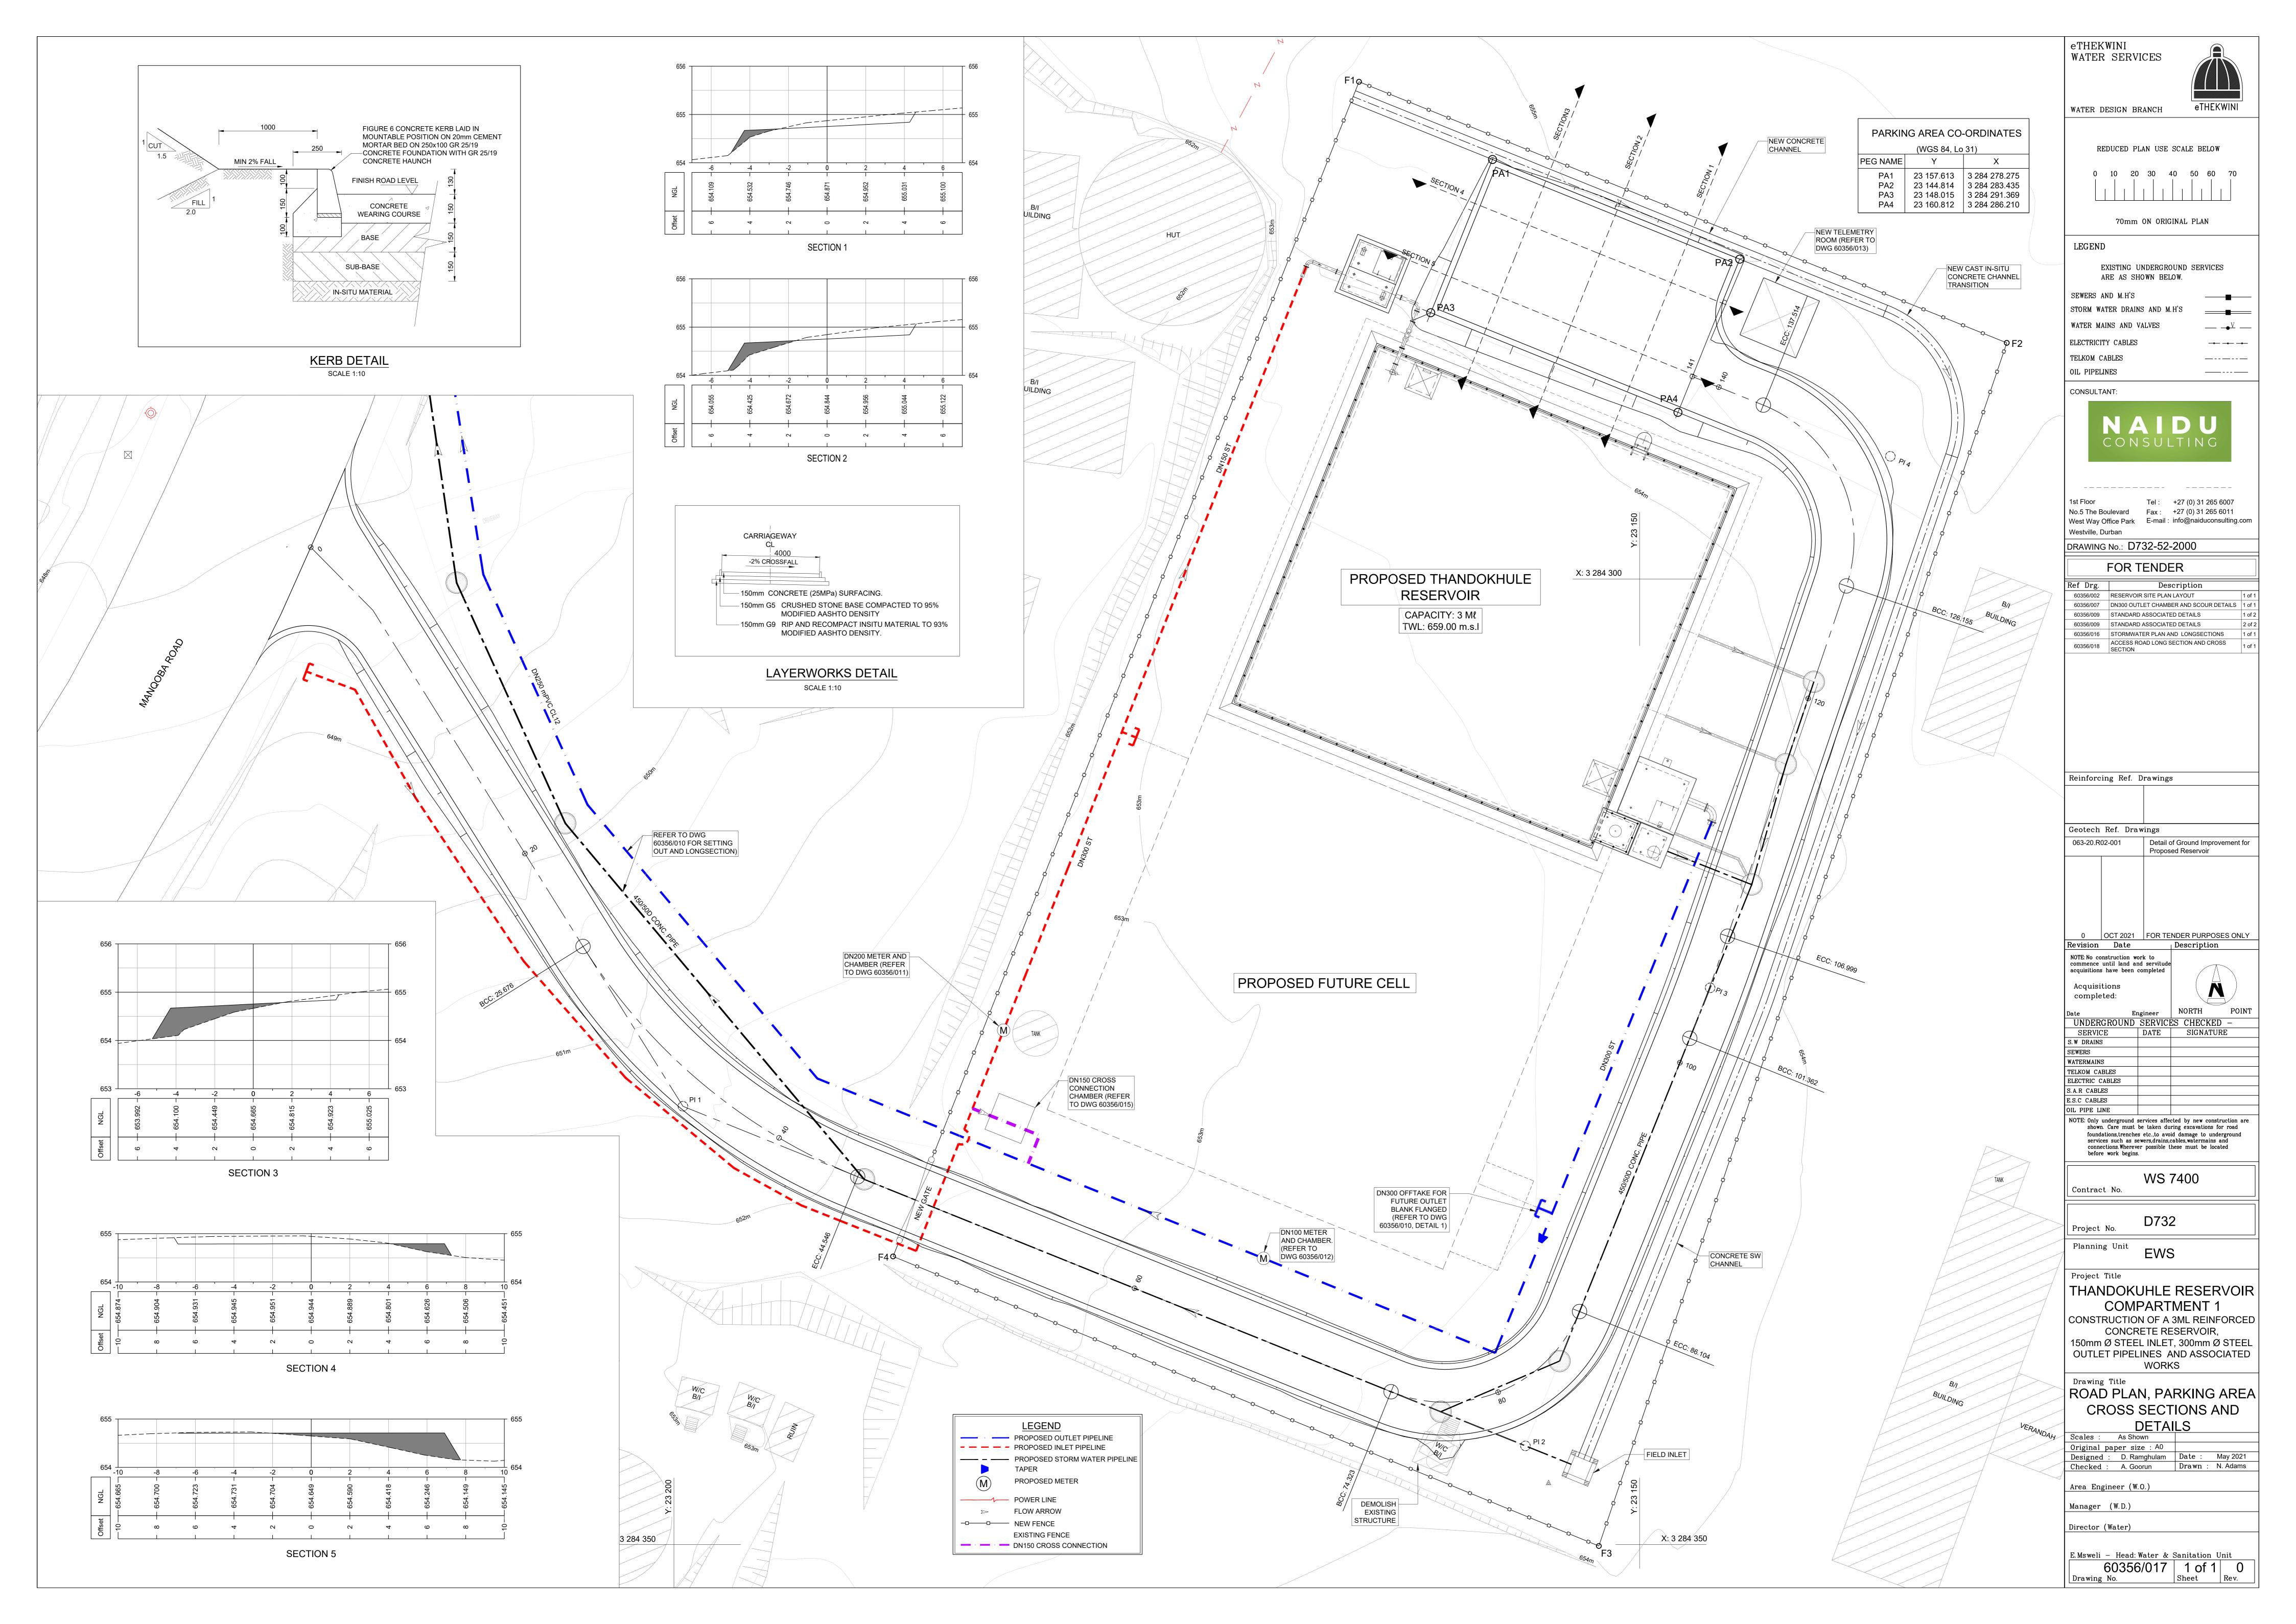


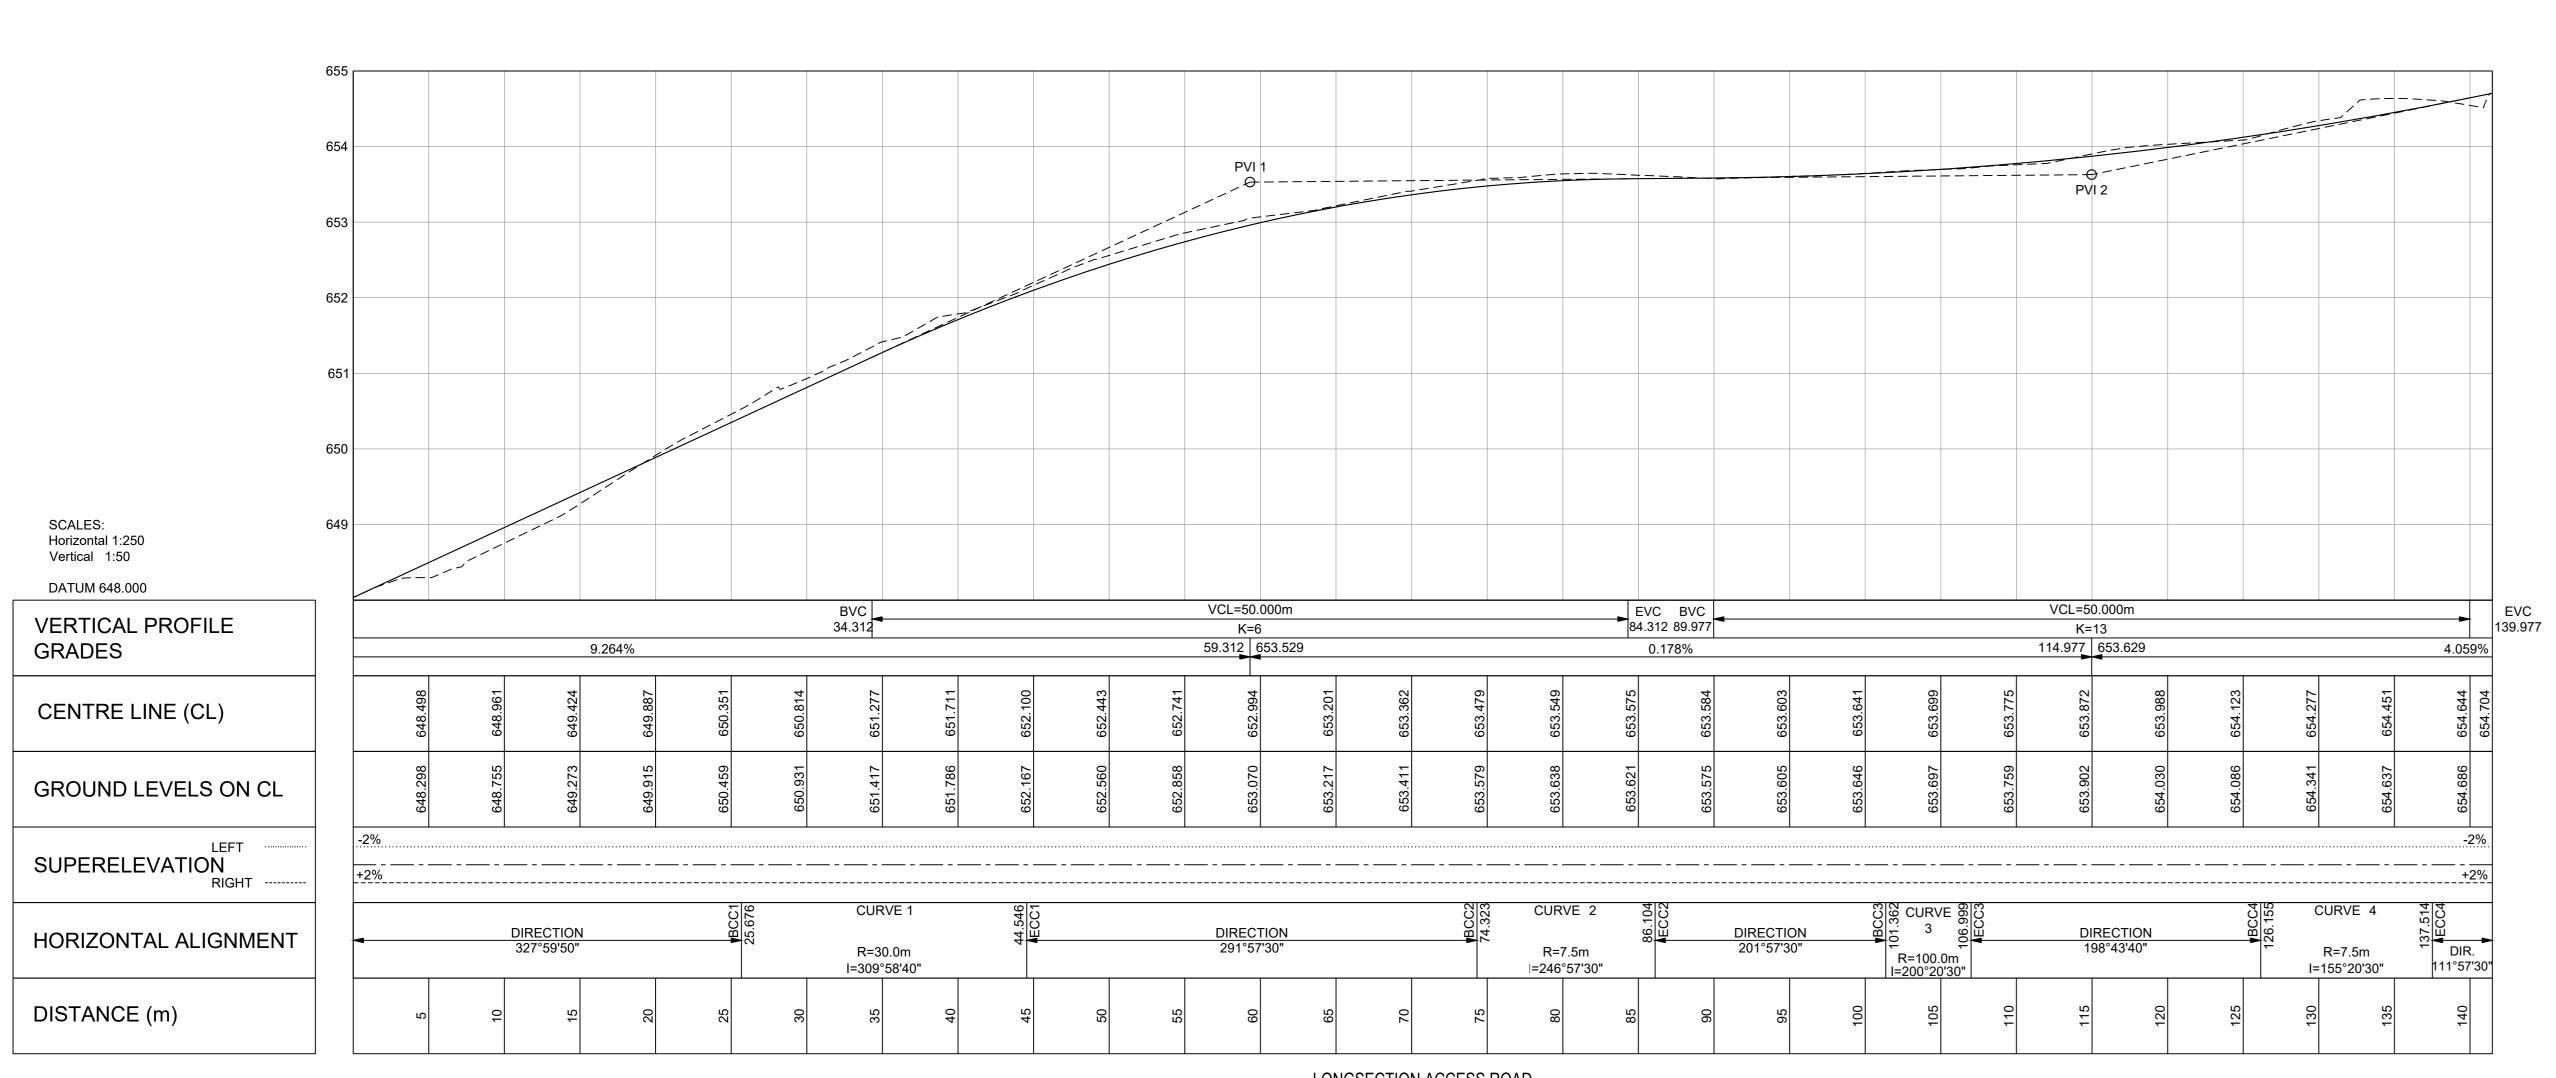


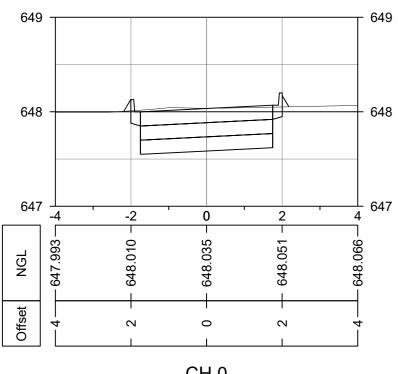


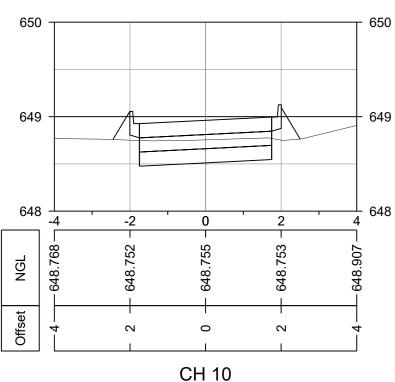



CH 20

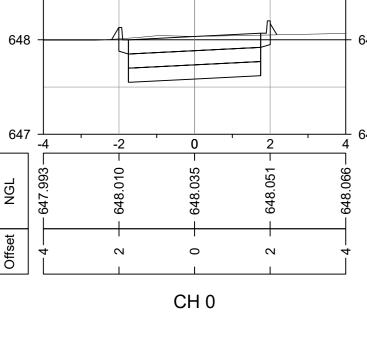


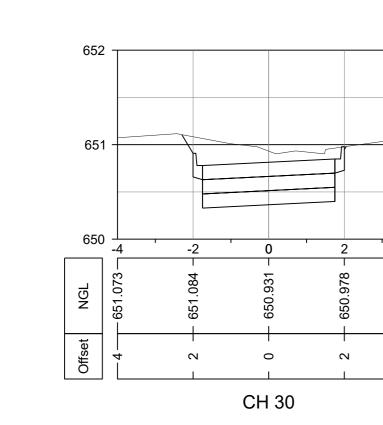


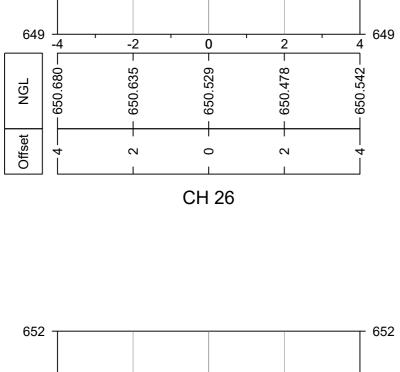


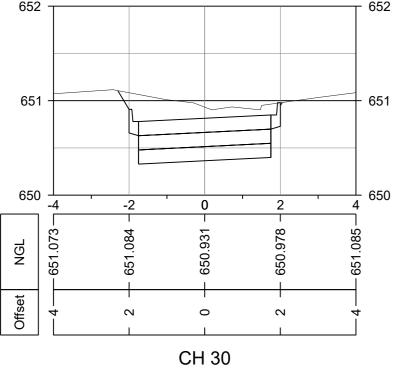


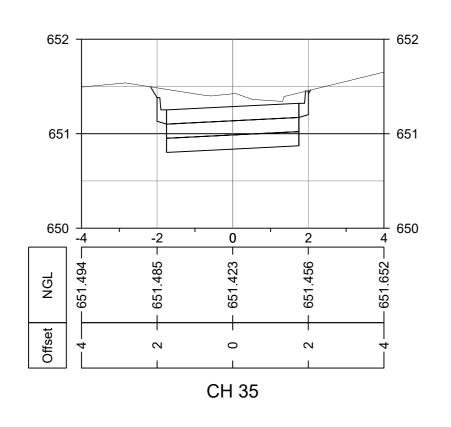


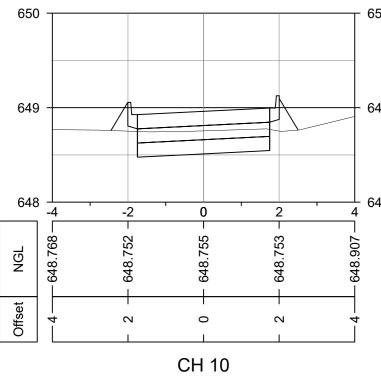

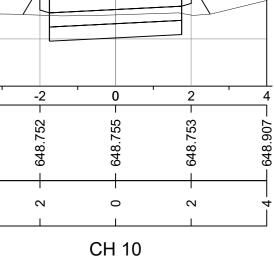

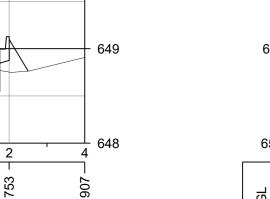


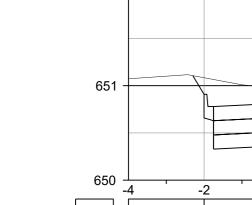


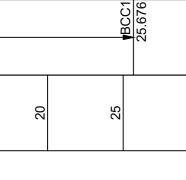



650 -


		DIRECT 291°57			BCC2	CURVE 2 R=7.5m =246°57'3	86.1 FEC		DIRECTION 201°57'30"	₽ B	CURVE 60 10 10 10 10 10 10 10 10 10 1		DIREC 198°43		+BCC4 126.155	
50	55	60	65	70	75	80	85	06	95	100	105	110	115	120	125	

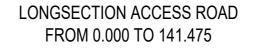


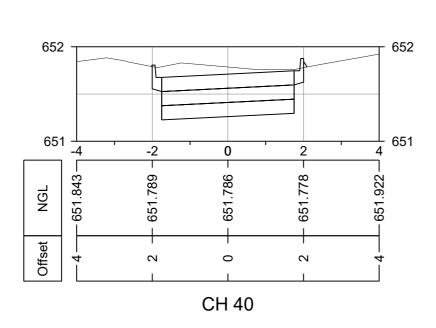


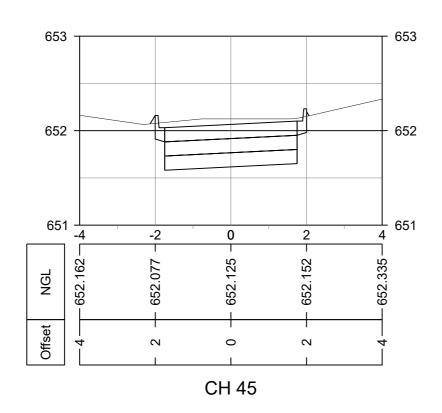


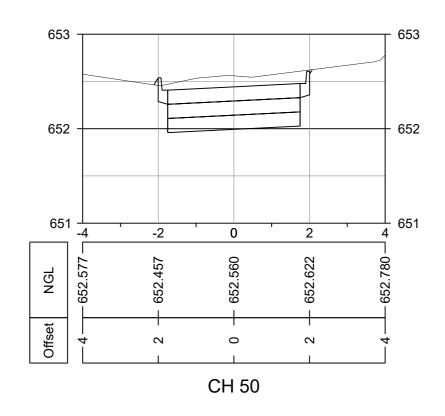


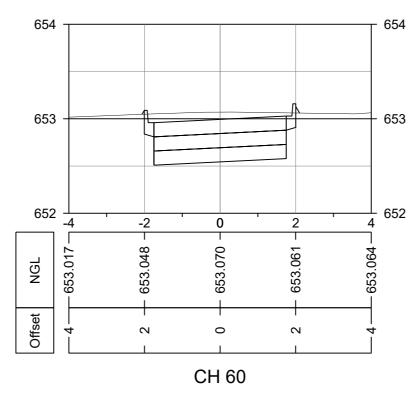


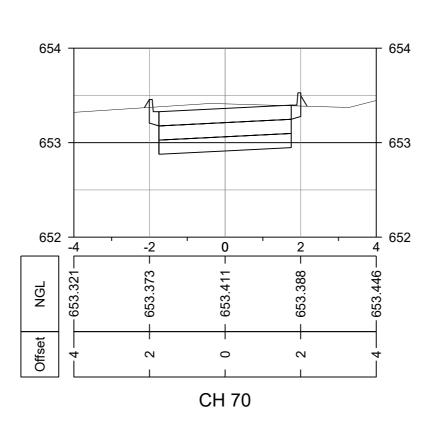


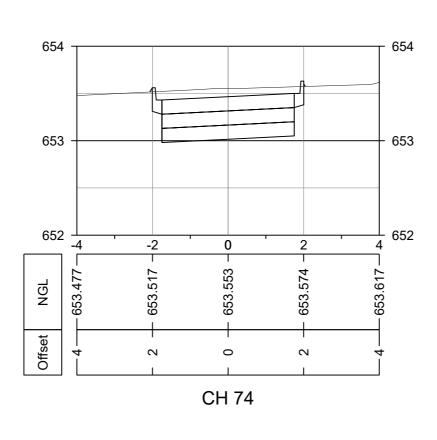


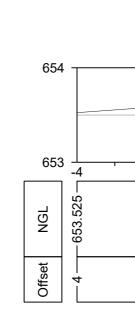


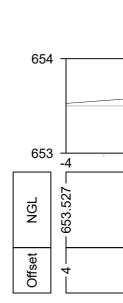


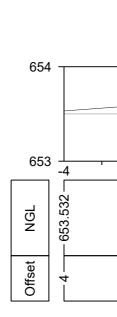


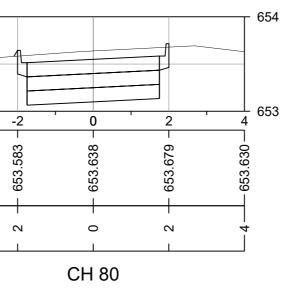


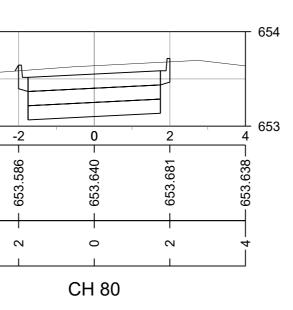


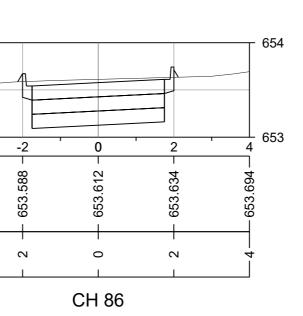


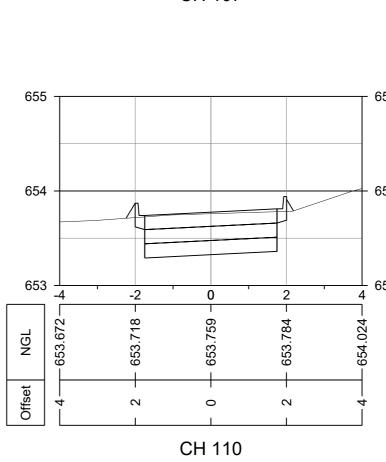


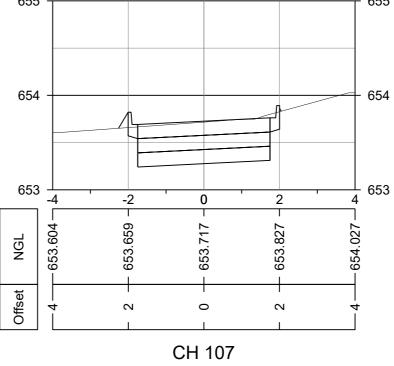

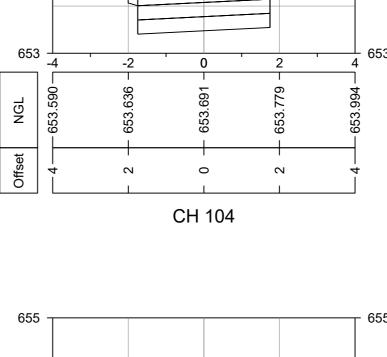

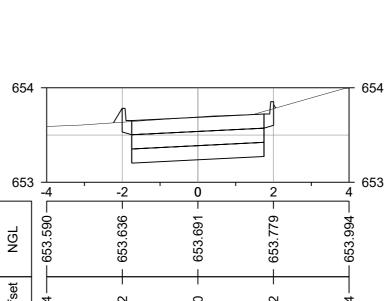

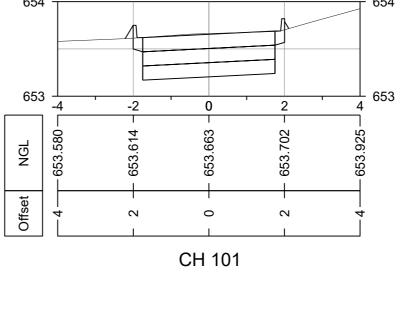

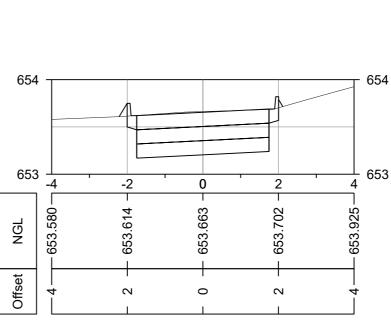


CH 90


654


653 -


653 _____

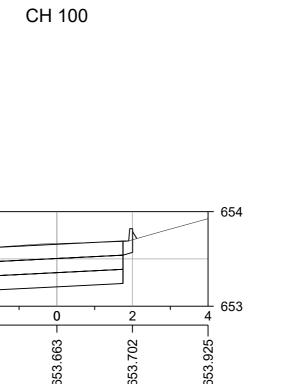



653

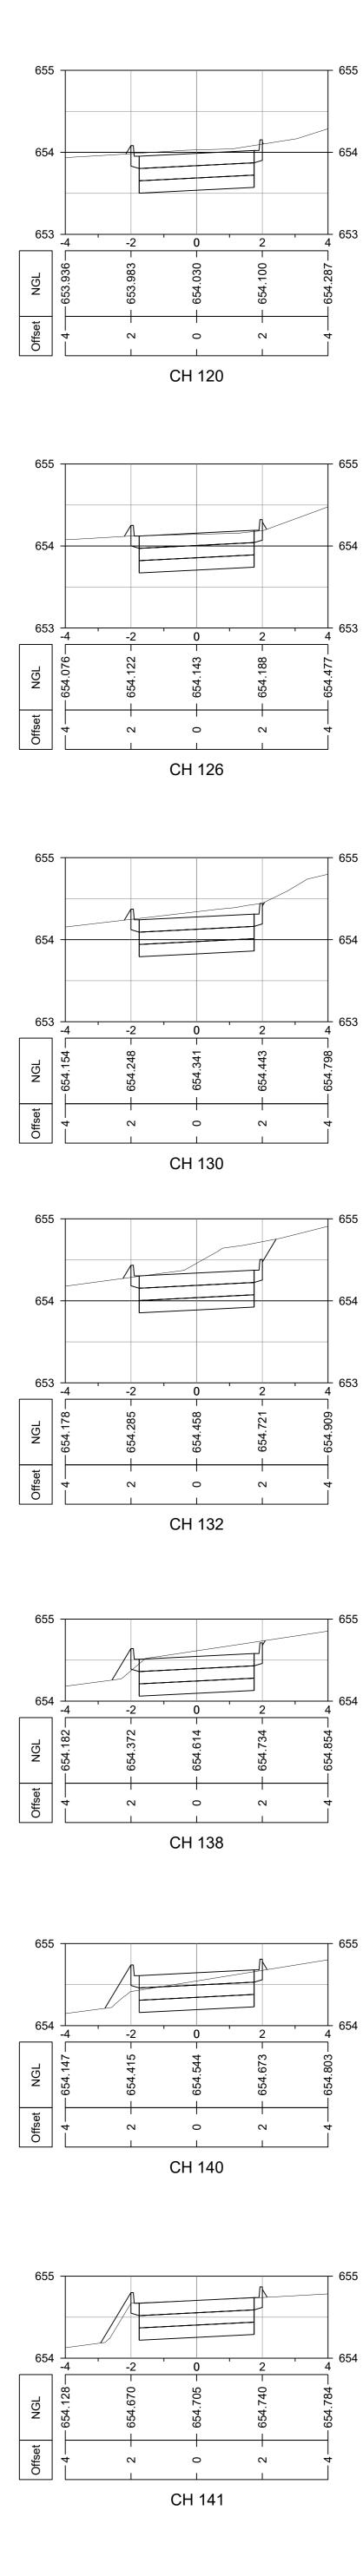


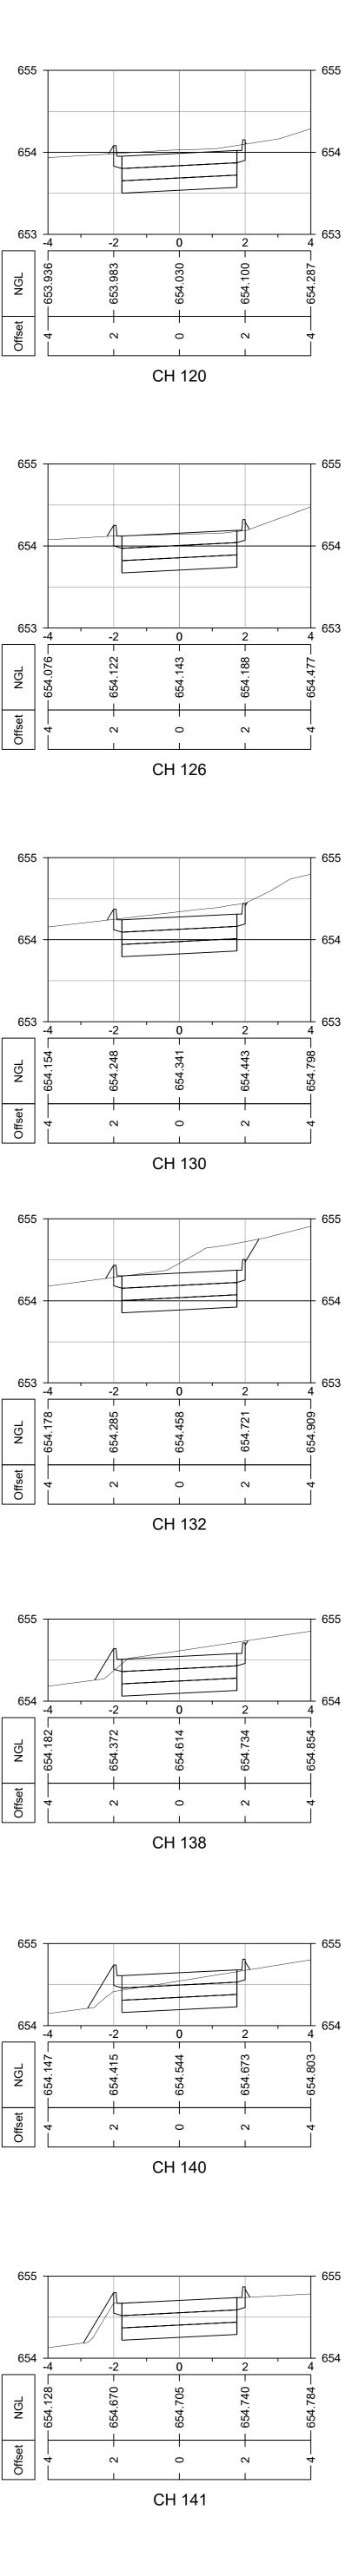


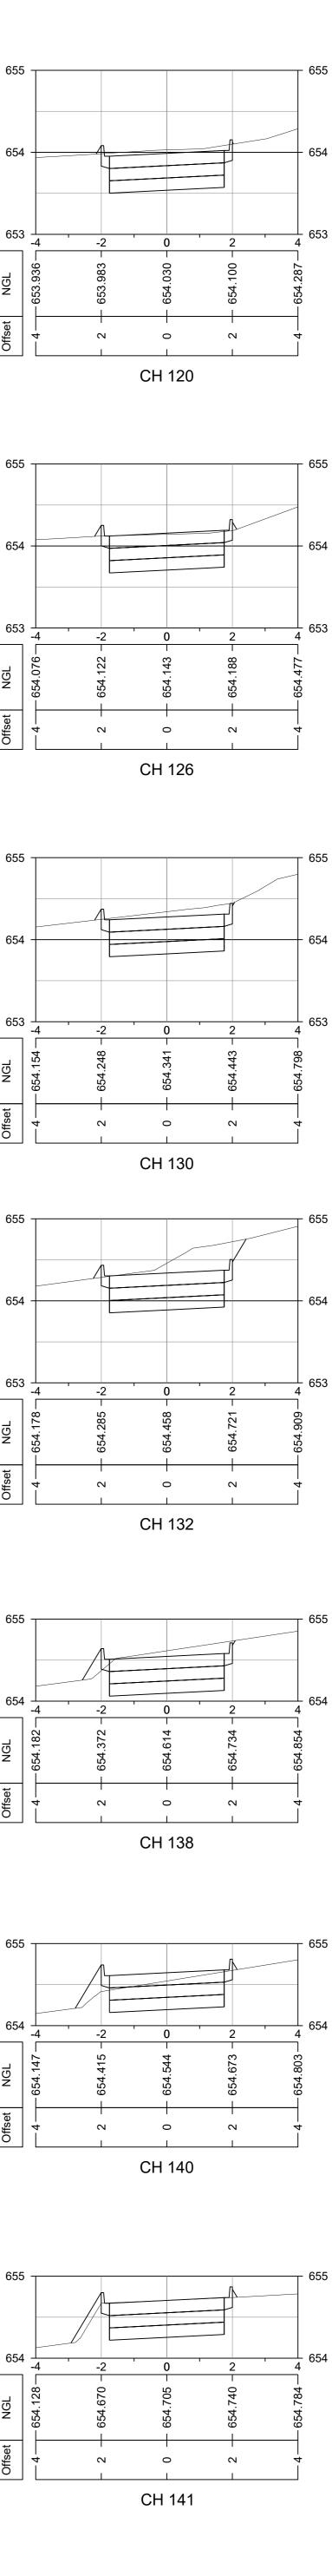


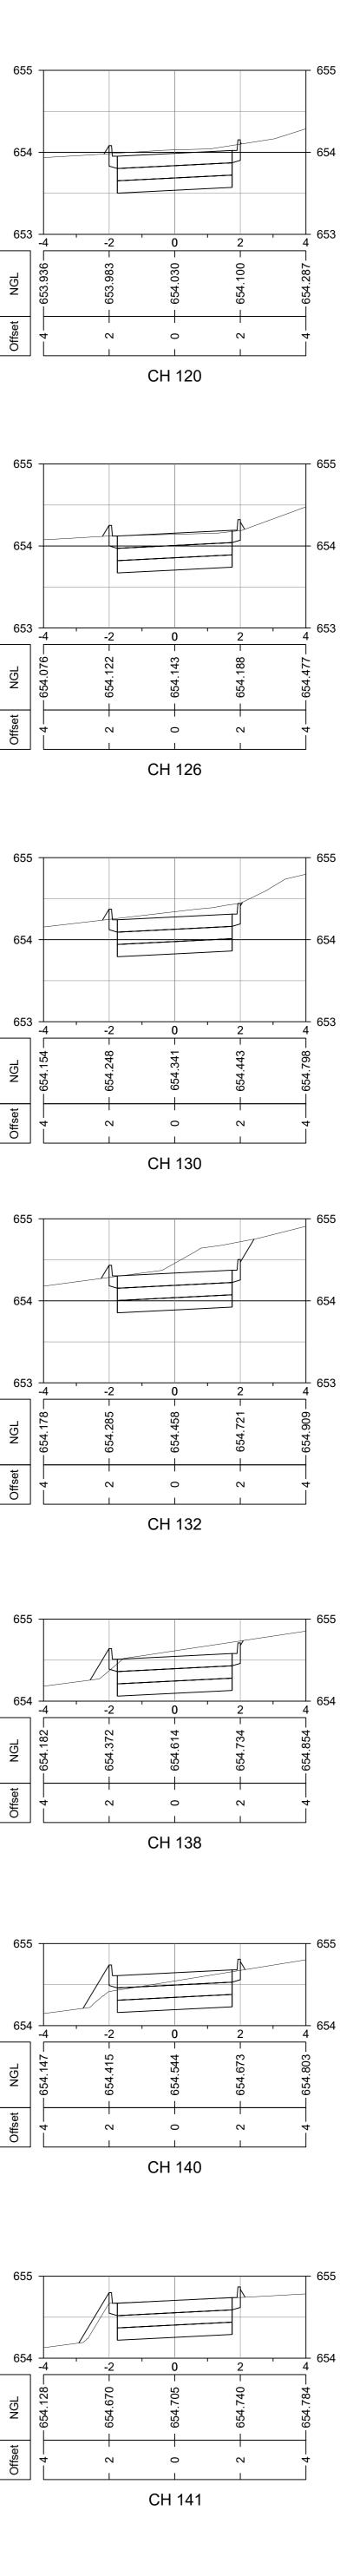

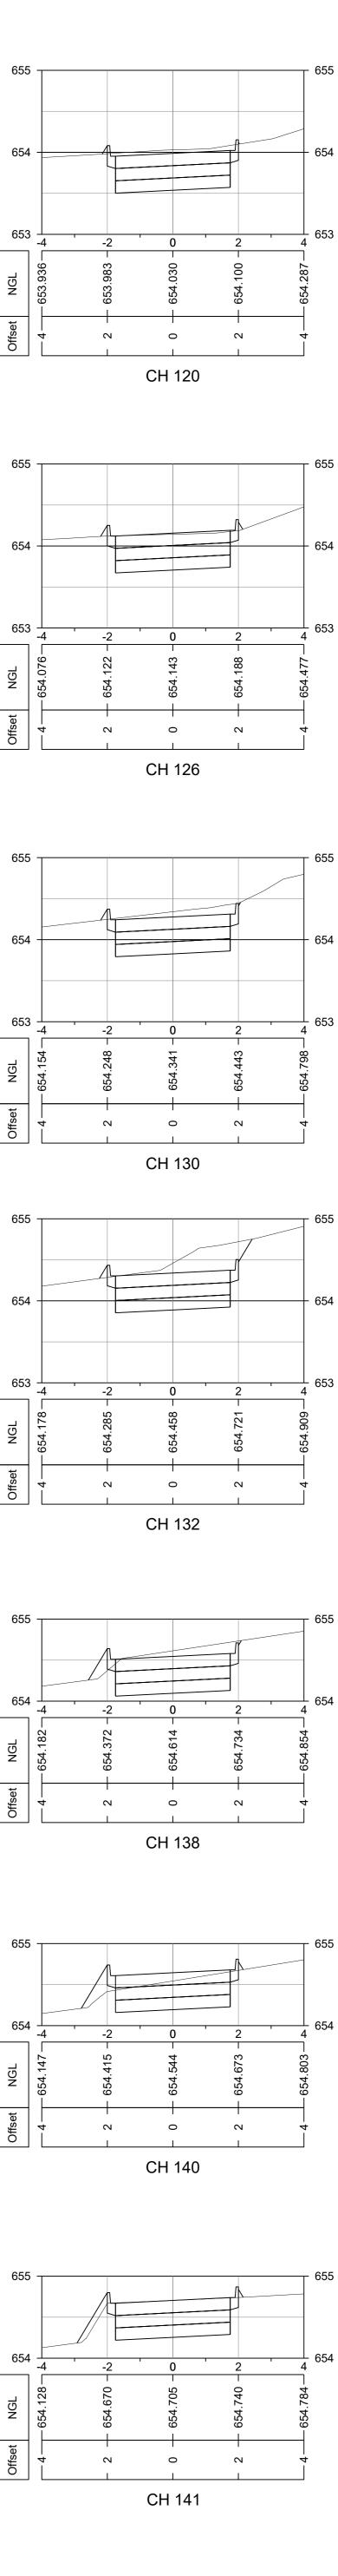


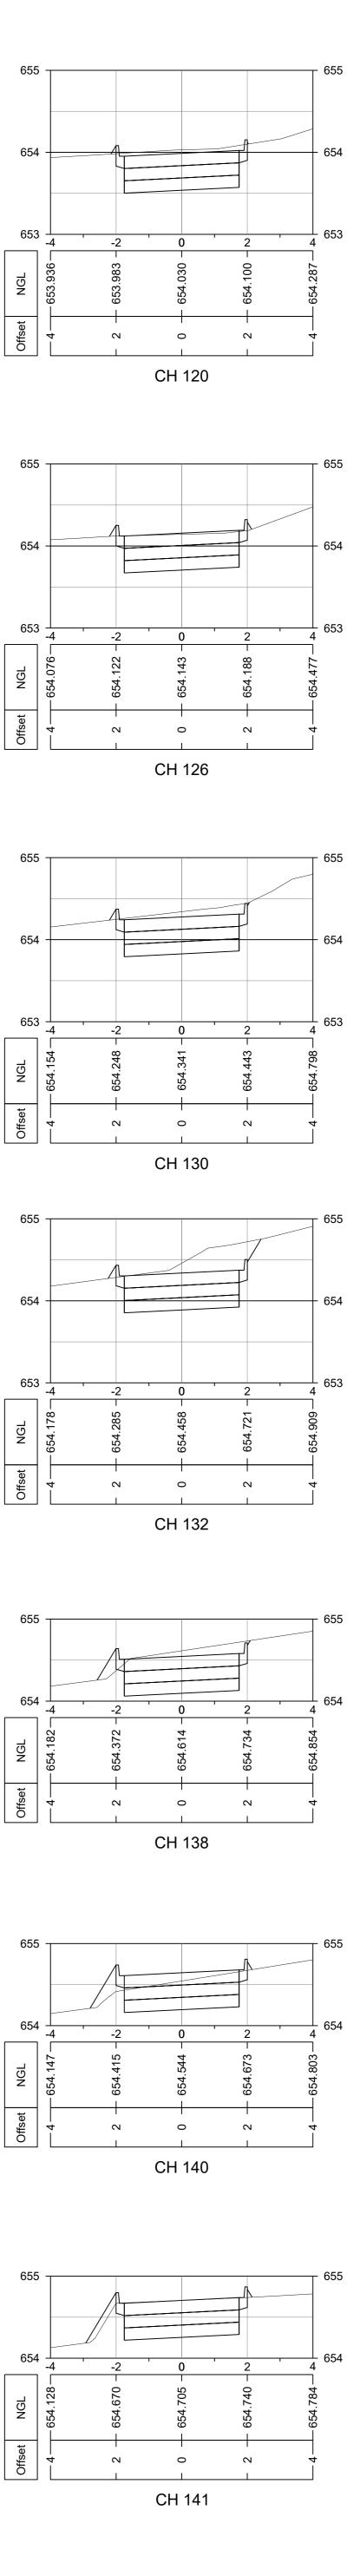


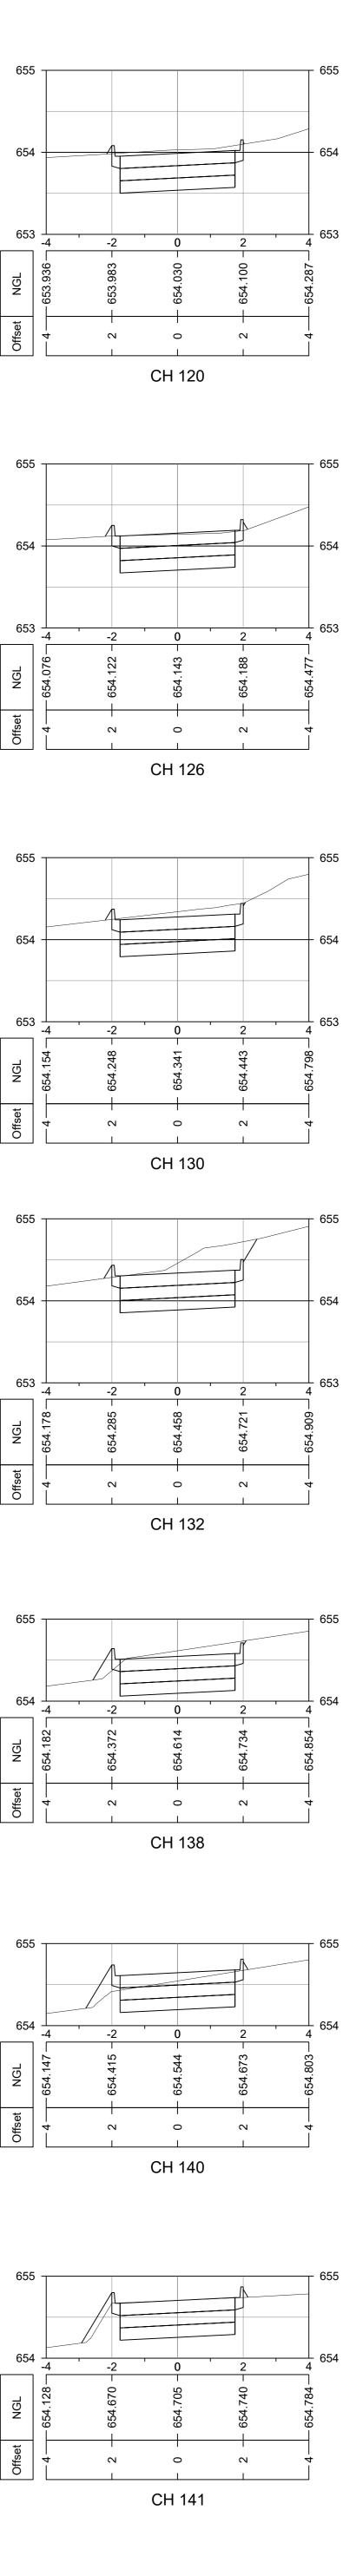

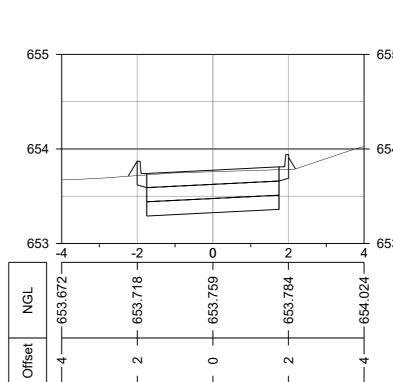



eTHEK	WINI			
WATER	R SERV	ICES		
WATER D	DESIGN BI	RANCH	eTHEK	(WINI
RI	EDUCED PI	LAN USE	SCALE BELOW	r
0	10 20	30 4	0 50 60	70
	70mm		INAL PLAN	
	70mm	UN URIG	INAL PLAN	
LEGENI)			
	EXISTING U ARE AS SH		UND SERVICE DW.	S
SEWERS A	AND M.H'S			
	ATER DRAIN		H'S	
	TY CABLES		 _+	_ _
TELKOM C	ABLES			
OIL PIPEL				
	ANI:			
1	N /		DU	
	CON	SUL		
1st Floor No.5 The B	oulevard		+27 (0) 31 265 +27 (0) 31 265	
	Office Park		info@naiducons	
DRAWING		732-52-	2500	
	FOR		DER	
Ref Drg. 60356/002	RESFRVO	Deso R SITE PLAN	cription LAYOUT	1 of 1
60356/009 60356/009	STANDARE	D ASSOCIATE	D DETAILS	1 of 2 2 of 2
60356/016 60356/017	STORMWA		ID LONGSECTION	
	i			·
O	OCT 2021 Date	FOR TEN	NDER PURPOS Description	SES ONLY
Revision NOTE: No cor commence	Date nstruction wo until land an	ork to nd servitude		SES ONLY
Revision NOTE: No cor commence acquisitions	Date nstruction wo until land an have been o	ork to nd servitude		SES ONLY
Revision NOTE: No cor commence	Date nstruction wo until land an have been o tions	ork to nd servitude		SES ONLY
Revision NOTE: No con commence acquisitions Acquisit comple	Date nstruction wo until land an have been o tions ted: En	ork to nd servitude completed ngineer	Description NORTH	POINT
Revision NOTE: No con commence acquisitions Acquisit comple	Date nstruction wo until land an have been o tions ted: En GROUND	ork to nd servitude completed ngineer	Description	POINT) –
Revision NOTE: No cor commence acquisitions Acquisit complet Date UNDERC SERVIC S.W DRAINS SEWERS	Date Instruction we until land an have been of tions ted: En GROUND E	ork to nd servitude completed ngineer SERVICE	Description NORTH	POINT) –
Revision NOTE: No cor commence to acquisitions Acquisit complet Date UNDERC SERVIC S.W DRAINS SEWERS WATERMAINS TELKOM CAE	Date nstruction we until land and have been of tions ted: En GROUND E S BLES	ork to nd servitude completed ngineer SERVICE	Description NORTH	POINT) –
Revision NOTE: No con commence of acquisitions Acquisit complet Date UNDERC SERVIC S.W DRAINS SEWERS WATERMAINS	Date nstruction we until land an have been of tions ted: En GROUND E S BLES ABLES	ork to nd servitude completed ngineer SERVICE	Description NORTH	POINT) –
Revision NOTE: No cor commence i acquisitions Acquisit comple Date UNDERC SERVIC S.W DRAINS SEWERS WATERMAINS TELKOM CAR ELECTRIC C. S.A.R CABLE E.S.C CABLE	Date nstruction we until land an have been of tions ted: En GROUND E BLES ABLES ES ES	ork to nd servitude completed ngineer SERVICE	Description NORTH	POINT) –
Revision NOTE: No cor commence acquisitions Acquisit comple Date UNDERC SERVIC S.W DRAINS SEWERS WATERMAINS TELKOM CAR ELECTRIC C. S.A.R CABLE E.S.C CABLE OIL PIPE LII NOTE: Only u shown	Date Date Date Date Date Date Date Date	agineer SERVICE DATE	Description NORTH S CHECKEI SIGNATU	POINT) — RE ruction are or road
Revision NOTE: No cor commence of acquisitions Acquisit complet Date UNDERC SERVIC S.W DRAINS SEWERS WATERMAINS TELKOM CAR ELECTRIC C. S.A.R CABLE E.S.C CABLE OIL PIPE LII NOTE: Only u shown. founda service. conned	Date Instruction we until land an have been of tions ted: En GROUND E BLES ABLES S BLES ABLES S NE underground s . Care must ations,trenches es such as sections. Wherever	agineer SERVICE DATE DATE	Description NORTH SCHECKEI SIGNATU	POINT) — RE ruction are or road erground and
Revision NOTE: No cor commence of acquisitions Acquisit complet Date UNDERC SERVIC S.W DRAINS SEWERS WATERMAINS TELKOM CAR ELECTRIC C. S.A.R CABLE E.S.C CABLE OIL PIPE LII NOTE: Only u shown. founda service. conned	Date Instruction we until land an have been of tions ted: En GROUND E BLES ABLES S NE underground s Care must ations,trenches es such as se	agineer SERVICE DATE DATE	Description NORTH S CHECKEI SIGNATU SIGNATU	POINT) — RE ruction are or road erground and
Revision NOTE: No cor commence acquisitions Acquisit complet Date UNDERC SERVIC S.W DRAINS SEWERS WATERMAINS TELKOM CAB ELECTRIC C. S.A.R CABLE OIL PIPE LII NOTE: Only u shown founda service connee before	Date Date Date Date Date Date Date Date	agineer SERVICE DATE DATE	NORTH S CHECKEI SIGNATUI ted by new const ing excavations for d damage to undor ables, watermains nese must be loca	POINT) — RE ruction are or road erground and
Revision NOTE: No cor commence of acquisitions Acquisit complet Date UNDERC SERVIC S.W DRAINS SEWERS WATERMAINS TELKOM CAR ELECTRIC C. S.A.R CABLE E.S.C CABLE OIL PIPE LII NOTE: Only u shown. founda service. conned	Date Date Date Date Date Date Date Date	agineer SERVICE DATE DATE services affector be taken dur s etc., to avoid ewers, drains, c er possible th	NORTH S CHECKEI SIGNATUI ted by new const ing excavations for d damage to undor ables, watermains nese must be loca	POINT) — RE ruction are or road erground and
Revision NOTE: No cor commence acquisitions Acquisit complet Date UNDERC SERVIC S.W DRAINS SEWERS WATERMAINS TELKOM CAB ELECTRIC C. S.A.R CABLE OIL PIPE LII NOTE: Only u shown founda service connee before	Date Date Date Date Date Date Date Date	agineer SERVICE DATE DATE services affector be taken dur s etc., to avoid ewers, drains, c er possible th	NORTH S CHECKEI SIGNATU ted by new const ing excavations for d damage to unduables, watermains nese must be loca 7400	POINT) — RE ruction are or road erground and
Revision NOTE: No cor commence i acquisitions Acquisit complet Date UNDERC SERVIC S.W DRAINS SEWERS WATERMAINS TELKOM CAR ELECTRIC C. S.A.R CABLE E.S.C CABLE OIL PIPE LII NOTE: Only u shown. founda service connect before	Date Instruction wo until land an have been of tions ted: En GROUND E BLES ABLES S NE underground s care must ations,trenches es such as se ctions. Whereve work begins. t No. No.	agineer SERVICE DATE DATE services affector be taken dur s etc., to avoid ewers, drains, c er possible th	NORTH S CHECKEI SIGNATU ted by new const ing excavations for d damage to unduables, watermains nese must be loca 7400	POINT) — RE ruction are or road erground and
Revision NOTE: No cor commence i acquisitions Acquisit complet Date UNDERC SERVIC S.W DRAINS SEWERS WATERMAINS TELKOM CAB ELECTRIC C. S.A.R CABLE OIL PIPE LII NOTE: Only u shown founda service connee before Contrac	Date Instruction wo until land an have been of tions ted: En GROUND E BLES ABLES S NE underground s care must ations,trenches es such as se ctions. Whereve work begins. t No. No.	agineer SERVICE DATE DATE services affector be taken dur s etc., to avoid ewers, drains, c er possible th	NORTH S CHECKEI SIGNATU ted by new const ing excavations for d damage to unduables, watermains nese must be loca 7400	POINT) — RE ruction are or road erground and
Revision NOTE: No cor commence acquisitions Acquisit complet Date UNDERC SERVIC S.W DRAINS SEWERS WATERMAINS TELKOM CABLE ELECTRIC C. S.A.R CABLE OIL PIPE LII NOTE: Only u shown founda service connee before Contrac	Date nstruction wo until land an have been of tions ted: En GROUND E BLES ABLES S NE underground s . Care must ations,trenches es such as sections. Whereve work begins. t No. g Unit	agineer SERVICE DATE DATE services affector be taken dur s etc., to avoid ewers, drains, c er possible th	NORTH S CHECKEI SIGNATU ted by new const ing excavations for d damage to unduables, watermains nese must be loca 7400	POINT) — RE ruction are or road erground and
Revision NOTE: No cor commence i acquisitions Acquisit complet Date UNDERC SERVIC S.W DRAINS SEWERS WATERMAINS TELKOM CAR ELECTRIC C. S.A.R CABLE OIL PIPE LII NOTE: Only u shown. founda service connect before Contrac	Date Instruction we until land an have been of tions ted: En GROUND E BLES ABLES ABLES S NE underground s . Care must ations,trenches es such as sections. Whereve work begins. t No. g Unit Title	brk to ad servitude completed SERVICE DATE DATE Services affector be taken dur s etc., to avoid ewers, drains, c er possible th WS 7 D732 EWS	NORTH S CHECKEI SIGNATU ted by new const ing excavations for d damage to unduables, watermains nese must be loca 7400	POINT) RE ruction are or road erground and ated
Revision NOTE: No cor commence acquisitions Acquisit complet Date UNDERC SERVIC S.W DRAINS SEWERS WATERMAINS TELKOM CAR ELECTRIC C. S.A.R CABLE E.S.C CABLE OIL PIPE LII NOTE: Only u shown founda service connec before Contrace Project Plannin Project	Date Instruction wountil land and have been of tions ted: En GROUND E BLES ABLES BLES ABLES S NE underground s Care must ations,trenches es such as sections. Wherever work begins. t No. g Unit Title IDOKI COMI	agineer SERVICE DATE DATE Services affector be taken dur setc., to avoid ewers, drains, c er possible th WS 7 D732 EWS JHLE PART	NORTH S CHECKEI SIGNATU ted by new const ing excavations fo d damage to unde ables, watermains tese must be loca 7400 C RESER MENT 1	POINT D - RE ruction are or road erground and ated
Revision NOTE: No cor commence acquisitions Acquisit complet Date UNDERC SERVIC S.W DRAINS SEWERS WATERMAINS TELKOM CAR ELECTRIC C. S.A.R CABLE E.S.C CABLE OIL PIPE LII NOTE: Only u shown founda service connec before Contrace Project Plannin Project	Date Date Date Date Date Date Date Date	agineer SERVICE DATE DATE SERVICE DATE DATE Services affector be taken dur s etc.,to avoid evers,drains,c er possible the WS 7 D732 EWS JHLE PART N OF A	NORTH S CHECKEI SIGNATU	POINT D — RE ruction are or road erground and ated
Revision NOTE: No cor commence i acquisitions Acquisit complet Date UNDERC SERVIC S.W DRAINS SEWERS WATERMAINS TELKOM CAR ELECTRIC C. S.A.R CABLE OIL PIPE LII NOTE: Only u shown founda service connect before Contrac	Date Date Date Date Date Date Date Date	agineer SERVICE DATE DATE DATE DATE DATE DATE DATE DAT	NORTH S CHECKEI SIGNATU SIGNATU SIGNATU Addamage to undurables, watermains ted by new const ing excavations for d damage to undurables, watermains tese must be loca 7400 2 3 RESER MENT 1 3 ML REINF SERVOIR, 7, 300mm Ø	POINT D POINT D RE Tuction are or road erground and ated
Revision NOTE: No cor commence i acquisitions Acquisit complet Date UNDERC SERVIC S.W DRAINS SEWERS WATERMAINS TELKOM CAR ELECTRIC C. S.A.R CABLE OIL PIPE LII NOTE: Only u shown founda service connect before Contrac	Date Date Date Date Date Date Date Date	agineer SERVICE DATE DATE DATE DATE DATE DATE DATE DAT	NORTH S CHECKEI SIGNATU I SIGNATU I I I I I I I I I I I I I I I I I I I	POINT D POINT D RE Tuction are or road erground and ated
Revision NOTE: No cor commence i acquisitions Acquisit complet Date UNDERC SERVIC S.W DRAINS SEWERS WATERMAINS TELKOM CAR ELECTRIC C. S.A.R CABLE OIL PIPE LII NOTE: Only u shown founda service connect before Contrac	Date Instruction we until land and have been of tions ted: En GROUND E BLES ABLES ABLES S NE underground s Care must ations,trenches es such as sections. Whereve work begins. Totale IDOKI CONCR Ø STEE T PIPEL	agineer SERVICE DATE DATE DATE DATE DATE DATE DATE DAT	NORTH S CHECKEI SIGNATU I SIGNATU I I I I I I I I I I I I I I I I I I I	POINT D POINT D RE Tuction are or road erground and ated
Revision NOTE: No cor commence acquisitions Acquisit complet Date UNDERC SERVIC S.W DRAINS SEWERS WATERMAINS TELKOM CAB ELECTRIC C. S.A.R CABLE OIL PIPE LII NOTE: Only u shown founda service connee before Contrac Project Plannin Project THAN CONSTE	Date Instruction we until land an have been of tions ted: En GROUND E BLES BLES ABLES S NE underground s Care must ations,trenches es such as sections. Wherewe work begins. t No. g Unit Title IDOKI CONCR Ø STEE T PIPEL g Title	agineer SERVICE DATE DATE DATE DATE Services affector be taken dur s etc., to avoid ewers, drains, c er possible the WS 7 D732 EWS JHLE PART N OF A ETE RE L INLET INES A WORK	NORTH S CHECKEI SIGNATUI SIGNATUI ted by new const ing excavations for d damage to unduables, watermains here must be loca 7400 75000 7500 7500 7500 7500 75000 7500	POINT C POINT C POINT C POINT C POINT C C C POINT C PO
Revision NOTE: No cor commence i acquisitions Acquisit complet Date UNDERO SERVIC S.W DRAINS SEWERS WATERMAINS TELKOM CAR ELECTRIC C. S.A.R CABLE OIL PIPE LII NOTE: Only u shown. founda servic. Contrac Contrac Project Plannin Project THAN CONSTI 150mm OUTLE Drawing ROAI	Date Date Date Date Date Date Date Date	agineer SERVICE DATE	NORTH S CHECKEI SIGNATU I SIGNATU I I I I I I I I I I I I I I I I I I I	POINT D - RE ruction are or road erground and atted VOIR CVOIR CORCED STEEL CIATED AND
Revision NOTE: No cor commence acquisitions Acquisit complet Date UNDERC SERVIC S.W DRAINS SEWERS WATERMAINS TELKOM CAR ELECTRIC C. S.A.R CABLE E.S.C CABLE OIL PIPE LII NOTE: Only u shown founda service connect before Contrace Project Plannin Project THAN CONSTI 150mm OUTLE Dra wing ROAI	Date Instruction we until land and have been of tions ted: En GROUND E BLES ABLES BLES ABLES S NE underground s Care must ations,trenches es such as sections. Whereve work begins. t No. g Unit Title IDOKI CONCR Ø STEE T PIPEL G Title D LON CROS As Sho	agineer SERVICE DATE DATE DATE DATE Services affector be taken dur setc., to avoid ewers, drains, c er possible th WS 7 D732 EWS JHLE PART NOF A ETE RE L INLET INES A WORK S SEC DWN	NORTH S CHECKEI SIGNATU SIGNATU SIGNATU Led by new const ing excavations for d damage to und ables, watermains here must be loca 7400	POINT D - RE ruction are or road erground and atted VOIR CVOIR CORCED STEEL CIATED AND
Revision NOTE: No cor commence acquisitions Acquisit complet Date UNDERC SERVIC S.W DRAINS SEWERS WATERMAINS TELKOM CAR ELECTRIC C. S.A.R CABLE OIL PIPE LII NOTE: Only u shown founda service connec before ROALE Project Plannin, Project THAN CONSTE Date Drawing CONSTE	Date Instruction we until land an have been of tions ted: En GROUND E BLES ABLES ABLES S NE underground s Care must ations,trenches es such as sections. Whereve work begins. Title IDOKI CONCR Ø STEE TONC CONCR Ø STEE TONC As Sho	agineer SERVICE DATE DATE DATE DATE Services affector be taken dur setc., to avoid wers, drains, c er possible th WS 7 D732 EWS JHLE PART NOF A ETE RE L INLET INES A WORK S SEC own ze : A0 mghulam	NORTH S CHECKEI SIGNATU SIGNATU SIGNATU ted by new const ing excavations for d damage to undu ables, watermains nese must be loca 7400 740	POINT D – RE ruction are or road erground and ated CVOIR CORCED STEEL CIATED May 2021
Revision NOTE: No cor commence acquisitions Acquisit complet Date UNDERC SERVIC S.W DRAINS SEWERS WATERMAINS TELKOM CAR ELECTRIC C. S.A.R CABLE OIL PIPE LII NOTE: Only u shown founda service connec before ROALE Project Plannin, Project THAN CONSTE Date Drawing CONSTE	Date Instruction we until land an have been of tions ted: En GROUND E BLES ABLES BLES ABLES S NE underground s Care must ations, trenches es such as sec ctions. Wherewe work begins. t No. g Unit Title IDOKI CONCR Ø STEE T PIPEL G Title D LON CROS As Sho paper siz	agineer SERVICE DATE DATE DATE DATE Services affector be taken dur setc., to avoid wers, drains, c er possible th WS 7 D732 EWS JHLE PART NOF A ETE RE L INLET INES A WORK S SEC own ze : A0 mghulam	NORTH S CHECKEI SIGNATUI SIGNATUI ted by new const ing excavations for d damage to under ables, watermains here must be loca 7400 75000 7500 7500 75000 75000 75000 75000 7500	POINT D – RE ruction are or road erground and ated CVOIR CORCED STEEL CIATED May 2021
Revision NOTE: No cor commence i acquisitions Acquisit complet Date UNDERC SERVIC S.W DRAINS SEWERS WATERMAINS TELKOM CAR ELECTRIC C. S.A.R CABLE OIL PIPE LII NOTE: Only u shown founda service connect before ROALE Project Plannin, Project THAN CONSTE Drawing CONSTE Scales : Original Designed Checked	Date Instruction we until land an have been of tions ted: En GROUND E BLES ABLES ABLES S NE underground s Care must ations,trenches es such as sections. Whereve work begins. Title IDOKI CONCR Ø STEE TONC CONCR Ø STEE TONC As Sho	agineer SERVICE DATE DATE DATE DATE DATE Services affector be taken dur setc. to avoid evers, drains, c er possible th WS 7 D732 EWS JHLE PART NOF A ETE RE L INLET INES A WORK S SEC DVR CETE RE L INLET INES A WORK S SEC DVN Ze : A0 mghulam orun	NORTH S CHECKEI SIGNATU SIGNATU SIGNATU ted by new const ing excavations for d damage to undu ables, watermains nese must be loca 7400 740	POINT D – RE ruction are or road erground and ated CVOIR CORCED STEEL CIATED May 2021
Revision NOTE: No cor commence i acquisitions Acquisit complet Date UNDERC SERVIC S.W DRAINS SEWERS WATERMAINS TELKOM CAR ELECTRIC C. S.A.R CABLE OIL PIPE LII NOTE: Only u shown founda service connect before ROALE Project Plannin, Project THAN CONSTE Drawing CONSTE Scales : Original Designed Checked	Date Instruction we until land and have been of tions ted: En GROUND E BLES ABLES BLES ABLES S NE underground s Care must ations, trenches es such as sec ctions. Wherewe work begins. t No. g Unit Title IDOKI CONCR Ø STEE T PIPEL G STEE T PIPEL G STEE T PIPEL G STEE T DIOKI CONCR Ø STEE T DIOKI CONCR B S S S S S S S S S S S S S	agineer SERVICE DATE DATE DATE DATE DATE Services affector be taken dur setc. to avoid evers, drains, c er possible th WS 7 D732 EWS JHLE PART NOF A ETE RE L INLET INES A WORK S SEC DVR CETE RE L INLET INES A WORK S SEC DVN Ze : A0 mghulam orun	NORTH S CHECKEI SIGNATU SIGNATU SIGNATU ted by new const ing excavations for d damage to undu ables, watermains nese must be loca 7400 740	POINT D – RE ruction are or road erground and ated CVOIR CORCED STEEL CIATED May 2021
Revision NOTE: No cor commence acquisitions Acquisit complet Date UNDERC SERVIC S.W DRAINS SEWERS WATERMAINS TELKOM CAB ELECTRIC C. S.A.R CABLE E.S.C CABLE OIL PIPE LII NOTE: Only u shown founda service connee before ROAL Project Plannin Project THAN CONSTE Drawing CONSTE Scales : Original Designed Checked Area Eng	Date nstruction we until land an have been of tions ted: En GROUND E BLES ABLES BLES ABLES S NE underground s Care must ations, trenches es such as sec ctions. Whereve work begins. t No. g Unit Title IDOKI CONCR Ø STEE T PIPEL G STEE T PIPEL G STEE T PIPEL G STEE T DIOKI CONCR Ø STEE T DIOKI CONCR B B C DIOKI C	agineer SERVICE DATE DATE DATE DATE DATE Services affector be taken dur setc. to avoid evers, drains, c er possible th WS 7 D732 EWS JHLE PART NOF A ETE RE L INLET INES A WORK S SEC DVR CETE RE L INLET INES A WORK S SEC DVN Ze : A0 mghulam orun	NORTH S CHECKEI SIGNATU SIGNATU SIGNATU ted by new const ing excavations for d damage to undu ables, watermains nese must be loca 7400 740	POINT D – RE ruction are or road erground and ated CVOIR CORCED STEEL CIATED May 2021
Revision NOTE: No cor commence acquisitions Acquisit complet Date UNDERC SERVIC S.W DRAINS SEWERS WATERMAINS TELKOM CAR ELECTRIC C. S.A.R CABLE E.S.C CABLE OIL PIPE LII NOTE: Only u shown founda service connec before Contrac Project Plannin Project THAN CONSTE Director	Date nstruction we until land an have been of tions ted: En CROUND E BLES BLES ABLES S NE underground s Care must ations,trenches es such as sec ctions. Whereve work begins. t No. g Unit Title IDOKI CONCR Ø STEE T PIPEL G STEE T PIPEL G STEE T PIPEL G STEE T DIOKI CONCR Ø STEE T DIOKI (W.D.) (Water)	agineer SERVICE DATE DATE DATE DATE DATE Services affector be taken dur services affector be taken dur setc., to avoid ewers, drains, c er possible th WS 7 D732 EWS JHLE PART N OF A ETE RE L INLET INES A WORK S SEC DYN 2 C : A0 mghulam orun 0.)	NORTH S CHECKEI SIGNATUI SIGNATUI I SIGNATUI I SI	POINT D - RE ruction are or road erground and ated CVOIR CORCED STEEL CIATED May 2021 J. Adams
Revision NOTE: No cor commence acquisitions Acquisit complet Date UNDERC SERVIC S.W DRAINS SEWERS WATERMAINS TELKOM CAR ELECTRIC C. S.A.R CABLE E.S.C CABLE OIL PIPE LII NOTE: Only u shown founda service connec before Contrac Project Plannin Project THAN CONSTE Director	Date nstruction we until land an have been of tions ted: En CROUND E BLES BLES ABLES S NE underground s Care must ations,trenches es such as sec ctions. Whereve work begins. t No. g Unit Title IDOKI CONCR Ø STEE T PIPEL G Title D LON CONCR Ø STEE T PIPEL G Title D LON CONCR Ø STEE T PIPEL G S As Sho paper siz : A. Go gineer (W. (W. D.) (Water)	Agineer SERVICE DATE DATE DATE DATE DATE ATE DATE	NORTH S CHECKEI SIGNATU SIGNATU SIGNATU ted by new const ing excavations for d damage to undu ables, watermains nese must be loca 7400 740	POINT D - RE ruction are or road erground and ated CVOIR CORCED STEEL CIATED May 2021 J. Adams

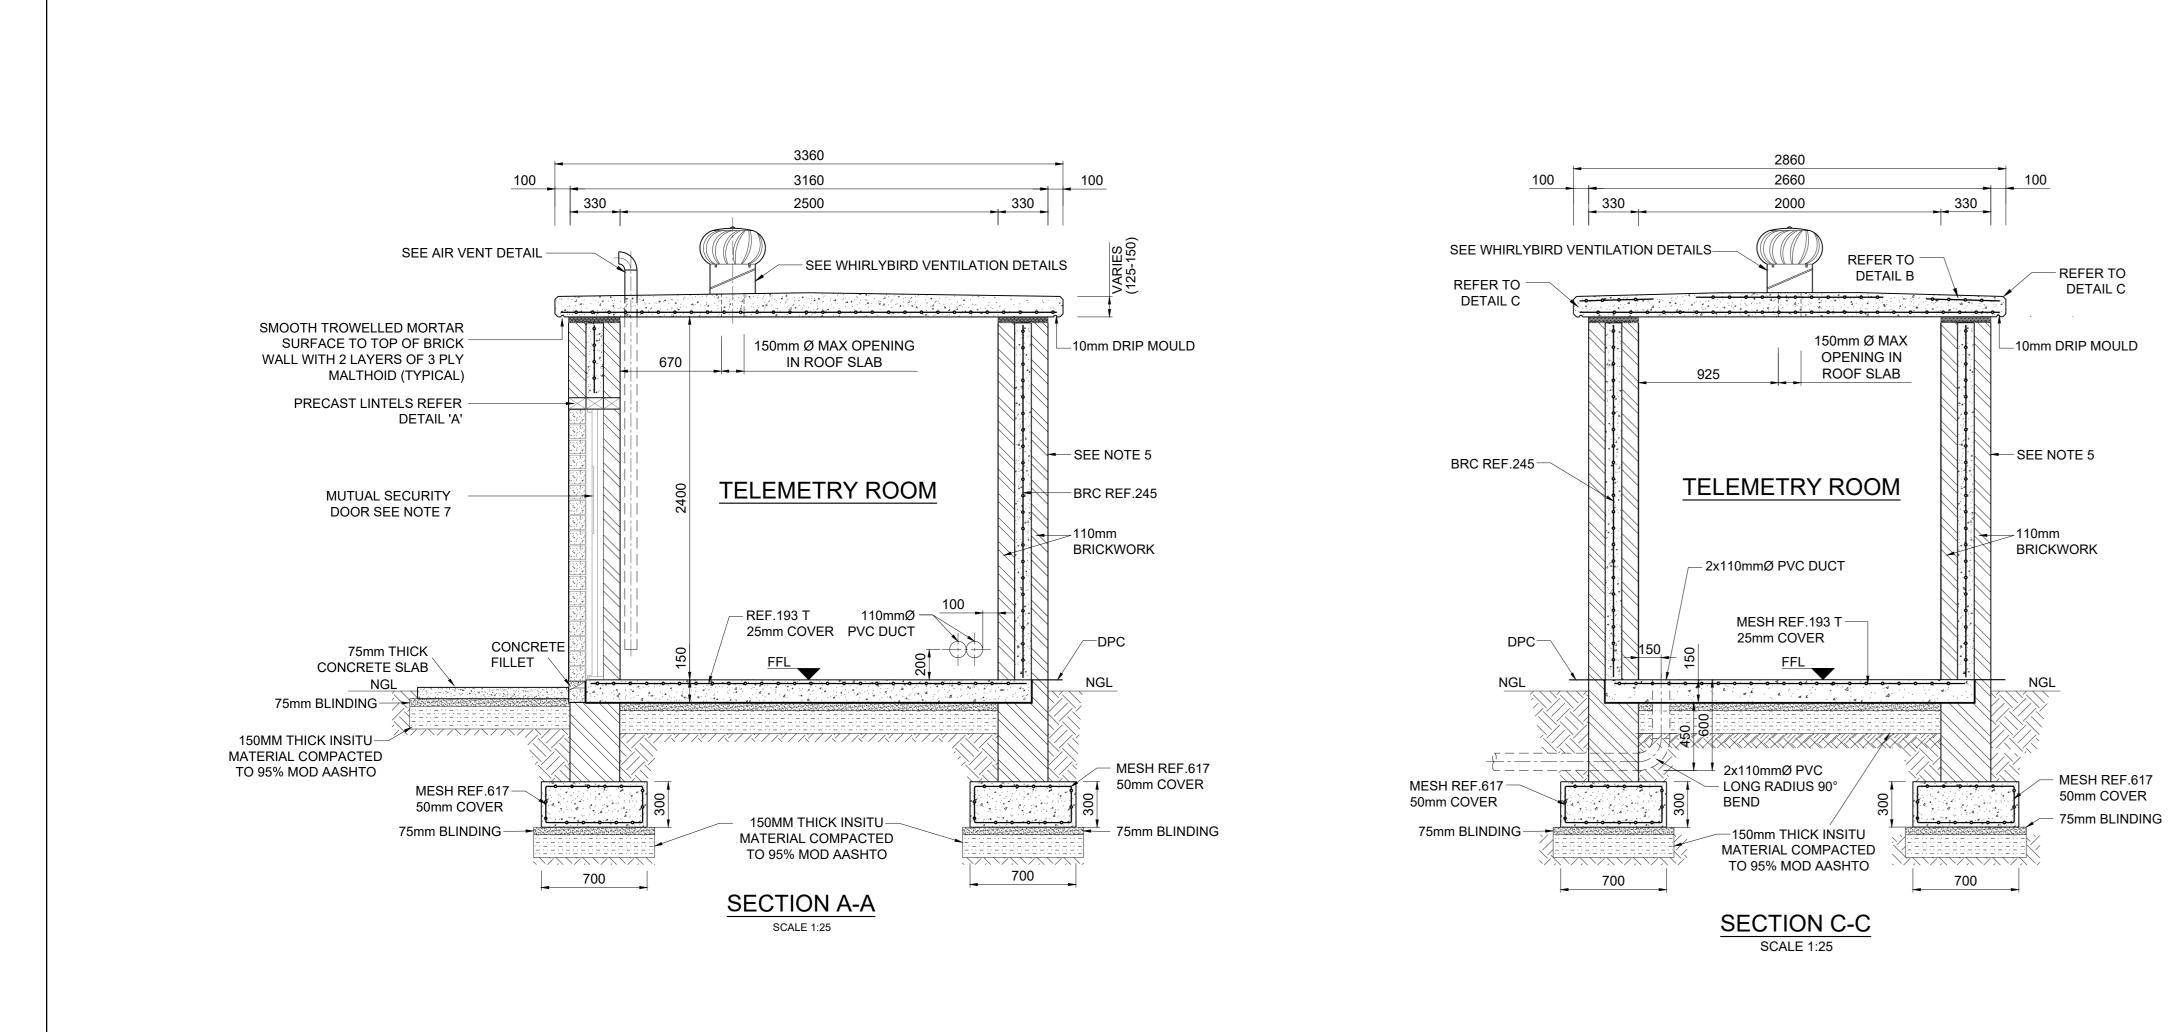


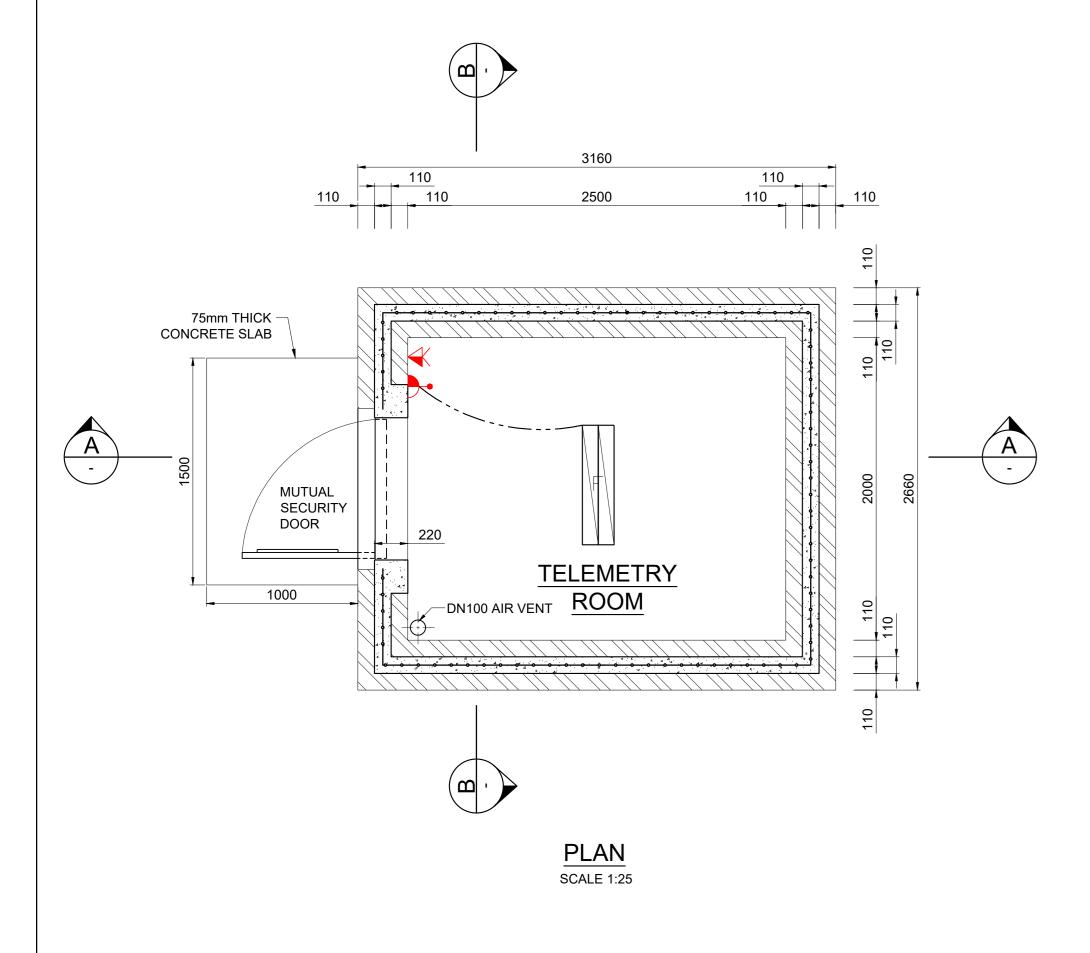


ELECTR	ICAL SCH	EDULE / LEGEND
SYMBOL	No. OFF	DESCRIPTION / CODE
	1	2 x SINGLE PLUG POINTS: ONE PLUG TO BE FOR DC (WHITE PLUG) & ONE PLUG FOR UNINTERRUPTED POWER SUPPLY (RED UPS PLUG)
	1	WALL LIGHT SWITCH AS INDICATED
	1	58W DOUBLE FLOURECENT LIGHT

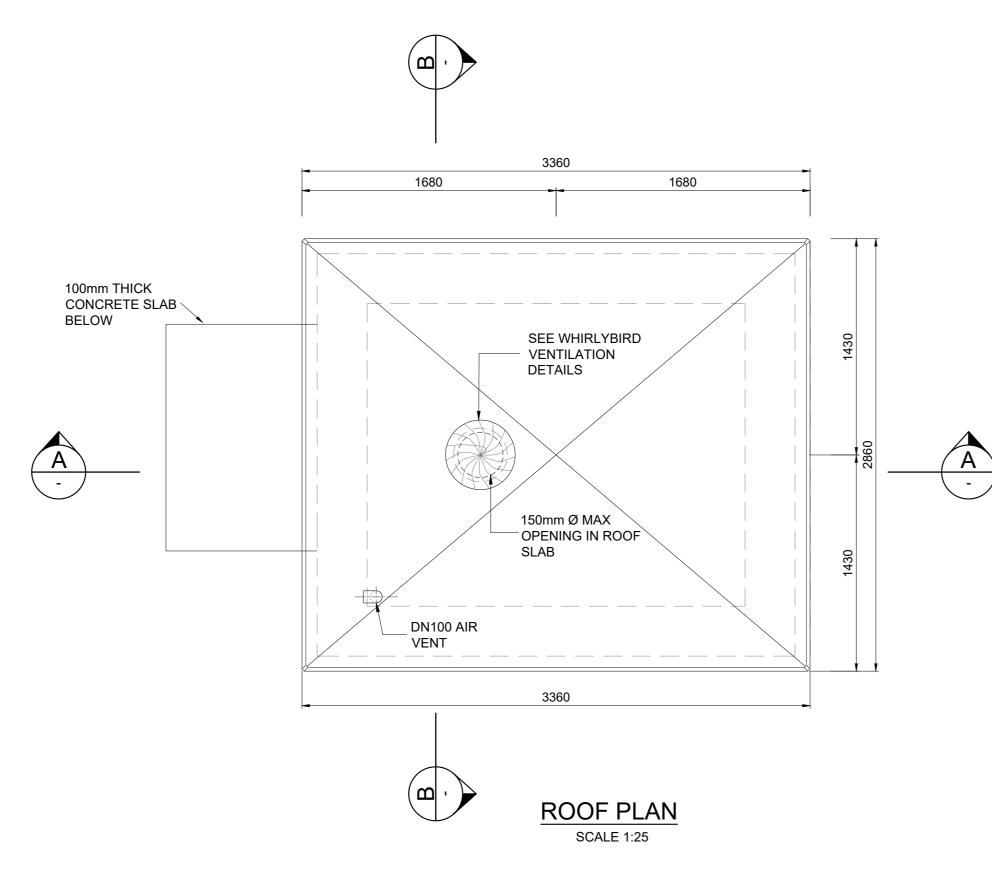

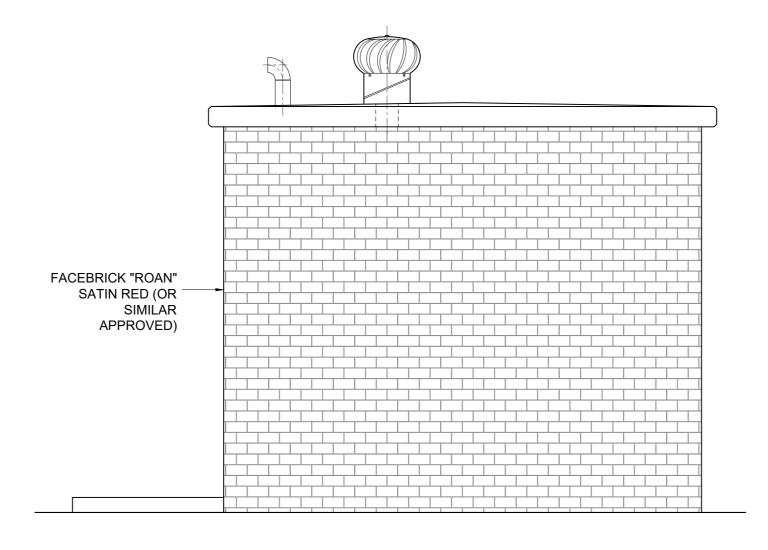


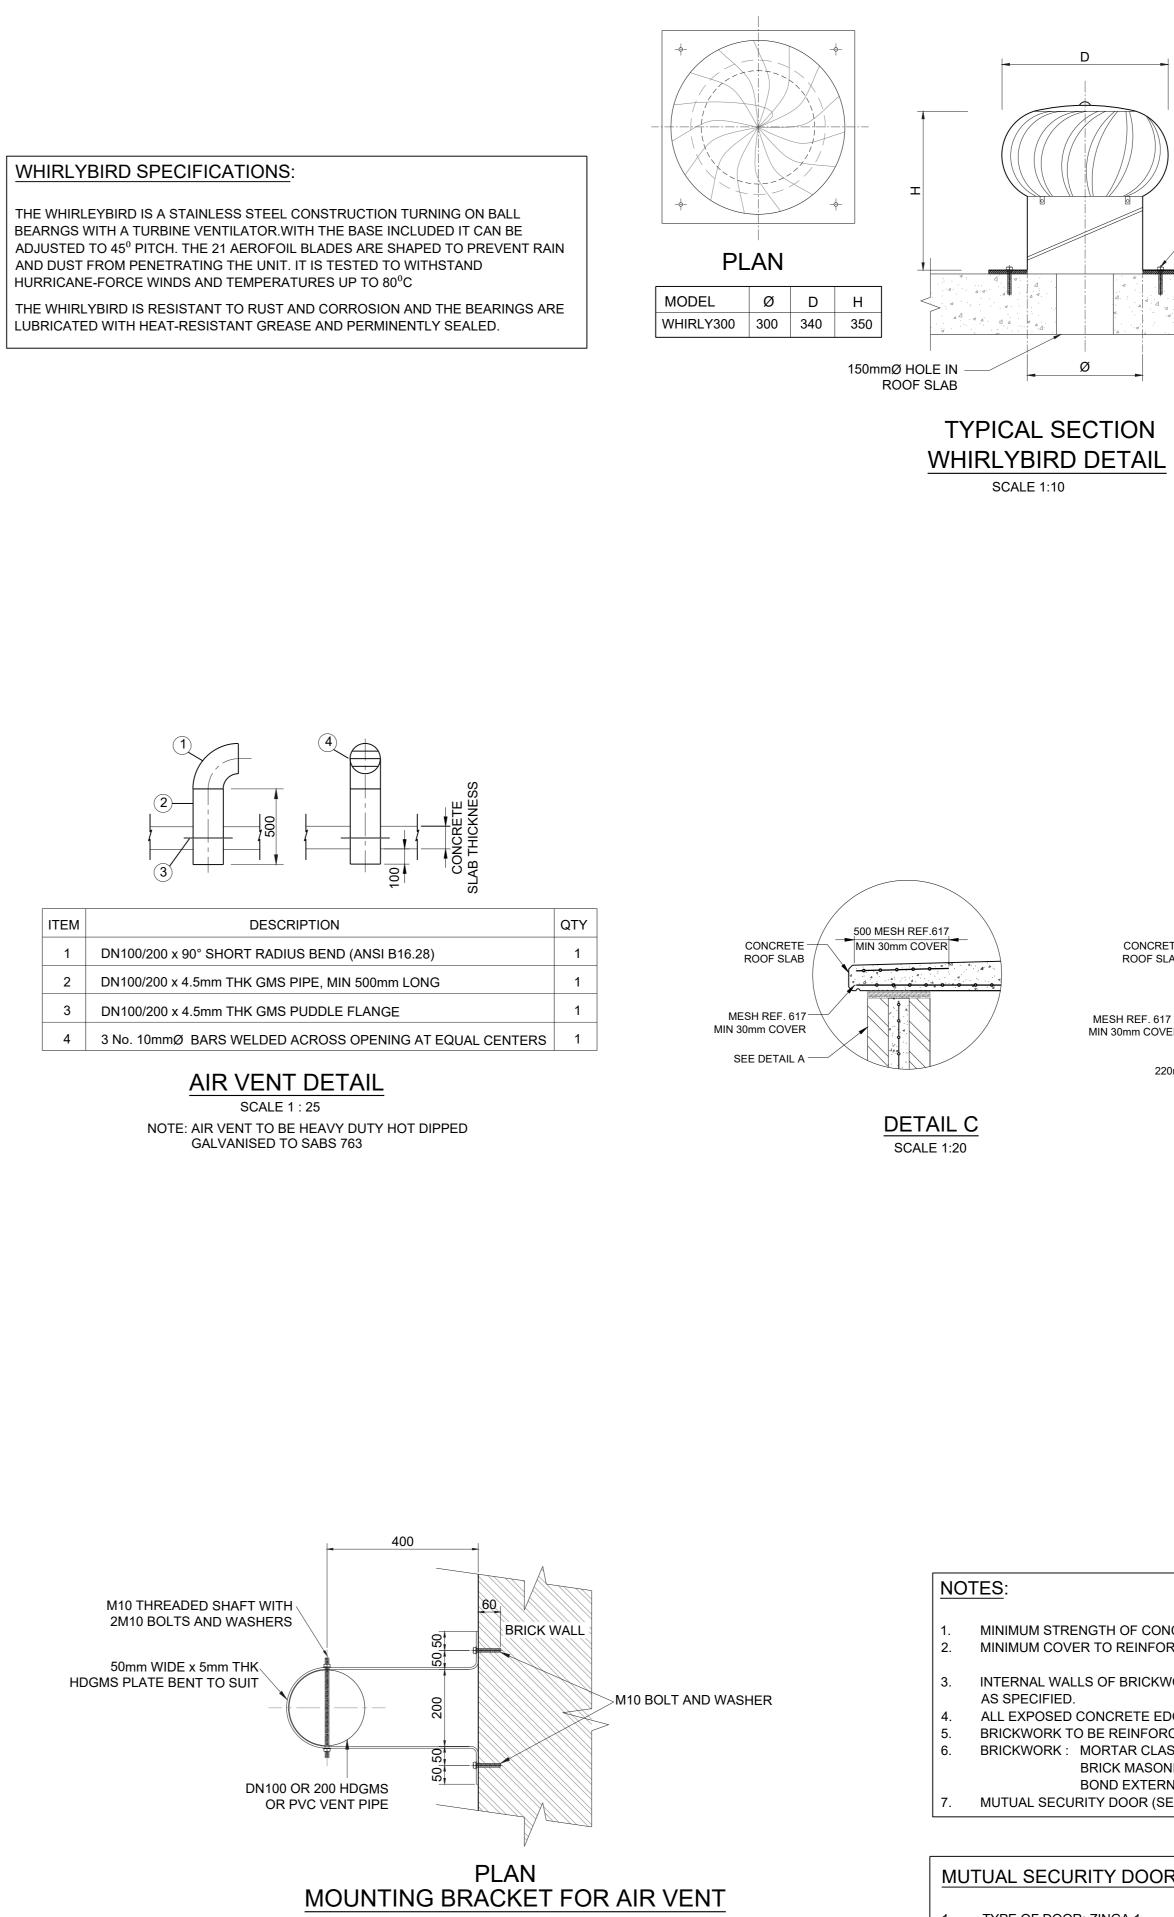


SCALE 1:10

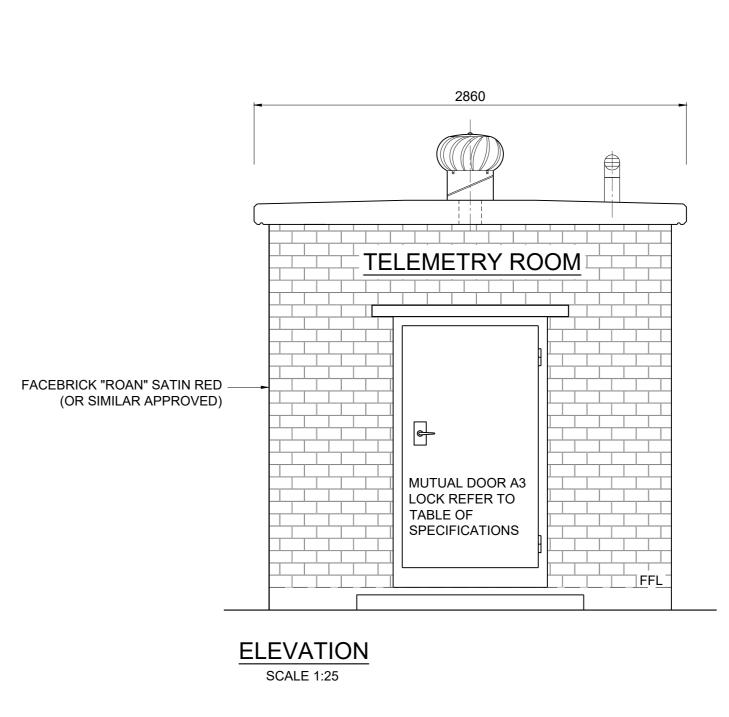


	eTHEKWINI WATER SERVICES WATER DESIGN BRANCH eTHEKWINI
SS CHEMICAL ANCHOR APPROVED GROUT POLYURETHANE SEALANT (SIKAFLEX 11 FC)	REDUCED PLAN USE SCALE BELOW 0 10 20 30 40 50 60 70 U U U U U U U U U U U U U U U U U U U
CONCRETE ROOF SLAB YPICAL SECTION <u>IIRLYBIRD DETAIL</u> SCALE 1:10	CONSULTANT:
	1st Floor Tel: +27 (0) 31 265 6007 No.5 The Boulevard Fax: +27 (0) 31 265 6011 West Way Office Park E-mail: info@naiduconsulting.com Westville, Durban DRAWING NO.:- D732-52-5260 DRAWING NO.:- D732-52-5260 EPOR TEENDER Ref Drg. Description 60356/002 RESERVOIR SITE PLAN LAYOUT 1 of 1 60356/009 STANDARD ASSOCIATED DETAILS 1 of 2 60356/009 STANDARD ASSOCIATED DETAILS 2 of 2
C00<	
DTES: MINIMUM STRENGTH OF CONCRETE TO BE 25 MPa AT 28 DAYS. MINIMUM COVER TO REINFORCING : ROOF SLAB - 30mm FLOOR SLAB AND FOUNDATIONS - 50mm INTERNAL WALLS OF BRICKWORK ARE TO BE PLASTERED AND THEN PAINTED AS SPECIFIED. ALL EXPOSED CONCRETE EDGES TO HAVE A 25mm X 25mm CHAMFER. BRICKWORK TO BE REINFORCED WITH BRICKFORCE EVERY SECOND COURSE. BRICKWORK TO BE REINFORCED WITH BRICKFORCE EVERY SECOND COURSE. BRICKWORK : MORTAR CLASS :- II BRICK MASONRY BOND :- STREATCHER BOND EXTERNAL :- "ROAN" SATIN RED FACEBRICK MUTUAL SECURITY DOOR (SEE NOTES)	Standard Drawings 0 OCT 2021 FOR TENDER PURPOSES ONLY Revision Date Description NOTE: No construction work to commence until land and servitude acquisitions have been completed Acquisitions completed: Date NORTH POINT UNDERGROUND Description
UTUAL SECURITY DOOR SPECIFICATIONS: TYPE OF DOOR: ZINGA 1. ALL DOORS TO BE SUPPLIED AND INSTALLED COMPLETE WITH OUTER FRAMES. THE DOOR FINISH: TO BE HOT DIPPED GALVANIZED. DOOR HANDLING: DOORS WILL BE RIGHT HAND HINGED HANDLE: THE DOOR IS TO BE FITTED WITH A REMOVABLE DOOR HANDLE. THE WALL OPENING SIZE FOR THE FITMENT OF THE MUTUAL SAFE DOOR. LOCKING (TELEMETRY ROOM ONLY): THE MUTUAL SAFE DOOR IS TO BE FITTED WITH A MULTI LOCK TYPE CODE A380 AL (AVAILABLE FROM AA LOCKSMITHS). SAMPLE KEY TO BE PROVIDED BY EWS ON REQUEST. LOCKING MECHANISM PROTECTION (TELEMETRY ROOM ONLY): LOCK TO BE PROTECTED AS PER EWS STANDARDS (SUPPLIER IS AWARE OF DETAILS).	SERVICE DATE SIGNATURE S.W DRAINS
	Contract No. Project No. Planning Unit EWS Project Title THANDOKUHLE RESERVOIR COMPARTMENT 1 CONSTRUCTION OF A 3ML REINFORCED CONCRETE RESERVOIR, 150mm Ø STEEL INLET, 300mm Ø STEEL OUTLET PIPELINES AND ASSOCIATED WORKS Drawing Title Scales : As Shown Original paper size : A0 Designed : K. Holmes Date : May 2021 Checked : G. Simpson Checked : G. Simpson Area Engineer (W.O.) Manager (W.D.) Director (Water) E. Msweli - Head: Water & Sanitation Unit 60356/019 1 of 1 0 Rev.

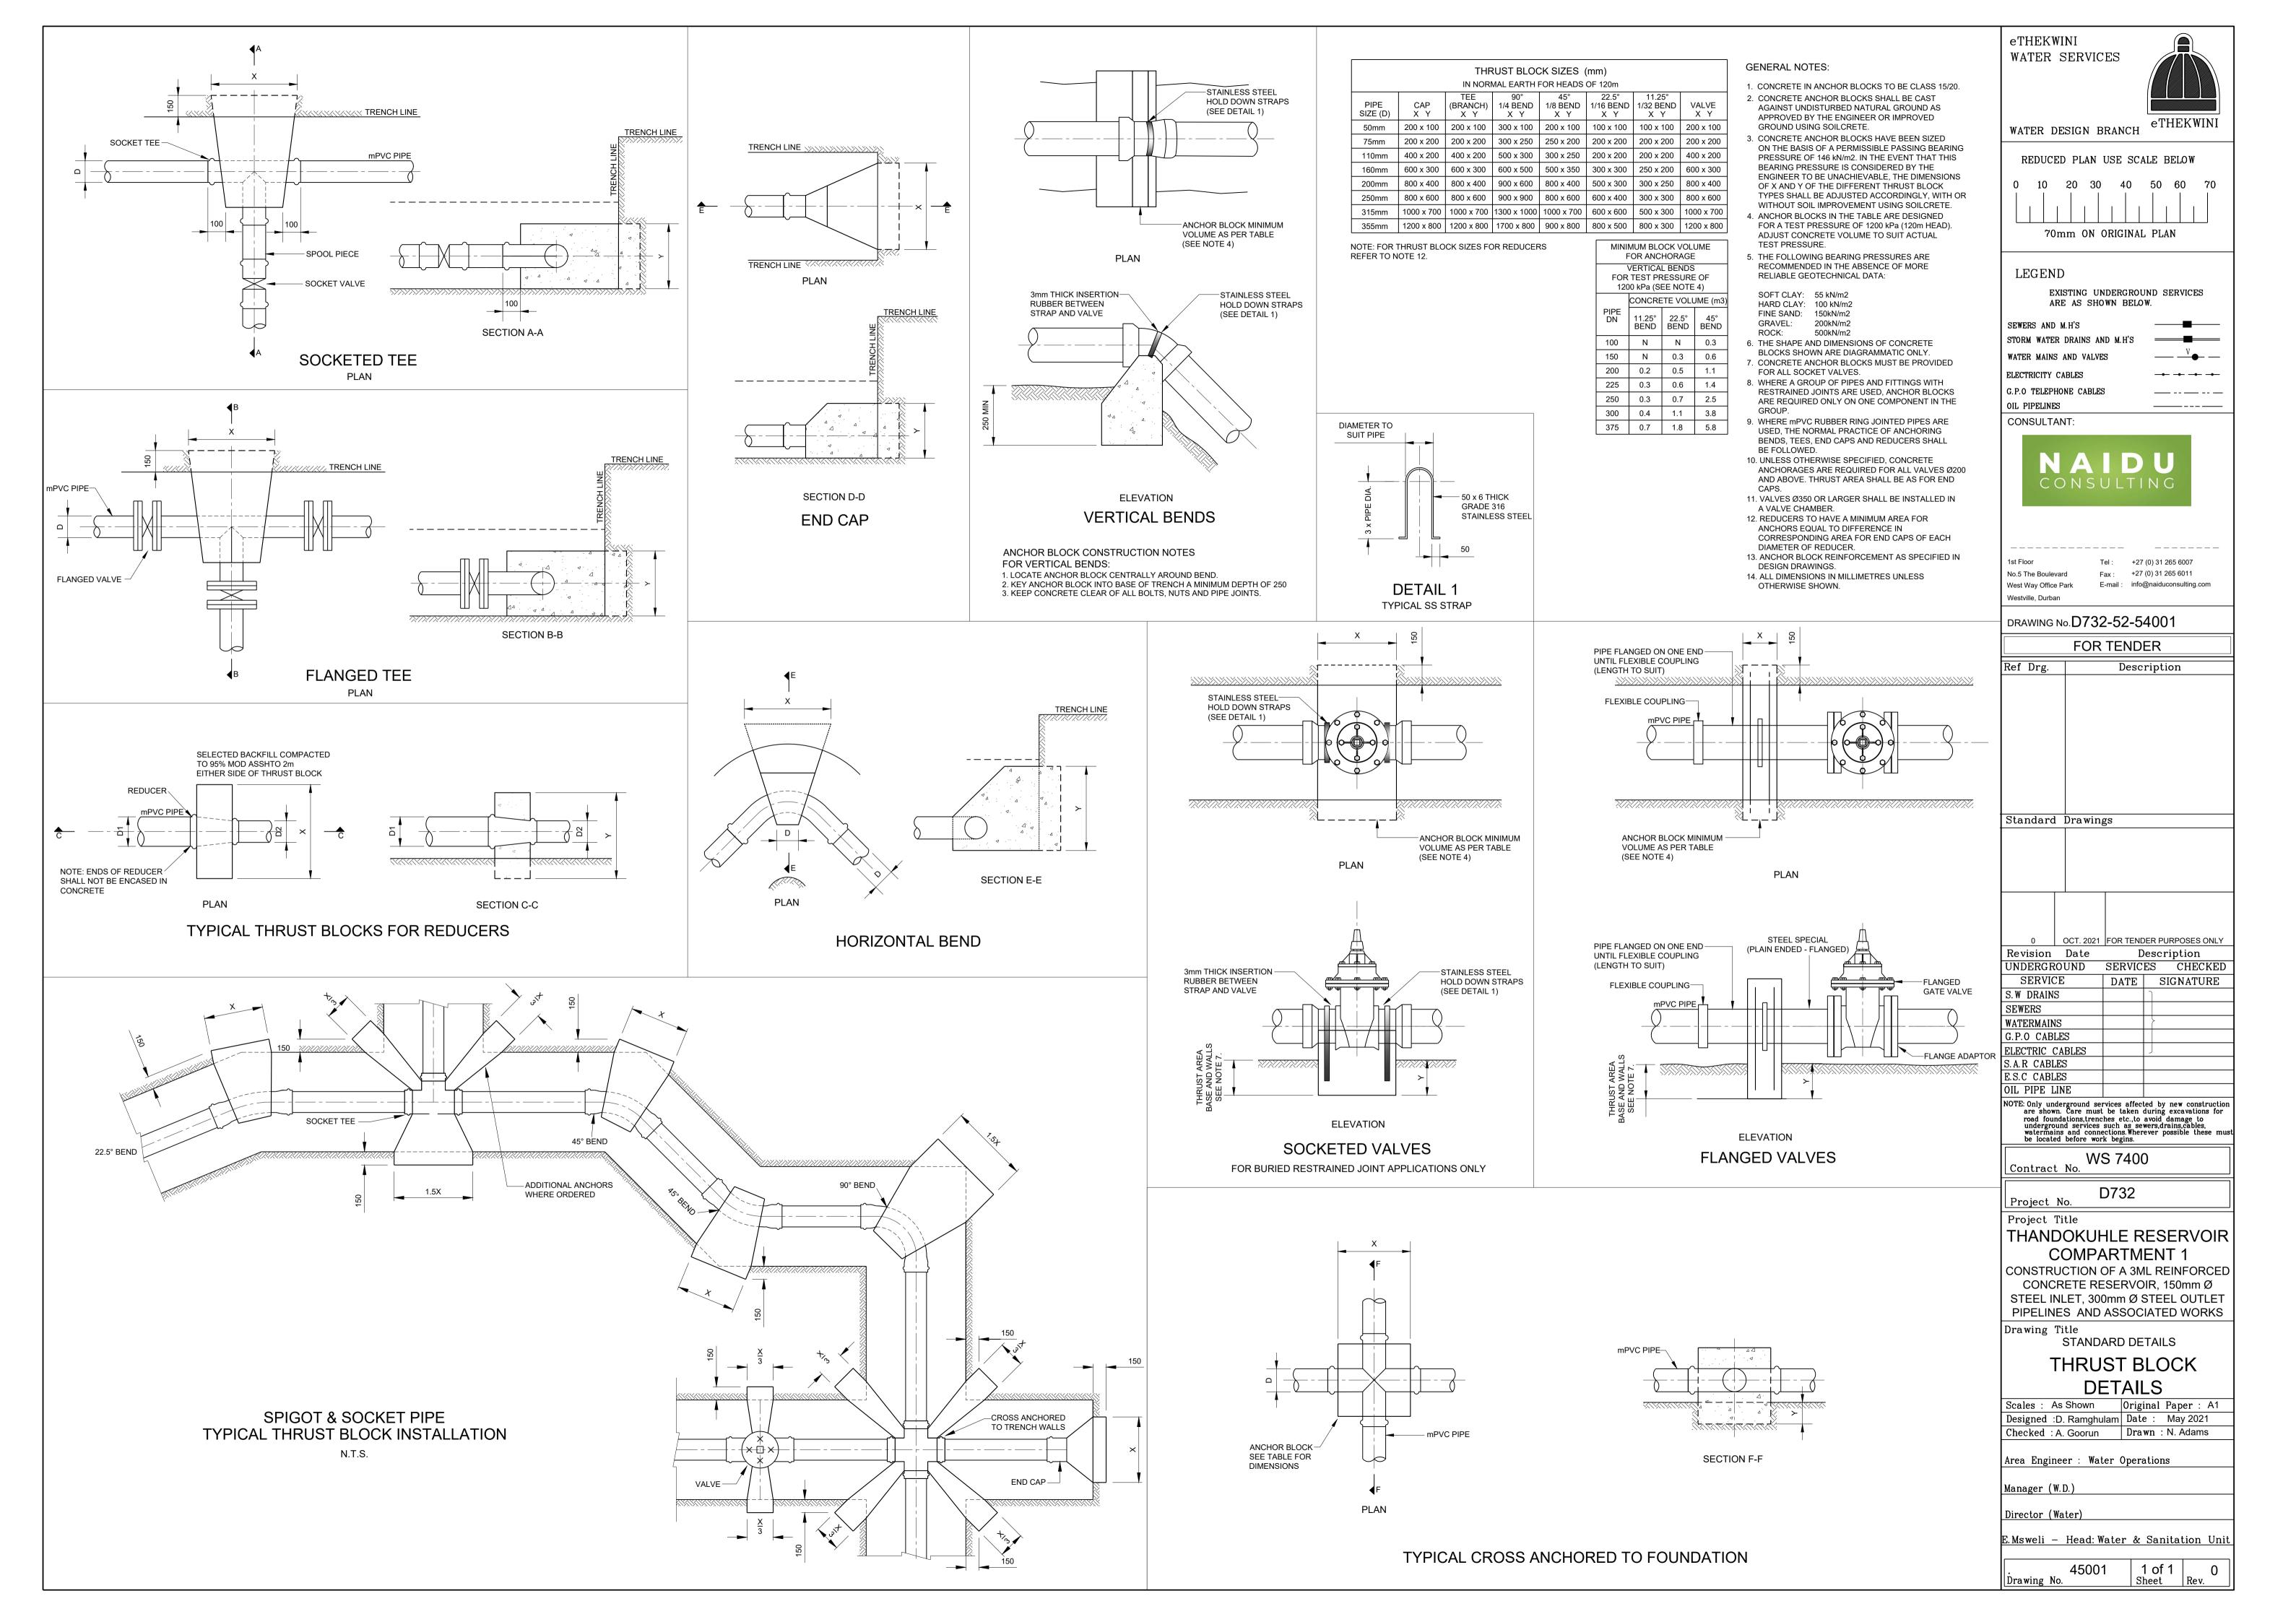


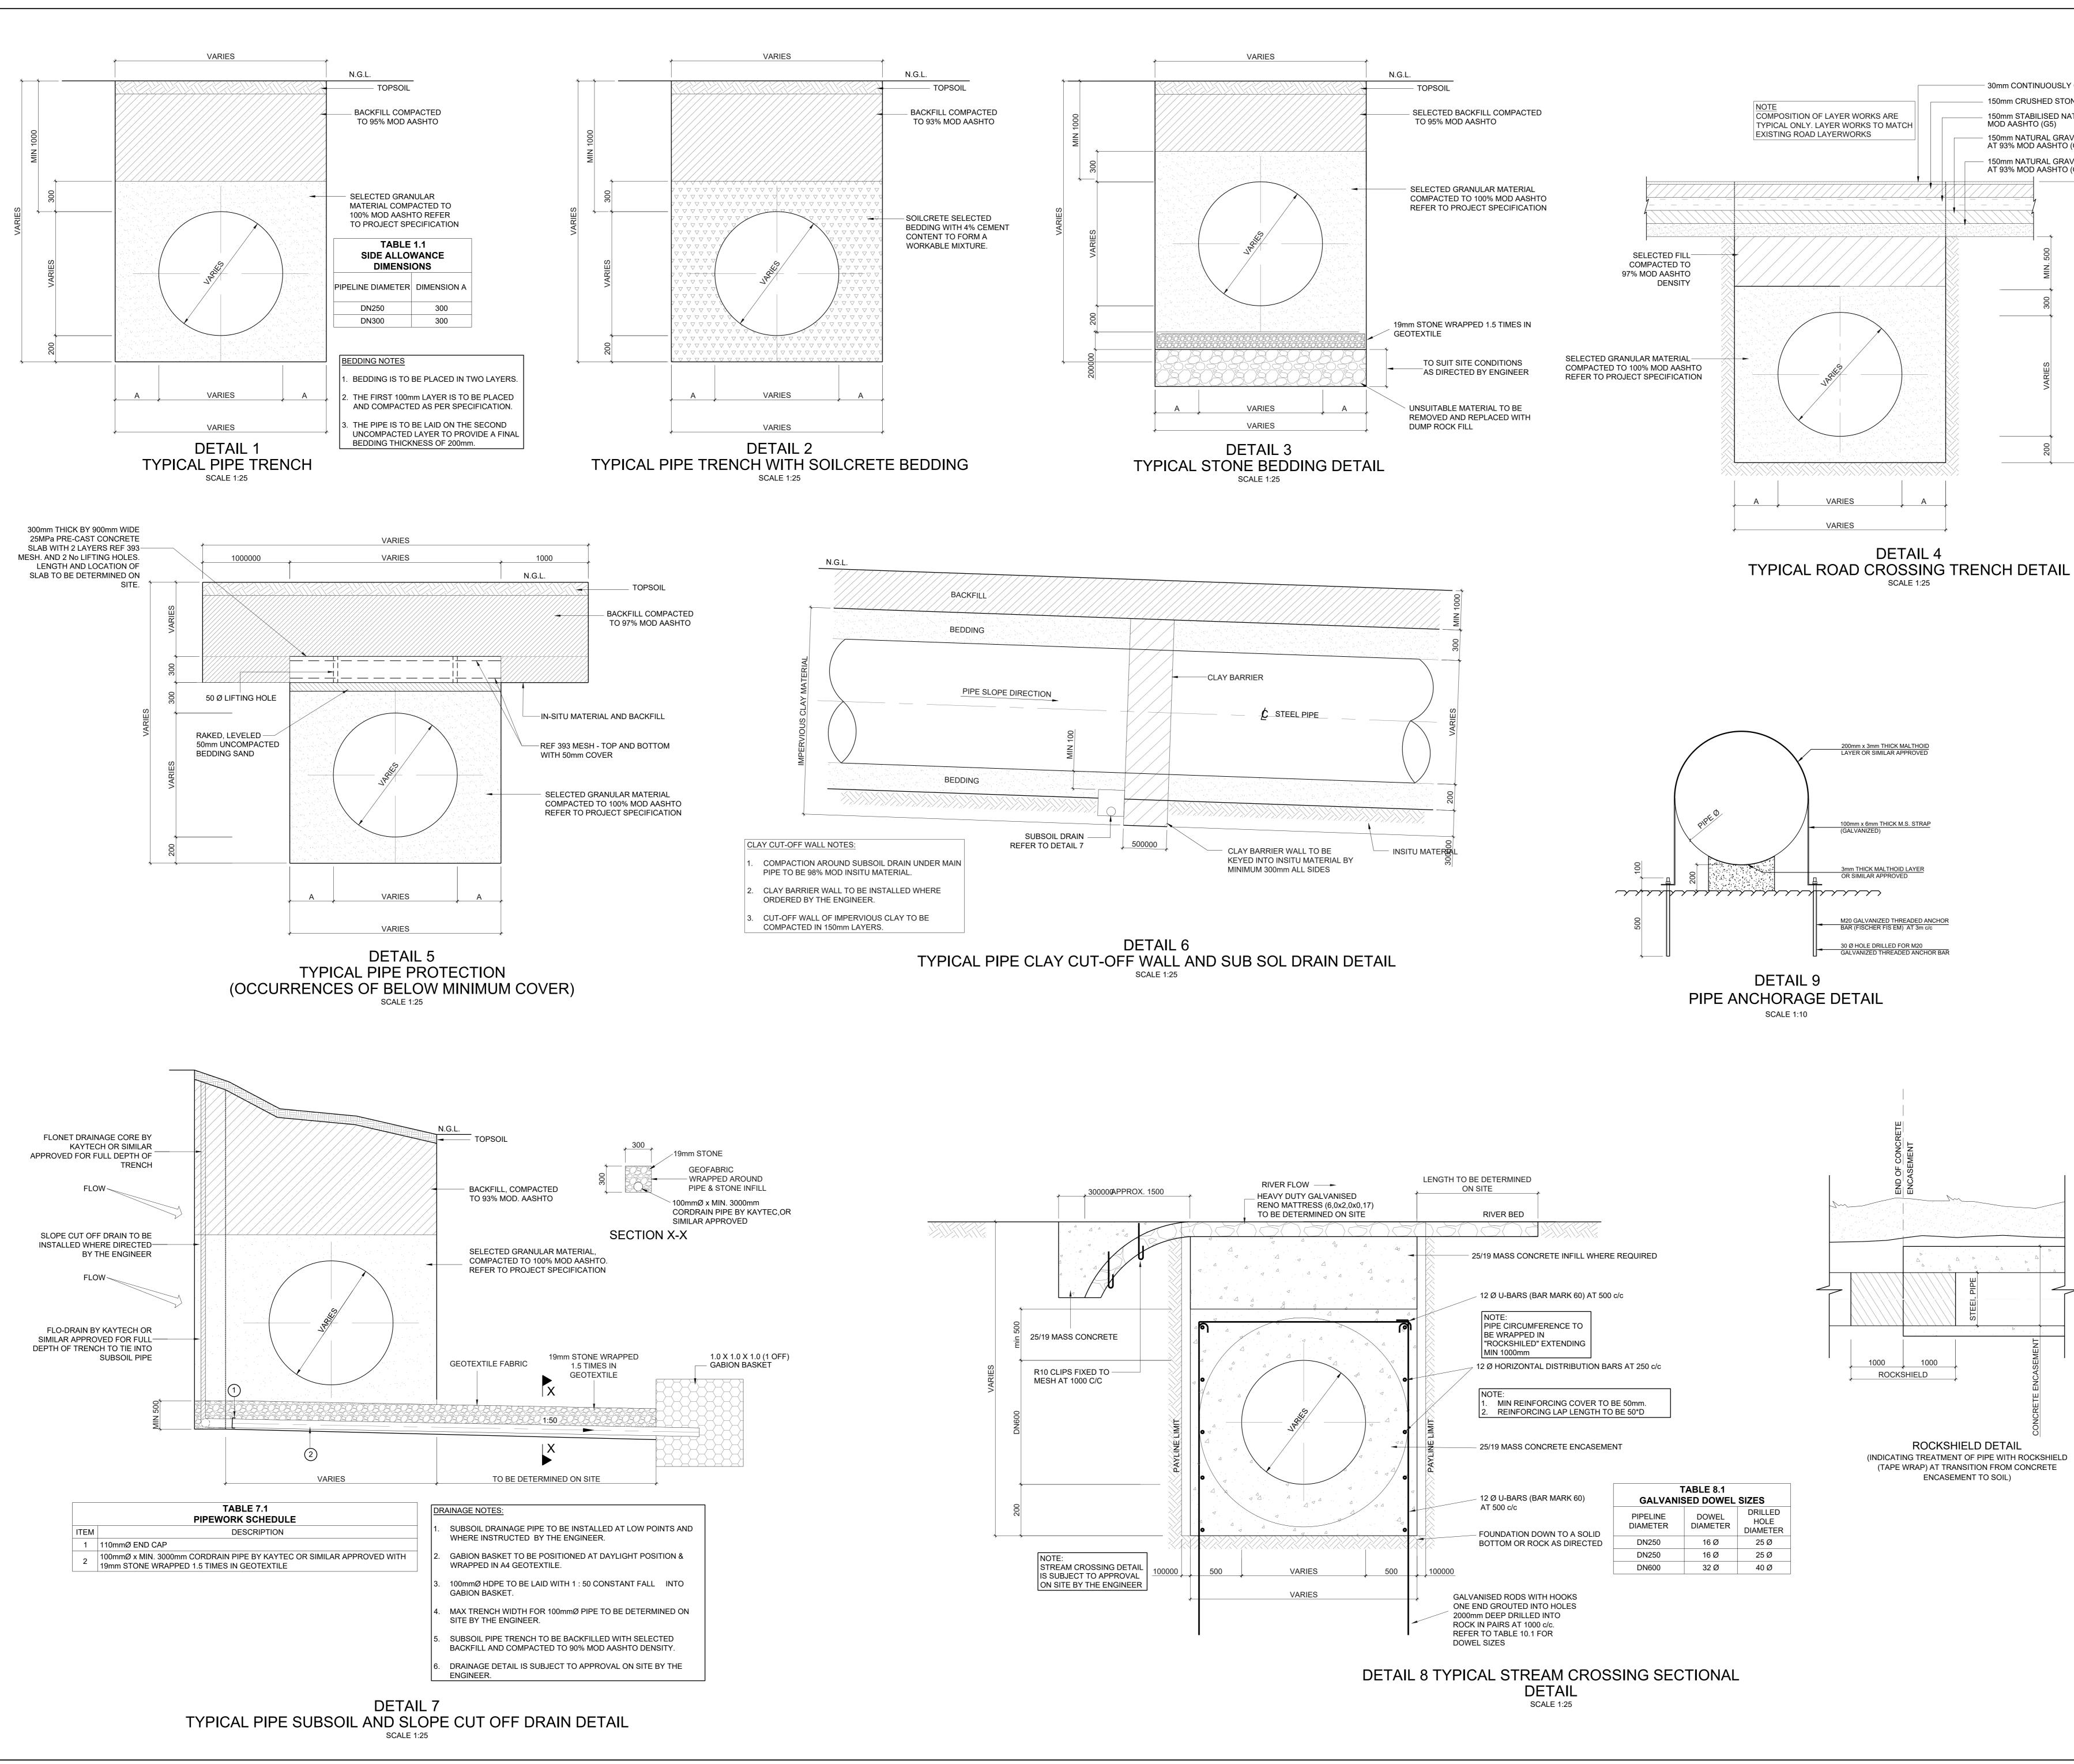





- 30mm CONTINUOUSLY GRADED ASPHALT SURFACING (AC) 150mm CRUSHED STONE BASE AT 98% MOD AASHTO (G1) 150mm STABILISED NATURAL GRAVEL SUBBASE AT 98% MOD AASHTO (G5) 150mm NATURAL GRAVEL SUBGRADE - UPPER SELECTED AT 93% MOD AASHTO (G7) — 150mm NATURAL GRAVEL SUBGRADE - LOWER SELECTED AT 93% MOD AASHTO (G9)

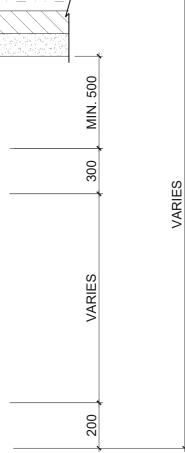


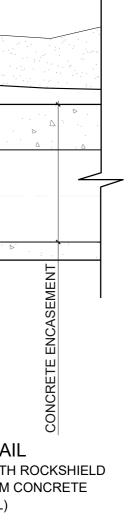


eTHEKWINI WATER SERVICES	
WATER DESIGN BRANCH	eTHEKWINI
REDUCED PLAN US	E SCALE BELOW
0 10 20 30	40 50 60 70
70mm ON OR	IGINAL PLAN
CONSULTANT:	
ΝΑΙ	DU
N A I C O N S U	LTING
	+27 (0) 31 265 6007
, , , , , , , , , , , , , , , , , , ,	+27 (0) 31 265 6011 : info@naiduconsulting.com
Westville, Durban DRAWING No.: D732-52	2-45002
Ref Drg. De	NDER
60356/006 Inlet, Outlet & Stor Long Sections	-
Standard Drawings	
Reinforcing Ref. Drawin	gs
Geotech Ref. Drawings	
000 00 000 001	
	l of Ground Improvement for osed Reservoir
Prop	osed Reservoir
0 OCT 2021 FOR Revision Date	
0 OCT 2021 FOR	TENDER PURPOSES ONLY Description
O OCT 2021 FOR Revision Date NOTE: No construction work to commence until land and servitu	TENDER PURPOSES ONLY Description
0 OCT 2021 FOR Revision Date NOTE: No construction work to commence until land and servitu acquisitions have been completed Acquisitions completed: Date Engineer UNDERGROUND	TENDER PURPOSES ONLY Description de NORTH POINT CES CHECKED -
0 OCT 2021 FOR 0 OCT 2021 FOR Revision Date NOTE: No construction work to commence until land and servitu acquisitions have been completed Acquisitions completed: Date Engineer	TENDER PURPOSES ONLY Description de NORTH POINT
OOCT 2021FOR0OCT 2021FORRevision DateNOTE: No construction work to commence until land and servitu acquisitions have been completedAcquisitions completed:Acquisitions servitu acquisitions completed:DateEngineerUNDERGROUNDSERVICDateEngineerUNDERGROUNDSERVICSERVICEDATES. W DRAINSISEWERSIWATERMAINSITELKOM CABLESI	TENDER PURPOSES ONLY Description de NORTH POINT CES CHECKED -
0 OCT 2021 FOR 0 OCT 2021 FOR Revision Date NOTE: No construction work to commence until land and servitu acquisitions have been completed Acquisitions completed: Acquisitions completed: Date Engineer UNDERGROUND SERVICE SERVICE DATE S.W DRAINS SEWERS WATERMAINS I	TENDER PURPOSES ONLY Description de NORTH POINT CES CHECKED -
0 OCT 2021 FOR 0 OCT 2021 FOR Revision Date NOTE: No construction work to commence until land and servitu acquisitions have been completed Acquisitions completed: Date Engineer UNDERGROUND SERVICE DATE S.W DRAINS SERVICE SEWERS WATERMAINS Image: Service Image: Service TELKOM CABLES Image: Service Image: Service Image: Service S.A.R CABLES Image: Service Image: Service Image: Service	TENDER PURPOSES ONLY Description de NORTH POINT CES CHECKED - SIGNATURE
0 OCT 2021 FOR Revision Date NOTE: No construction work to commence until land and servitu acquisitions have been completed Acquisitions completed: Date Engineer UNDERGROUND SERVIC SERVICE DATE S.W DRAINS SEWERS DATE S.W DRAINS SEWERS S WATERMAINS TELKOM CABLES ELECTRIC CABLES S.A.R CABLES E.S.C CABLES S.A.R CABLES E.S.C CABLES DIL PIPE LINE NOTE: Only underground services af shown. Care must be taken of foundations,trenches etc., to a services such as sewers, drain connections. Wherever possible	Description de NORTH POINT CES CHECKED SIGNATURE Image: Signature
0 OCT 2021 FOR Revision Date NOTE: No construction work to commence until land and servitu acquisitions have been completed Acquisitions completed: Date Engineer UNDERGROUND SERVIC SERVICE DATE S.W DRAINS DATE S.W DRAINS SEWERS DATE S.W DRAINS SEWERS DATE S.A.R CABLES ELECTRIC CABLES ELECTRIC CABLES S.A.R CABLES DATE S.A.R CABLES E.S.C CABLES E.S.C CABLES DIL PIPE LINE NOTE: Only underground services af shown. Care must be taken of foundations,trenches etc., to a services such as sewers,drain connections. Wherever possible before work begins.	Description de NORTH POINT CES CHECKED SIGNATURE
0 OCT 2021 FOR Revision Date NOTE: No construction work to commence until land and servitu acquisitions have been completed Acquisitions completed: Date Engineer UNDERGROUND SERVIC SERVICE DATE S.W DRAINS SEWERS DATE S.W DRAINS SEWERS SEVERS WATERMAINS TELKOM CABLES ELECTRIC CABLES S.A.R CABLES E.S.C CABLES E.S.C CABLES S.A.R CABLES E.S.C CABLES S.A.R CABLES E.S.C CABLES DIL PIPE LINE NOTE: Only underground services af shown. Care must be taken of foundations, trenches etc., to a services such as sewers, drain connections. Wherever possible before work begins.	Description de NORTH POINT CES CHECKED SIGNATURE Image: Signature
0 OCT 2021 FOR Revision Date NOTE: No construction work to commence until land and servitu acquisitions have been completed Acquisitions completed: Date Engineer UNDERGROUND SERVIC SERVICE DATE S. W DRAINS SERVICE SEWERS WATERMAINS TELKOM CABLES ELECTRIC CABLES E.S. C CABLES SA.R CABLES OIL PIPE LINE NOTE: Only underground services af shown. Care must be taken of foundations, trenches etc., to a services such as sewers, drain connections. Wherever possible before work begins. Contract No. WXS	Description de NORTH POINT CES CHECKED SIGNATURE
0 OCT 2021 FOR Revision Date NOTE: No construction work to commence until land and servitu acquisitions have been completed Acquisitions completed: Date Engineer UNDERGROUND SERVIC SERVICE DATE S.W DRAINS SEWERS WATERMAINS SEWERS SA.R CABLES ELECTRIC CABLES S.A.R CABLES S.A.R CABLES S.A.R CABLES OIL PIPE LINE NOTE: Only underground services af shown. Care must be taken of foundations, trenches etc., to a services such as sewers, drain connections. Wherever possible before work begins. VVS Contract No. VVS Project No. Planning Unit	TENDER PURPOSES ONLY Description de NORTH POINT CES CHECKED - SIGNATURE fected by new construction are during excavations for road void damage to underground is, cables, watermains and these must be located 7400 732
0 OCT 2021 FOR Revision Date NOTE: No construction work to commence until land and servitu acquisitions have been completed Acquisitions completed: Date Engineer UNDERGROUND SERVICE DATE S.W DRAINS SERVICE DATE S.W DRAINS SEWERS WATERMAINS TELKOM CABLES ELECTRIC CABLES S.A.R CABLES S.S.A.R CABLES OIL PIPE LINE NOTE: Only underground services af shown. Care must be taken of foundations, trenches etc., to a services such as sewers, drain connections. Wherever possible before work begins. MOTE: Only underground services af shown. Care must be taken of foundations, trenches etc., to a services such as sewers, drain connections. Wherever possible before work begins. VWS Contract No. Contract No. Project No. D Planning Unit	TENDER PURPOSES ONLY Description de NORTH POINT CES CHECKED - SIGNATURE Generations for road void damage to underground iscables, watermains and these must be located 7400
0 OCT 2021 FOR Revision Date NOTE No construction work to commence until land and servitu acquisitions have been completed Acquisitions completed: Date Engineer UNDERGROUND SERVIC SERVICE DATE S.W DRAINS E SEWERS WATERMAINS TELKOM CABLES E ELECTRIC CABLES S.A.R CABLES ELECTRIC CABLES S.A.R CABLES OIL PIPE LINE NOTE: Only underground services af shown. Care must be taken of foundations, trenches etc., to a services such as sewers, drain connections. Wherever possible before work begins. Contract No. WS Project No. D Planning Unit E Project Title THANDOKUHLE	TENDER PURPOSES ONLY Description de NORTH POINT CES CHECKED - SIGNATURE SIGNATURE Facted by new construction are during excavations for road void damage to underground is, cables, watermains and these must be located 7400 732 EWS ERESERVOIR
0 OCT 2021 FOR Revision Date NOTE: No construction work to commence until land and servitu acquisitions completed Acquisitions completed Acquisitions DATE Service DATE S.w DRAINS SERVICE SEWERS MATERMAINS SEWERS Services WATERMAINS SENC ELECTRIC CABLES S.A.R CABLES E.S.C CABLES Services and services af shown. Care must be taken of foundations, trenches etc., to a services such as sewers, drain connections. Wherever possible before work begins. NOTE: Only underground services af shown. Care must be taken of foundations, trenches etc., to a services such as sewers, drain connections. Wherever possible before work begins. VVS Contract No. Project No. C Planning Unit E Project Title F	TENDER PURPOSES ONLY Description de NORTH POINT CES CHECKED - SIGNATURE Facted by new construction are during excavations for road void damage to underground is,cables,watermains and these must be located 7400 732 EWS ERESERVOIR TMENT 1
0 OCT 2021 FOR Revision Date NOTE: No construction work to commence until land and servitu acquisitions have been completed Acquisitions completed: Date Engineer UNDERGROUND SERVICE DATE SERVICE DATE SW DRAINS SERVICE SEWERS MATERMAINS TELKOM CABLES ELECTRIC CABLES S.A.R CABLES ES S.A.R CABLES SE S.C. CABLES OIL PIPE LINE NOTE: Only underground services af shown. Care must be taken of foundations, trenches etc., to a services such as sewers, drain connections. Wherever possible before work begins. VVS Contract No. Project No. D Project No. D Project Title THANDOKUHLE CONSTRUCTION OF ACONSTRUCTION OF ACONSTRUCTION OF ACONSTRUCTION OF ACONSTRUCTION OF ACONCRETE FE 150mm Ø STEEL INLE	TENDER PURPOSES ONLY Description de NORTH POINT CES CHECKED - SIGNATURE SIGNATURE fected by new construction are during excavations for road void damage to underground is,cables,watermains and these must be located 7400 732 EWS ERESERVOIR TMENT 1 A 3ML REINFORCED RESERVOIR, ET, 300mm Ø STEEL
0 OCT 2021 FOR Revision Date NOTE: No construction work to commence until land and servitu acquisitions have been completed Acquisitions completed: Date Engineer UNDERGROUND SERVIC SERVICE DATE Service DATE DATE SERVICE DATE SERVICE SERVICE DATE SERVICE SERVICE DATE SERVICE SEWERS SERVICE DATE WATERMAINS SEELECTRIC CABLES SE S.A.R CABLES SE SOIL PIPE LINE NOTE: Only underground services af shown. Care must be taken of foundations, trenches etc., to a services such as sewers, drain connections. Wherever possible before work begins. OIL PIPE LINE NOTE: Only underground services af shown. Care must be taken of foundations, trenches etc., to a services such as sewers, drain connections. Wherever possible before work begins. Contract No. Project No. Project Project No. Project Title Project Title THANDOKUHLIE CONSTRUCTION OF A CONCRETE F	TENDER PURPOSES ONLY Description de NORTH POINT CES CHECKED - SIGNATURE fected by new construction are during excavations for road void damage to underground iscables,watermains and these must be located 7400 732 EWS ERESERVOIR TMENT 1 A 3ML REINFORCED RESERVOIR, T, 300mm Ø STEEL AND ASSOCIATED
0 OCT 2021 FOR Revision Date NOTE No construction work to commerce until land and servitu acquisitions completed: Date Engineer UNDERGROUND SERVIC Date Engineer UNDERGROUND SERVIC SEWERS MATERMAINS WATERMAINS DATE S.W DRAINS SEWERS WATERMAINS SEWERS WATERMAINS SEWERS WATERMAINS SEWERS SA.R CABLES ELECTRIC CABLES S.A.R CABLES SEWERS OIL PIPE LINE NOTE: Only underground services af shown. Care must be taken of foundations, trenches etc., to a services such as sewers, drain connections. Wherever possible before work begins. VVS Contract No. Contract No. Project No. D Project Title THANDOKUHLE CONSTRUCTION OF A CONCRETE F T50mm Ø STEEL INLE OUTLET PIPELINES STEEL INLE	TENDER PURPOSES ONLY Description de NORTH POINT CES CHECKED - SIGNATURE fected by new construction are during excavations for road void damage to underground scables, watermains and these must be located 7400 732 EWS ERESERVOIR TMENT 1 A 3ML REINFORCED RESERVOIR, T, 300mm Ø STEEL AND ASSOCIATED RS
0 OCT 2021 FOR Revision Date NOTE: No construction work to commence until land and servitu acquisitions have been completed Acquisitions completed: Date Engineer UNDERGROUND SERVIC SERVICE DATE S.W DRAINS SERVICE SEWERS MATERMAINS TELKOM CABLES E ELECTRIC CABLES S.A.R CABLES ELECTRIC CABLES OIL PIPE LINE NOTE: Only underground services af shown. Care must be taken of foundations, trenches etc., to a services such as sewers, drain connections. Wherever possible before work begins. VUS Contract No. Project No. D Project No. D Project Title THANDOKUHLE CONSTRUCTION OF ACONCRETE F 150mm Ø STEEL INLE OUTLET PIPELINES WOF Drawing Title WOF	TENDER PURPOSES ONLY Description de NORTH POINT CES CHECKED - SIGNATURE SIGNATURE Geted by new construction are during excavations for road void damage to underground iscables,watermains and these must be located T400 7400 732 EWS ERESERVOIR TMENT 1 A 3ML REINFORCED RESERVOIR, T, 300mm Ø STEEL AND ASSOCIATED RS DETAILS
0 OCT 2021 FOR Revision Date NOTE: No construction work to commence until land and servitu acquisitions have been completed Acquisitions completed: Date Engineer UNDERGROUND SERVIG SERVICE DATE S.W DRAINS SEWERS WATERMAINS TELKOM CABLES ELECTRIC CABLES S.A.R CABLES ELECTRIC CABLES S.A.R CABLES E.S.C CABLES OIL PIPE LINE NOTE: Only underground services af shown. Care must be taken of foundations, trenches etc., to a services such as severs, drain connections. Wherever possible before work begins. VVS Contract No. Project No. Project Title THANDOKUHLE COMPAR CONSTRUCTION OF A CONCRETE F 150mm Ø STEEL INLE OUTLET PIPELINES WOF Dra wing Title STANDARD TYPICAL TREN	TENDER PURPOSES ONLY Description de NORTH POINT CES CHECKED - SIGNATURE SIGNATURE Geted by new construction are during excavations for road void damage to underground iscables,watermains and these must be located T400 7400 732 EWS ERESERVOIR TMENT 1 A 3ML REINFORCED RESERVOIR, T, 300mm Ø STEEL AND ASSOCIATED RS DETAILS
0 OCT 2021 FOR Revision Date NOTE: No construction work to commence until land and servitu acquisitions have been completed Acquisitions completed: Date Engineer UNDERGROUND SERVICE SERVICE DATE S.W DRAINS SEWERS WATERMAINS TELKOM CABLES ELECTRIC CABLES S.A.R CABLES E.S.C CABLES S.A.R CABLES E.S.C CABLES OIL PIPE LINE NOTE: Only underground services af shown. Care must be taken of foundations, trenches etc., to a services such as severs, drain connections. Wherever possible before work begins. VVS Contract No. Project No. Project Title THANDOKUHLE COMPAR CONSTRUCTION OF A CONCRETE F 150mm Ø STEEL INLE OUTLET PIPELINES WOF Drawing Title STANDARD TYPICAL TREN	TENDER PURPOSES ONLY Description de NORTH POINT CES CHECKED - SIGNATURE SIGNATURE Geted by new construction are during excavations for road void damage to underground scables, watermains and these must be located 7400 732 EWS ERESERVOIR TMENT 1 A 3ML REINFORCED RESERVOIR, T, 300mm Ø STEEL AND ASSOCIATED RESERVOIR, T, 300mm Ø STEEL AND ASSOCIATED RESERVOIR, T, 300mm Ø STEEL AND ASSOCIATED RESERVOIR CH DETAILS CH DETAILS
0 OCT 2021 FOR Revision Date NOTE: No construction work to commence until land and servitu acquisitions completed: Date Engineer UNDERGROUND SERVICE SERVICE DATE S.W DRAINS SEWERS WATERMAINS TELKOM CABLES ELECTRIC CABLES S.A.R CABLES E.S.C CABLES S.A.R CABLES E.S.C CABLES OIL PIPE LINE NOTE: Only underground services af shown. Care must be taken foundations, trenches etc., to a services such as sewers, drain connections. Wherever possible before work begins. Project No. Project Title THANDOKUHLE CONSTRUCTION OF A CONSTRUCTION OF A CONSTRUCTION OF A CONSTRUCTION OF A CONSTRUCTION OF A CONCRETE F 150mm Ø STEEL INLE OUTLET PIPELINES WOF Drawing Title SCales : As Shown Original paper size : A0 Designed : D. Ramghulam	TENDER PURPOSES ONLY Description de NORTH POINT CES CHECKED - SIGNATURE SIGNATURE Geted by new construction are during excavations for road void damage to underground iscables,watermains and these must be located 7400 732 ERESERVOIR TMENT 1 A 3ML REINFORCED RESERVOIR, T, 300mm Ø STEEL AND ASSOCIATED RESERVOIR, T, 300mm Ø STEEL AND ASSOCIATED RESERVOIR, T, 300mm Ø STEEL AND ASSOCIATED RESERVOIR TMENT 1 A 3ML REINFORCED RESERVOIR TMENT 1 A 4 4 4 4 4 4 4 4 4 4 4 4 4 4 4
0 OCT 2021 FOR Revision Date NOTE: No construction work to commence until land and servitu acquisitions have been completed Acquisitions completed: Date Engineer UNDERGROUND SERVIC DATE SERVICE DATE SW DRAINS SERVICE SEWERS WATERMAINS TELKOM CABLES E ELECTRIC CABLES S.A.R CABLES E.S.C CABLES OIL PIPE LINE NOTE: Only underground services af shown. Care must be taken of foundations, trenches etc., to a severices arrivers such as severicarian connections. Wherever possible before work begins. VUSS Contract No. Project No. D Project No. D Planning Unit E Project Title THANDOKUHLE CONSTRUCTION OF / CONCRETE F 150mm Ø STEEL INLE OUTLET PIPELINES WOF Drawing Title STANDARD Scales : As Shown Original paper size : A0 Designed : D. Ramghulam Checked : A. Goorun	TENDER PURPOSES ONLY Description de NORTH POINT CES CHECKED - SIGNATURE SIGNATURE Geted by new construction are during excavations for road void damage to underground iscables,watermains and these must be located 7400 732 ERESERVOIR TMENT 1 A 3ML REINFORCED RESERVOIR, T, 300mm Ø STEEL AND ASSOCIATED RESERVOIR, T, 300mm Ø STEEL AND ASSOCIATED RESERVOIR, T, 300mm Ø STEEL AND ASSOCIATED RESERVOIR TMENT 1 A 3ML REINFORCED RESERVOIR, T, 300mm Ø STEEL AND ASSOCIATED RESERVOIR TMENT 1 A 3ML REINFORCED RESERVOIR TMENT 1 A 3ML REINFORCED RESERVOIR, T, 300mm Ø STEEL AND ASSOCIATED RESERVOIR TMENT 1 A 3ML REINFORCED RESERVOIR TMENT 1 A 3ML REINFORCE
0 OCT 2021 FOR Revision Date NOTE: No construction work to commence until land and servitu acquisitions completed: Date Engineer UNDERGROUND SERVICE Date Engineer UNDERGROUND SERVICE SERVICE DATE S.W DRAINS ELECTRIC CABLES SEWERS WATERMAINS TELKOM CABLES ELECTRIC CABLES S.A.R CABLES E.S.C CABLES OIL PIPE LINE NOTE: Only underground services af shown. Care must be taken foundations,trenches etc. to a services such as sewers,drain connections.Wherever possible before work begins. VVS Contract No. D Project Title THANDOKUHLE CONSTRUCTION OF A CONCRETE F 150mm Ø STEEL INLE OUTLET PIPELINES WOF Drawing Title STANDARD TYPICAL TREN Scales : As Shown Original paper size : A0 Designed : D. Ramghulam Checked : A. Goorun Area Engineer (W.O.)	TENDER PURPOSES ONLY Description de NORTH POINT CES CHECKED - SIGNATURE SIGNATURE Geted by new construction are during excavations for road void damage to underground iscables,watermains and these must be located 7400 732 EVS ERESERVOIR TMENT 1 A 3ML REINFORCED RESERVOIR, T, 300mm Ø STEEL AND ASSOCIATED RESERVOIR, T, 300mm Ø STEEL AND ASSOCIATED RESERVOIR, T, 300mm Ø STEEL AND ASSOCIATED RESERVOIR TMENT 1 A 3ML REINFORCED RESERVOIR A A 3ML REINFORCED RESERVOIR A A 3M
0 OCT 2021 FOR Revision Date NOTE: No construction work to commence until land and servitu acquisitions have been completed Acquisitions completed: Date Engineer UNDERGROUND SERVIG SERVICE DATE Stewers DATE DATE SWATEMAINS DATE DATE SEWERS DATE DATE SA R CABLES DATE DATE E.S.C CABLES DATE DATE SA.R CABLES DATE DATE SA R CABLES DATE DATE SA.R CABLES DATE DATE NOTE: Only underground services all shown. Care must be taken of foundations, therever possible before work begins. DEVENCE NOTE: Only underground services all shown. Care must be taken of foundations, therever possible before work begins. DEVENCE VOTE ONLY DATE DATE Scontract No. D D Project No. D D Project Title THANDOKUHLIE D THANDOKUTION OF / CONCRETE F 150mm Ø STEEL INLE OUTLET PIPELINES WOF Drawing Title	TENDER PURPOSES ONLY Description NORTH POINT CES CHECKED - SIGNATURE Fected by new construction are during excavations for road void damage to underground is,cables,watermains and these must be located 7400 732 EWS ERESERVOIR TMENT 1 A 3ML REINFORCED RESERVOIR, T, 300mm Ø STEEL AND ASSOCIATED RESERVOIR Date : May 2021 Drawn : N. Adams

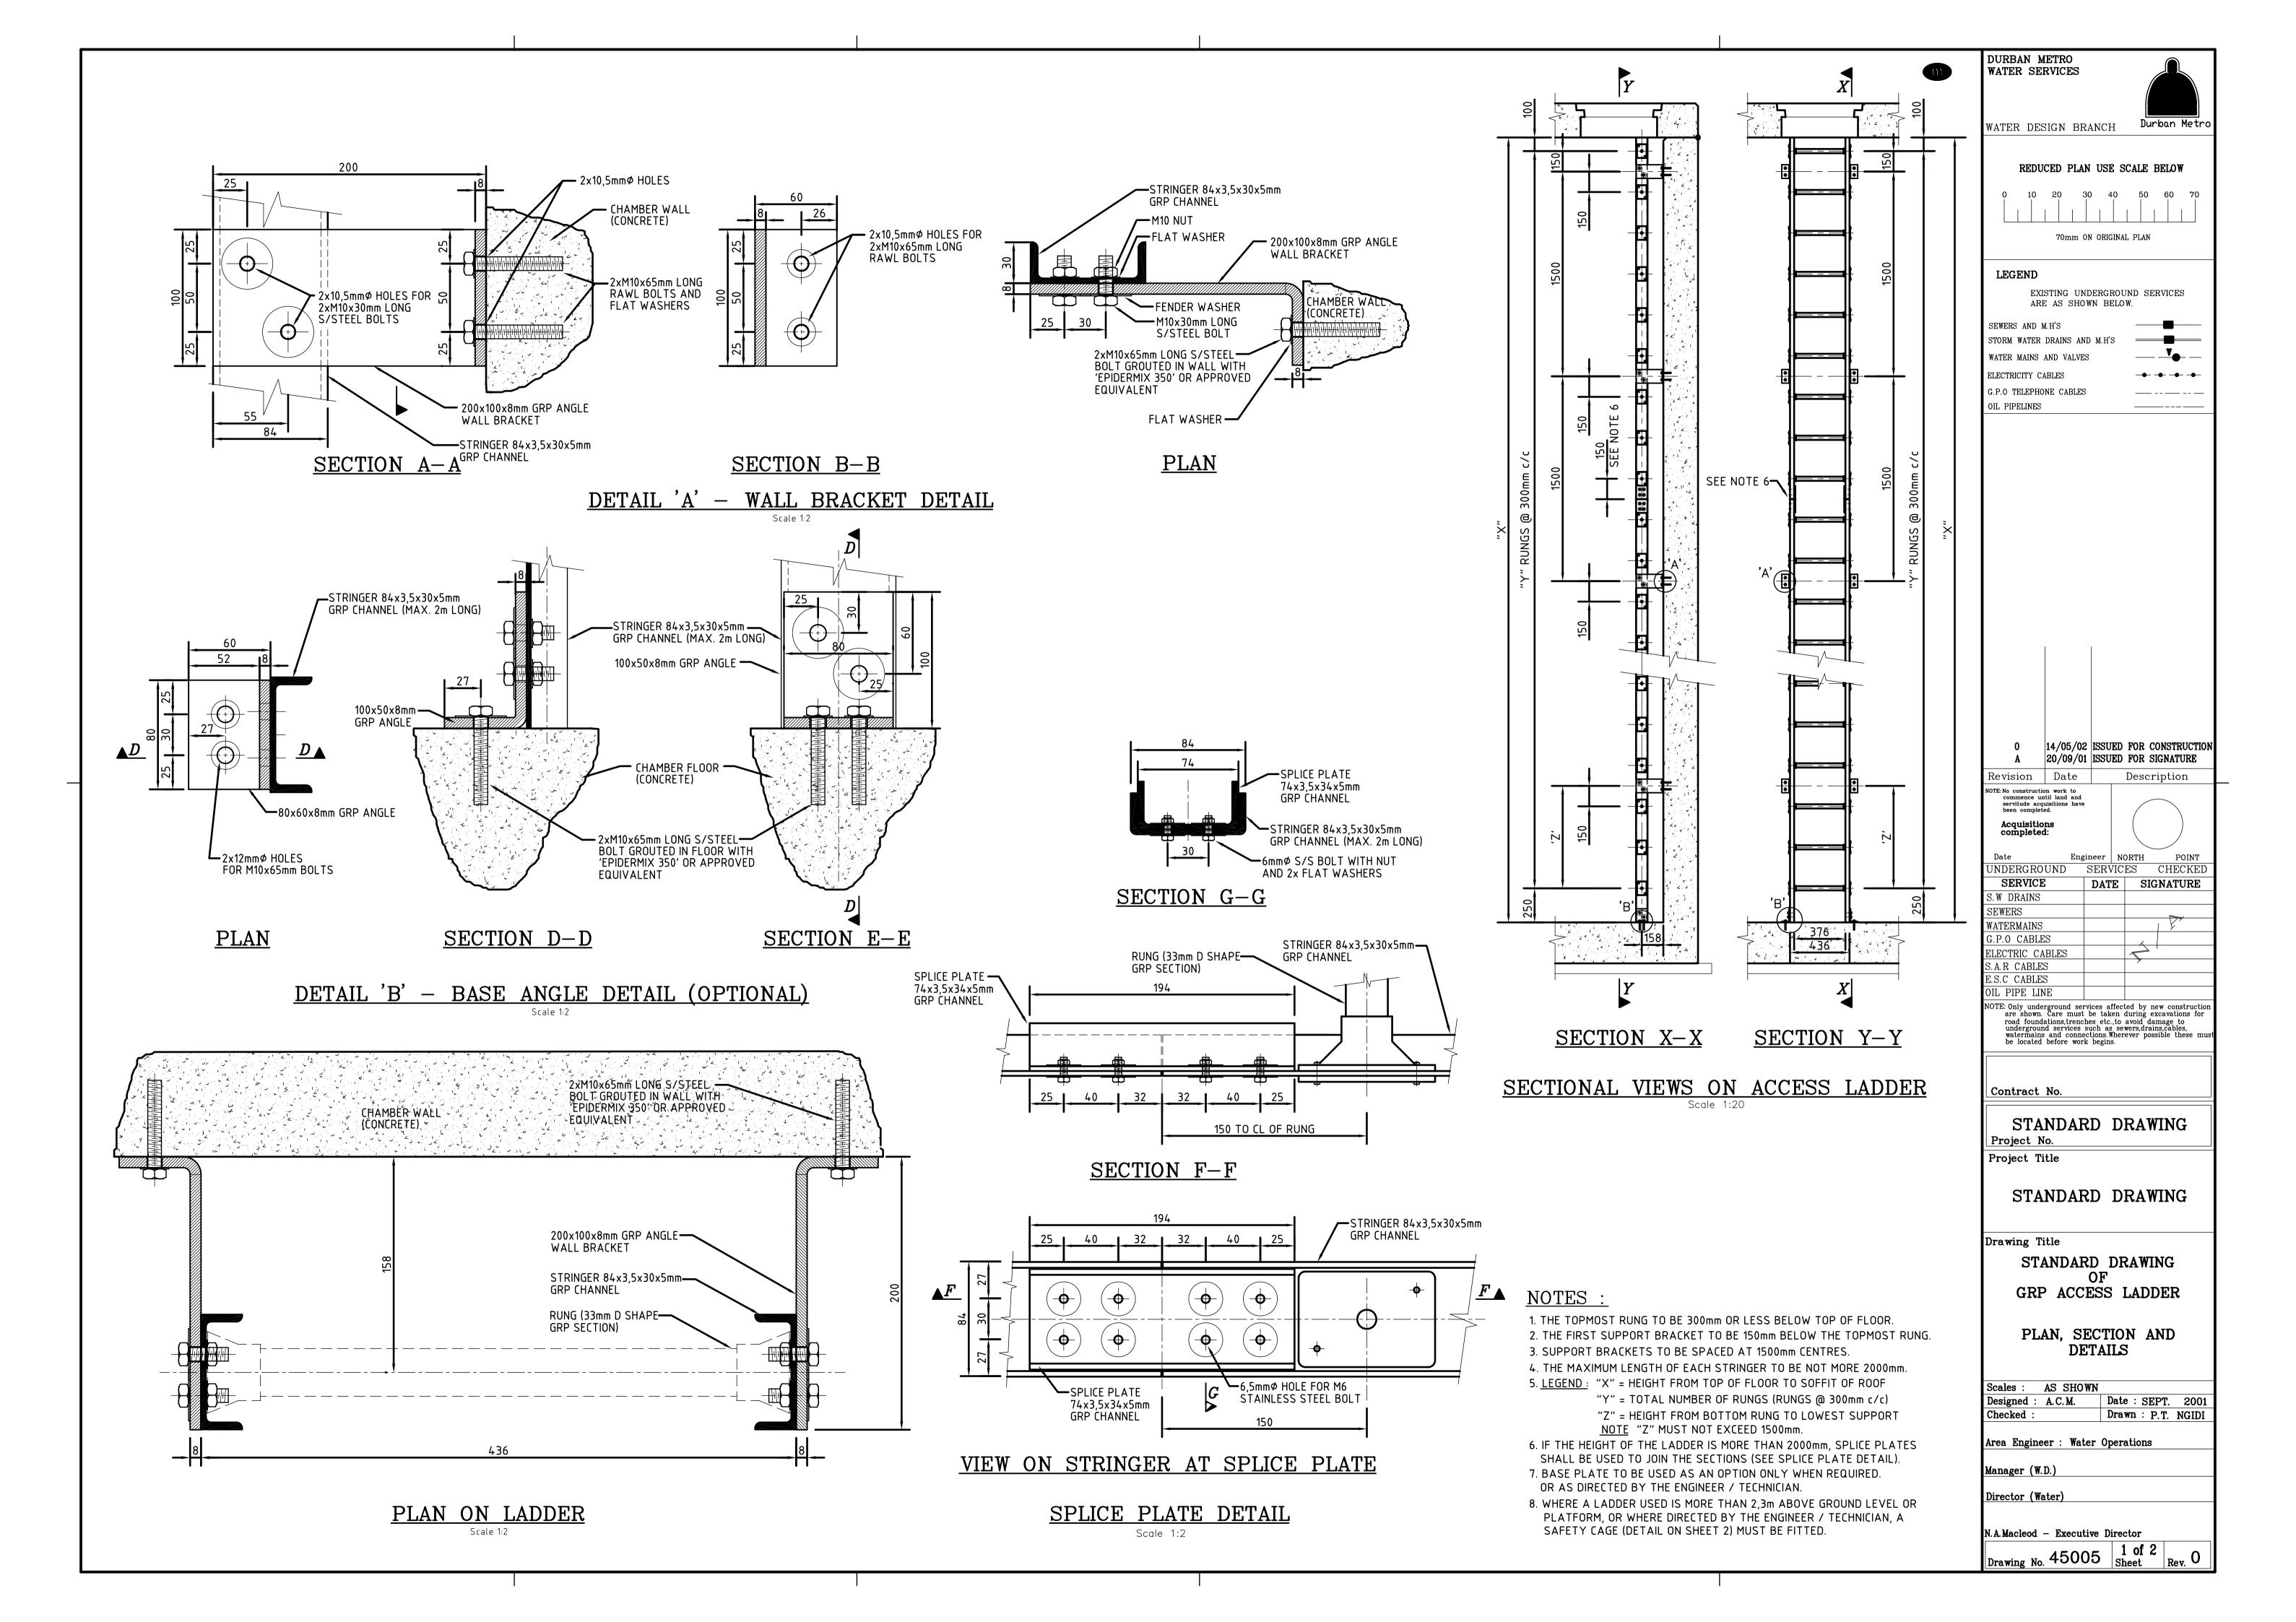

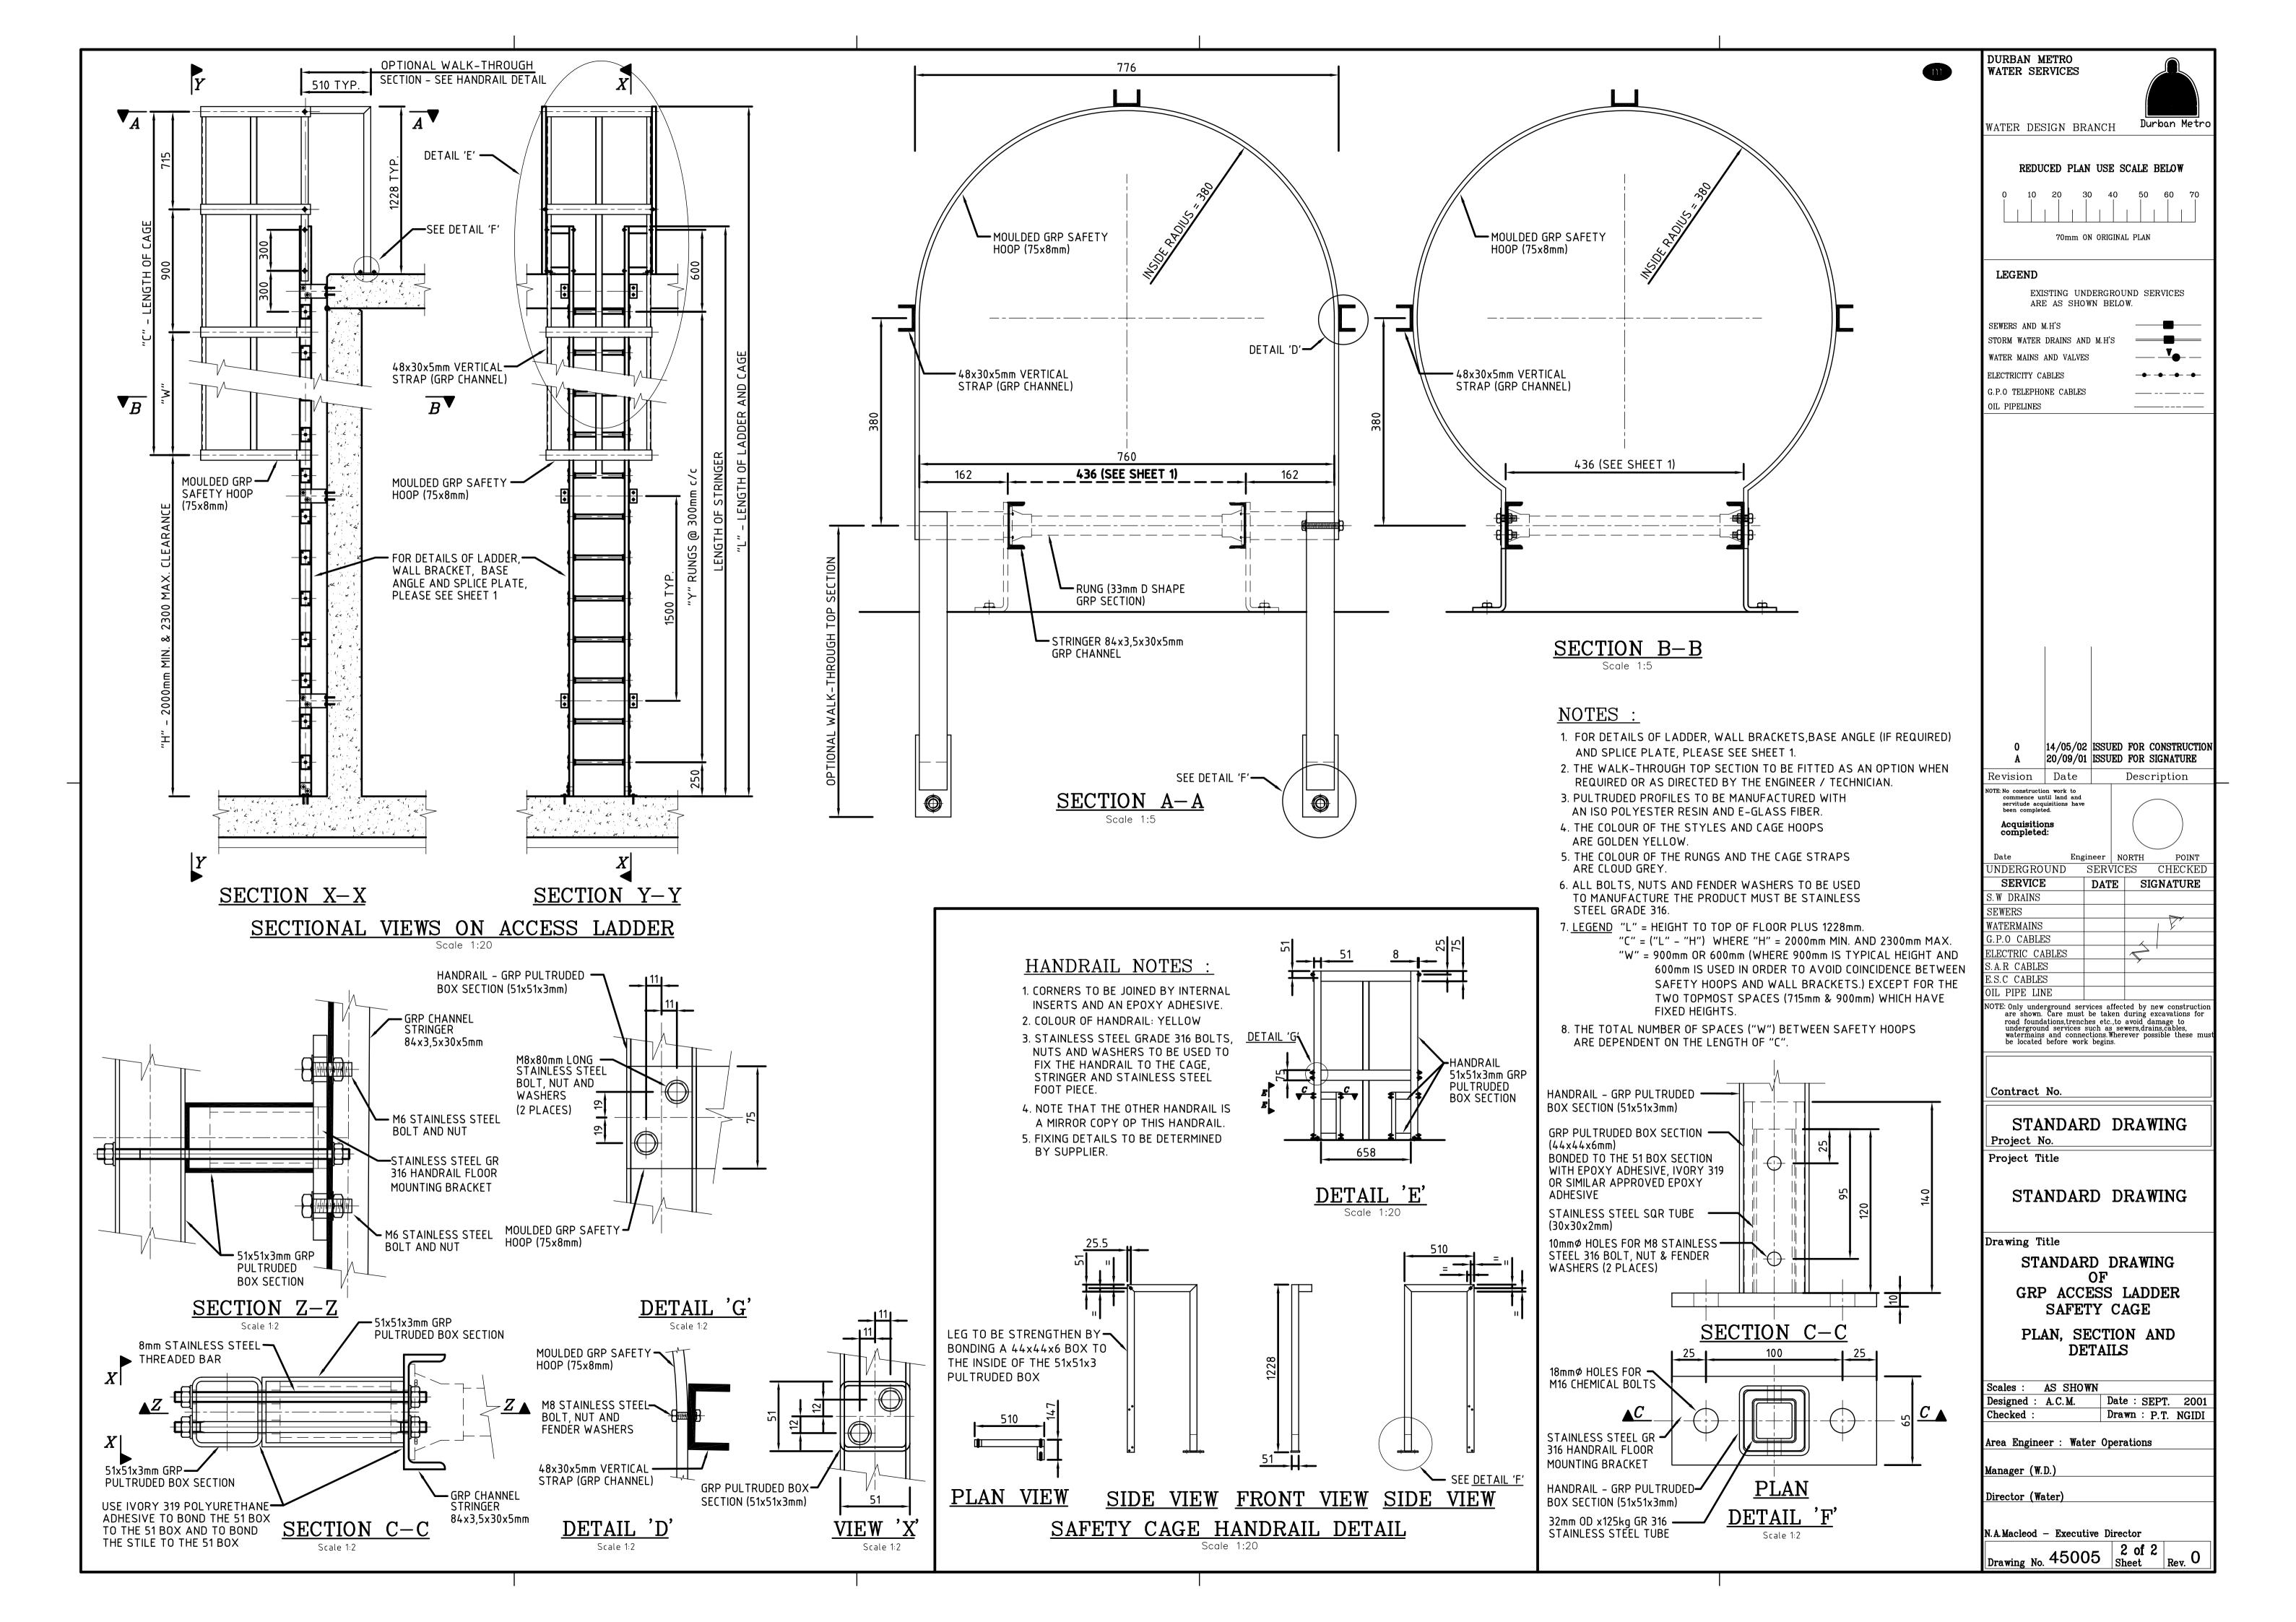

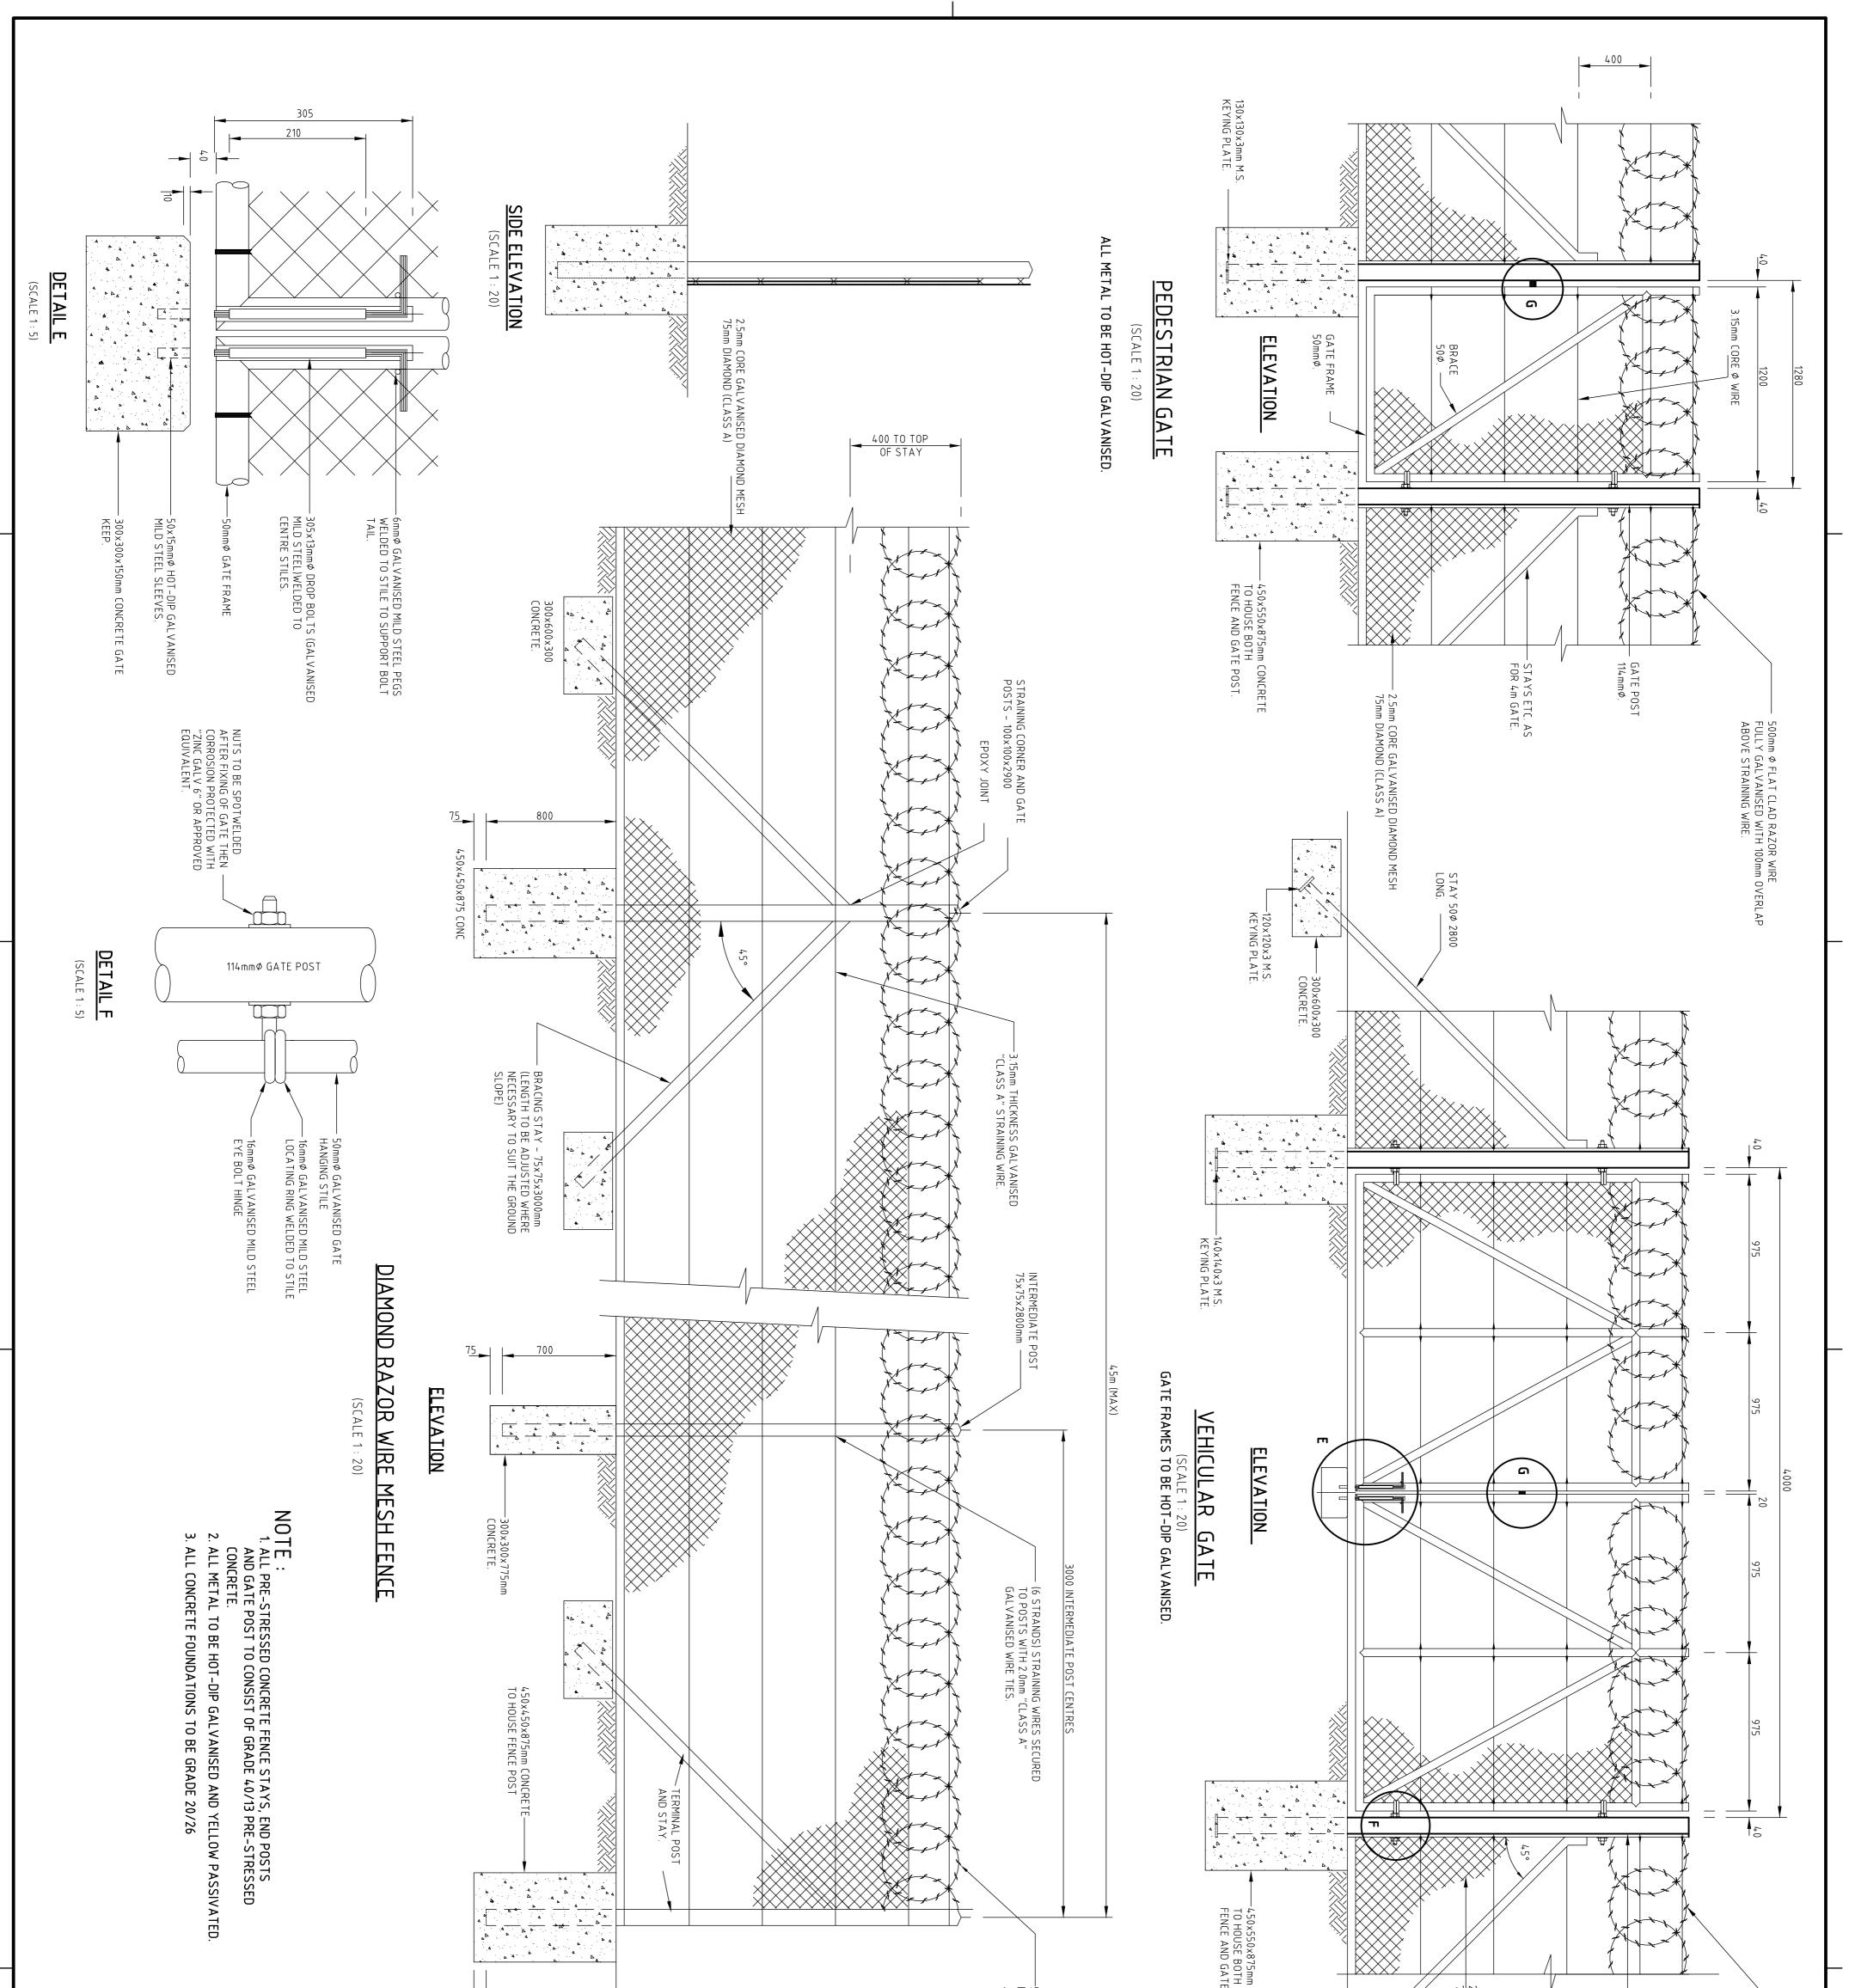

Sheet	_
od – Executive Director 68184 1/1	(SCALE 1: 2)
Director (Water)	DETAIL G
Manager (W.D.)	
Area Manager : Water Operations	
Designed :R.K.Date :AUGUST 2000Checked :Drawn :L.H.APPENAH	50 x 50 x 6mm
•	
	D
DIAMOND WIRE	
Drawing Title	;
STANDARD DRAWING	7 <u>5</u>
Project Title	-
Project No.	800
Contract No.	50
rices such as severs,d connections.Wherever j work begins.	450
OIL PIPE LINE NOTE: Only underground services affected by new construction are shown. Care must be taken during excavations for road foundations trenches act to avoid damage to	1800 HIG
ELECTRIC CABLES S.A.R CABLES E.S.C CABLES	450 <u>–</u> 5H DIAMON
SEWERS WATERMAINS G. P.O CABLES	2100
RVICE AINS	
Engineer NOR	450
commence until land and servitude acquisitions have been completed.	300
Revision Date Description	-
	-500mm Ø FLAT CLAD RAZOR WIRE "CLASS A" FULLY GALVANISED WITH 100mm OVERLAP ABOVE STRAINING WIRE.
	E POST.
	50
C.P.O TELEPHONE CABLES	
STORM WATER DRAINS AND M.H'S	2.5mm CORE GALVANISED DIAMOND MESH
EXISTING UNDERGROUND SERVICES ARE AS SHOWN BELOW.	2100
LEGEND	
70mm on original plan	GATE POST 114 Ø
REDUCED PLAN USE SCALE BELOW 0 10 20 30 40 50 60 70	300
WATER DESIGN BRANCH Durban Metro	FULLY GALVANISED WITH 100mm OVERLAP ABOVE STRAINING WIRE.
WATER SERVICES	
DURBAN METRO	

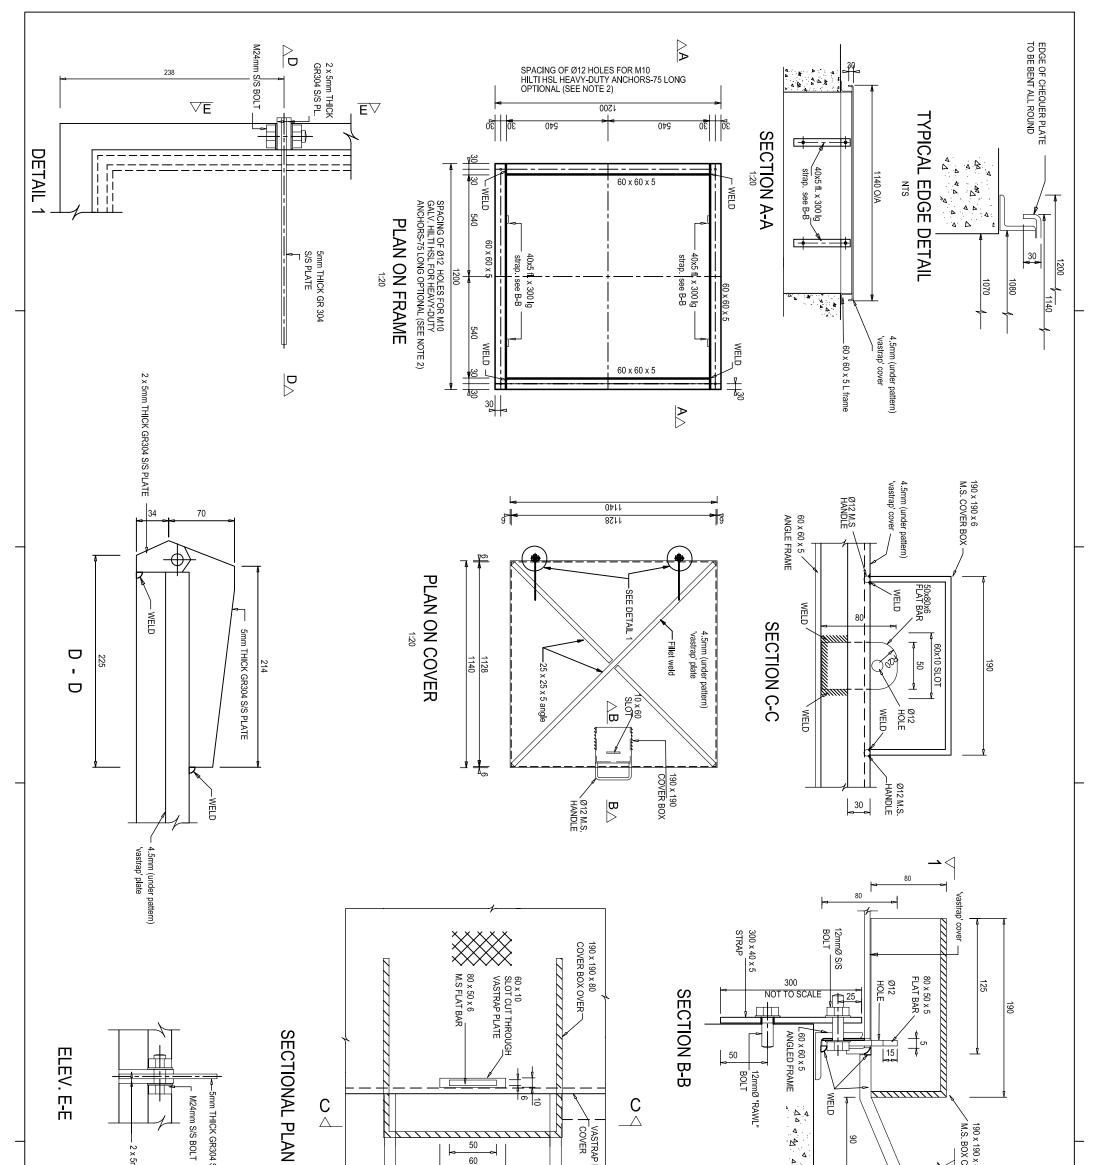

S/S PLATE	PLATE BENT TO SUIT	60 COVER COVER 6 6 6 6 6 6 6 6 7 7 7 7 7 7 7 7 7 7 7 7 7
Contract No. Project No. Project Title STANDARD DRAWING Darwing Title 1200 X 1200 G.I. MANHOLE COVER AND FRAME ARRANGEMENT & DETAILS Statis: AS INDICATED Designed: Date: Statis: SEPT. 2005 Checked: Date: Designer (W.0) Jawn: Manager (W.D) Jawn: Director (Water) Jaway Director (Water) Jaway Director (Water) Intervice Director (Water) State Director (Water) State	D Apr 2012 Size of cover, frame and opening C July 2010 25 x 5 x 6 angle added to cover Revision Date Description Service constant Description Variations Complete Service Complete Description UNDERGROUND SERVICES DECKED SERVICE DATE SIGNATURE SERVICE DATE SIGNATURE SERVICE DATE SIGNATURE SERVIES ELECTRIC CARES ELECTRIC CARES ELECTRIC CARES SAR CABLES SIGNATURE SOIL PIFL LNE SIGNATURE SIGNATURE VOITE of and only of constant of angle of a mage to and angle of angle of a mage to angle of a	R BOX 2. FISHTAIL LUGS OR BOLTS ARE OPTIONAL: WHERE FRAMES ARE TO BE FIXED TO EXISTING OR ARE FIXED INTO IN-SITU CONCRETE, LUGS MAY BE PROVIDED.