


LAYOUT PLAN SCALE 1:500

Pier 1- TPT offices							
Meter No	Propose AMR size	Existing pipe size	Exist pipe material	Meter to be installed above ground/ or inside manhole	Position of meter Co-ordinates		
12	50mm	50mm	AC / Steel	Above ground	Y= -2787.916 X= 3307211.051		
13	100mm	100mm	Unknown	Above ground	Y= -2897.720 X= 3307258.739		
14	150mm	150mm	Unknown	Inside exist manhole	Y= -3004.193 X= 3307121.633		

GENERAL NOTES:

1. ANCHORAGE AND THRUST BLOCKS SHOULD BE USED WHENEVER THE PIPELINE CHANGES VERTICAL OR HORIZONTAL DIRECTION BY MORE THAN 10°. THRUST BLOCKS SHOULD ALSO BE USED WHERE THE SIZE OF THE PIPELINE CHANGES, AT BLANK ENDS AND ON STEEP SLOPES (MORE THAN 1:6).

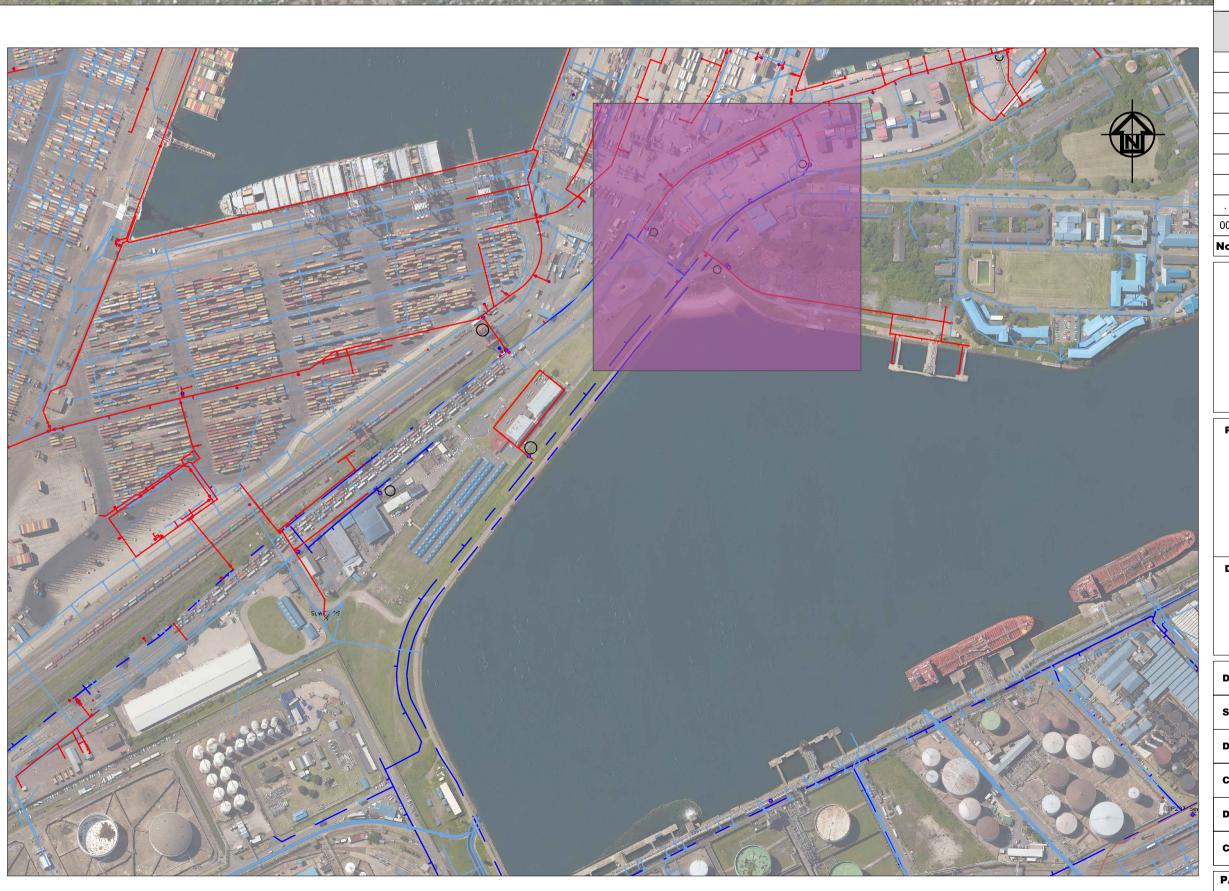

SITE PLAN SCALE 1:5000

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FOR APPROVAL 00 ISSUED FOR CONSTRUCTION **DESCRIPTION / REVISIONS** DATE

LEGEND

NEW METERS CONNECTION WITH AMR TECHNOLOGY TO BE MEASURED AS A UNIT.

EXISTING ETHEKWINI SMALL METER

EXISTING ETHEKWINI BULK METER

EXISTING FRESH WATER — EXISTING STORMWATER

— EXISTING SEWER



PROJECT / AREA / ASSET / SUBJECT

PORT OF DURBAN DRAWING

STANDARDS

INSTALLATION OF AUTOMATIC METER READERS TO ISOLATE TPT FROM TNPA **WATER RETICULATION** Pier 1- TPT offices

DATE	2021-10-26	DH - DESIGN CENTRE MANAGER MR. R. M. VILBRO					
SCALE	AS SHOWN	SIGNATURE	DATE				
DESIGNED BY	RB	DH - PORT ENGINEER MR. M. Setaka					
CHECKED BY		SIGNATURE	DATE				
DRAWN BY	RB	DH - PLAN DRAWER MR. R. Benade					
CHECKED BY	RV	SIGNATURE	DATE				

TRANSNET DRW. NO. SHEET REV. DH61-J-904-004-00

CONSULTANT / CONTRACTOR DRW. NO.