


Pier 1/ TPT Staff building & EES building						
Meter No	Propose AMR size	Existing pipe size	Exist pipe material	Meter to be installed above ground/ or inside manhole	Position of meter Co-ordinates	
11	150mm	375mm	Unknown	Above ground	Y= -2599.432 X= 3307362.997	
16	50mm	50mm	Unknown	Above ground	Y= -2434.323 X= 3307555.324	
17	80mm	80mm	PVC/HDPE	Above ground attach to building	Y= -2679.957 X= 3307421.674	

GENERAL NOTES:

1. ANCHORAGE AND THRUST BLOCKS SHOULD BE USED WHENEVER THE PIPELINE CHANGES VERTICAL OR HORIZONTAL DIRECTION BY MORE THAN 10°. THRUST BLOCKS SHOULD ALSO BE USED WHERE THE SIZE OF THE PIPELINE CHANGES, AT BLANK ENDS AND ON STEEP SLOPES (MORE THAN 1:6).

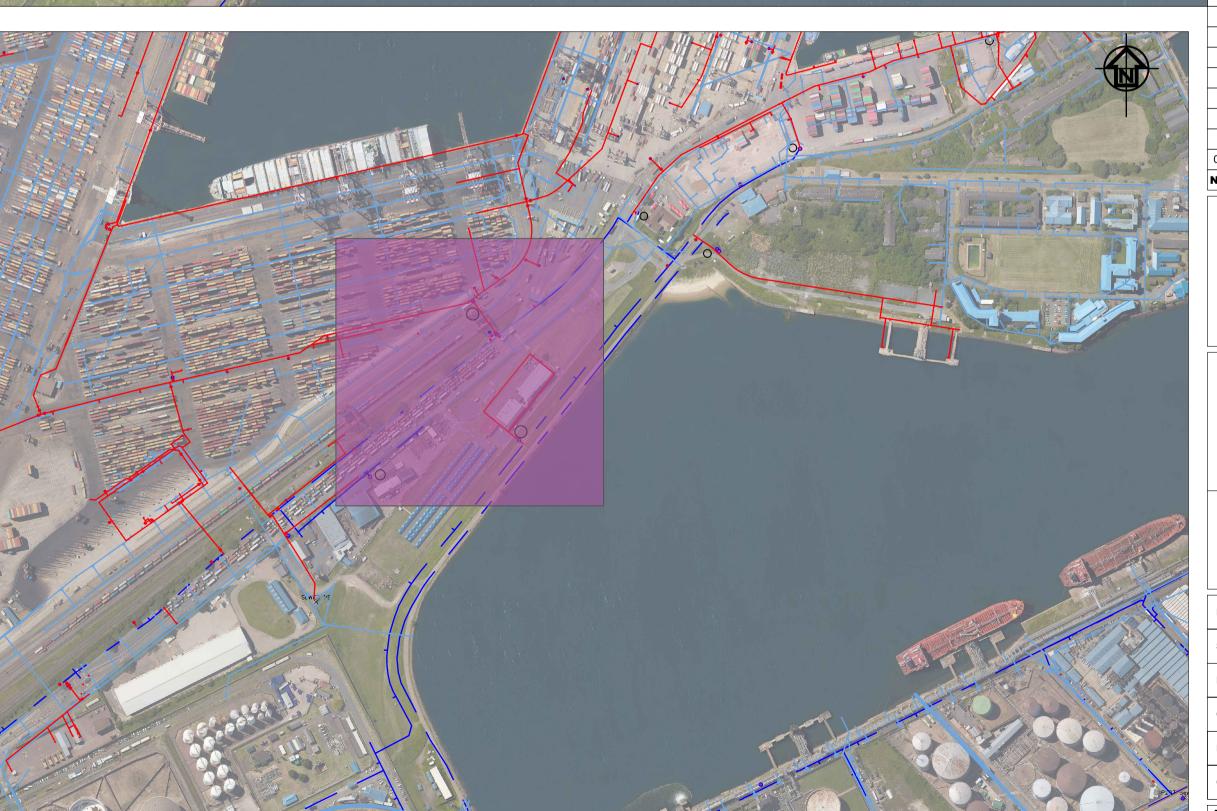

SITE PLAN SCALE 1:7500

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FOR APPROVAL

00 ISSUED FOR CONSTRUCTION DESCRIPTION / REVISIONS DATE

TRANSNET national ports authority

PROJECT / AREA / ASSET / SUBJECT

PORT OF DURBAN DRAWING

STANDARDS

INSTALLATION OF AUTOMATIC METER READERS TO ISOLATE TPT FROM TNPA WATER RETICULATION Pier 1/ TPT Staff building & EES building

DATE	2021-10-26	DH - DESIGN CENTRE MANAGER MR. R. M. VILBRO
SCALE	AS SHOWN	SIGNATURE DATE
DESIGNED BY	RB	DH - PORT ENGINEER MR. M. Setaka
CHECKED BY		SIGNATURE DATE
DRAWN BY	RB	DH - PLAN DRAWER MR. R. Benade
CHECKED BY	RV	SIGNATURE DATE

DH61-J-904-006-00

CONSULTANT / CONTRACTOR DRW. NO.