

SUBTECH

GROUP


KATLANTIC

ISLAND VIEW 4

QUAY SIDE INSPECTION

13 AUGUST 2018
DURBAN
SOUTH AFRICA




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	Document No.	FOR - DIV - 033			
	Revision Date	6 November 2014	Rev No.	2	

Island View 4
Quay Side Pile Inspection
13 August 2018 – 15 August 2018
SSD18-001B-032
Katlantic




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1.0 INTRODUCTION

This final report has been prepared and compiled by Heath Nicholls

2.0 SCOPE OF WORK

The scope of work consisted of diving inspections on piles beneath IV 4 quay, core samples taken on piles as well as on the quay wall or deck slab.

3.0 SUMMARY OF OPERATIONS

The following table summarises the probing sequence of operations.

Date	Time	Activity
13.08.2018	07:30	TNPA Inductions Dive Inspection – Piles A and B
14.08.2018	07:00	Dive Inspection – Piles C and D
15.08.2018	07:00	Dive Core sampling

4.0 PROJECT PLANNING and PREPARATION

4.1 Plans and Procedures


- Mobilization of team and equipment from Head office in Durban
- Port authority notification
- Equipment setup and function test
- All personnel will adhere to the client's site specific regulations as well as with Subtech's policies and procedures.

Subtech is an IMCA registered contractor, and as such is bound to comply with IMCA regulations

4.2 Equipment Mobilisation

The plant and equipment was mobilised from Subtech Head office
Subtech mobilised the following plant and equipment

- 8m Rigid Hull Inflatable Boat – “ANGE” and trailer
- SSDE SYSTEM 4251
- Double cab 4x4 Toyota Hilux. ND 598 410
- Hydraulic power pack
- 100m Hydraulic line
- Core drill
- Kia Utility. ND
- 100m water line hose

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5.0 PROJECT RESOURCES

The following resources were supplied and utilised by Subtech

5.1 Personnel

SUBTECH:

1 x Dive Supervisor	-	Heath Nicholls
1 x Diver/skipper	-	Sean Hoskison
1 x Diver	-	Carl Meyer
1 x Diver	-	Marius Steenkamp
1 x Diver	-	Michael Ntola

5.2 Plant and Equipment

- 8m Rigid Hull Inflatable Boat – “ANGE” and trailer
- SSDE SYSTEM 4251
- Double cab 4x4 Toyota Hilux. ND 598 410
- Hydraulic power pack
- 100m Hydraulic line
- Core drill
- Kia Utility. ND
- 100m water line hose

5.3 Diving

All diving operations were carried out by SUBTECH personnel.

6.0 Conclusion

Please refer to attached document flow diagram.

East to West

Allocation	Pile	Spine beam default	Slab underbelly default	Pile default	Pile default Depth	Comment	Marine growth coverage	Type of fouling
A	0	No anomalies noted	No anomalies noted	No anomalies noted	N/A	General over view in good condition	90 -100%	Soft and hard marine growth
A	1	Surface crack, minor/cosmetic	No anomalies noted	No anomalies noted	N/A	General over view in good condition	90 -100%	Soft and hard marine growth
A	2	No anomalies noted	No anomalies noted	No anomalies noted	N/A	General over view in good condition	90 -100%	Soft and hard marine growth
A	3	No anomalies noted	No anomalies noted	No anomalies noted	N/A	General over view in good condition	90 -100%	Soft and hard marine growth
A	4	No anomalies noted	No anomalies noted	No anomalies noted	N/A	General over view in good condition	90 -100%	Soft and hard marine growth
A	5	No anomalies noted	No anomalies noted	No anomalies noted	N/A	General over view in good condition	90 -100%	Soft and hard marine growth
A	6	No anomalies noted	No anomalies noted	No anomalies noted	N/A	General over view in good condition	90 -100%	Soft and hard marine growth
A	7.1	No anomalies noted	No anomalies noted	No anomalies noted	N/A	General over view in good condition	90 -100%	Soft and hard marine growth
A	7.2	No anomalies noted	No anomalies noted	No anomalies noted	N/A	General over view in good condition	90 -100%	Soft and hard marine growth
A	8	No anomalies noted	No anomalies noted	No anomalies noted	N/A	General over view in good condition	90 -100%	Soft and hard marine growth
A	9	No anomalies noted	No anomalies noted	No anomalies noted	N/A	General over view in good condition	90 -100%	Soft and hard marine growth
A	10	No anomalies noted	No anomalies noted	No anomalies noted	N/A	General over view in good condition	90 -100%	Soft and hard marine growth
A	11	No anomalies noted	No anomalies noted	No anomalies noted	N/A	General over view in good condition	90 -100%	Soft and hard marine growth
A	12	No anomalies noted	No anomalies noted	No anomalies noted	N/A	General over view in good condition	90 -100%	Soft and hard marine growth
A	13	No anomalies noted	No anomalies noted	No anomalies noted	N/A	General over view in good condition	90 -100%	Soft and hard marine growth
A	14	No anomalies noted	No anomalies noted	No anomalies noted	N/A	General over view in good condition	90 -100%	Soft and hard marine growth
A	15	No anomalies noted	No anomalies noted	No anomalies noted	N/A	General over view in good condition	90 -100%	Soft and hard marine growth
A	16	No anomalies noted	No anomalies noted	No anomalies noted	N/A	General over view in good condition	90 -100%	Soft and hard marine growth
A	17	No anomalies noted	No anomalies noted	Minor over spill	7m and 4m	General over view in good condition	90 -100%	Soft and hard marine growth
A	18	No anomalies noted	No anomalies noted	No anomalies noted	N/A	General over view in good condition	90 -100%	Soft and hard marine growth
A	19	No anomalies noted	No anomalies noted	No anomalies noted	N/A	General over view in good condition	90 -100%	Soft and hard marine growth
A	20	No anomalies noted	No anomalies noted	No anomalies noted	N/A	General over view in good condition	90 -100%	Soft and hard marine growth

West to East

[illegible]

West to East

B	6.2	No anomalies noted	Honey combing	No anomalies noted	N/A	General over view in good condition	90 -100%	Soft and hard marine growth
B	6.1	No anomalies noted	No anomalies noted	No anomalies noted	N/A	General over view in good condition	90 -100%	Soft and hard marine growth
B	5.3	No anomalies noted	No anomalies noted	No anomalies noted	N/A	General over view in good condition	90 -100%	Soft and hard marine growth
B	5.2	No anomalies noted	No anomalies noted	No anomalies noted	N/A	General over view in good condition	90 -100%	
B	5.1	No anomalies noted	Crack line - unknown depth	No anomalies noted	N/A	General over view in good condition	90 -100%	Soft and hard marine growth
B	4.3	No anomalies noted	No anomalies noted	No anomalies noted	N/A	General over view in good condition	90 -100%	Soft and hard marine growth
B	4.2	No anomalies noted	No anomalies noted	No anomalies noted	N/A	General over view in good condition	90 -100%	Soft and hard marine growth
B	4.1	No anomalies noted	Minor delamination and honey combing	No anomalies noted	N/A	General over view in good condition	90 -100%	Soft and hard marine growth
B	3.3	No anomalies noted	No anomalies noted	No anomalies noted	N/A	General over view in good condition	90 -100%	
B	3.2	No anomalies noted	No anomalies noted	No anomalies noted	N/A	General over view in good condition	90 -100%	
B	3.1	No anomalies noted	Honey combing	No anomalies noted	N/A	General over view in good condition	90 -100%	
B	2.3	No anomalies noted	Honey combing	No anomalies noted	N/A	General over view in good condition	90 -100%	Soft and hard marine growth
B	2.2	No anomalies noted	Honey combing	No anomalies noted	N/A	General over view in good condition	90 -100%	Soft and hard marine growth
B	2.1	No anomalies noted	Honey combing	No anomalies noted	N/A	General over view in good condition	90 -100%	Soft and hard marine growth
			Delamination between B3 and B1			Approximately 1.5m ² m surrounding area		
			Delamination between B line and C line			Approximately 6m ² m surrounding area		
B	1.3	No anomalies noted	No anomalies noted	No anomalies noted	N/A	General over view in good condition	90 -100%	Soft and hard marine growth
B	1.2	No anomalies noted	Honey combing/Delamination	No anomalies noted	N/A	Delamination between B and C, 4 - 2M	90 -100%	Soft and hard marine growth
B	1.1	No anomalies noted	No anomalies noted	Delamination	4m	545mmx65mm North - 650mmx85mm West	90 -100%	Soft and hard marine growth
B	0.1	No anomalies noted	Honey combing	Cap Impact damage	N/A	650mm Length x 80mm Depth South - 740mm Length x 115mm Depth North	90 -100%	Soft and hard marine growth

East to west


Allocation	Pile	Spine beam default	Slab underbelly default	Pile default	Pile default Depth	Comment	Marine growth coverage	Type of fouling
C	0	No anomalies noted	No anomalies noted	No anomalies noted	N/A	General over view in good condition	90 -100%	Soft and hard marine growth
C	1.1	Surface crack, minor/cosmetic	No anomalies noted	No anomalies noted	N/A	General over view in good condition	90 -100%	Soft and hard marine growth
C	1.2	No anomalies noted	No anomalies noted	No anomalies noted	N/A	General over view in good condition	90 -100%	Soft and hard marine growth
C	2.1	No anomalies noted	No anomalies noted	No anomalies noted	N/A	General over view in good condition	90 -100%	Soft and hard marine growth
C	2.2	No anomalies noted	Delamination	No anomalies noted	N/A	General over view in good condition	90 -100%	Soft and hard marine growth
C	3.1	No anomalies noted	No anomalies noted	No anomalies noted	N/A	General over view in good condition	90 -100%	Soft and hard marine growth
C	3.2	No anomalies noted	No anomalies noted	No anomalies noted	N/A	General over view in good condition	90 -100%	Soft and hard marine growth
C	4.1	No anomalies noted	No anomalies noted	No anomalies noted	N/A	General over view in good condition	90 -100%	Soft and hard marine growth
C	4.2	No anomalies noted	No anomalies noted	No anomalies noted	N/A	General over view in good condition	90 -100%	Soft and hard marine growth
C	5.1	No anomalies noted	No anomalies noted	No anomalies noted	N/A	General over view in good condition	90 -100%	Soft and hard marine growth
C	6.1	No anomalies noted	No anomalies noted	No anomalies noted	N/A	General over view in good condition	90 -100%	Soft and hard marine growth
C	7.1	No anomalies noted	No anomalies noted	No anomalies noted	N/A	General over view in good condition	90 -100%	Soft and hard marine growth
C	8.1	No anomalies noted	No anomalies noted	No anomalies noted	N/A	General over view in good condition	90 -100%	Soft and hard marine growth
C	9.1	No anomalies noted	No anomalies noted	No anomalies noted	N/A	General over view in good condition	90 -100%	Soft and hard marine growth
C	10.1	No anomalies noted	No anomalies noted	No anomalies noted	N/A	General over view in good condition	90 -100%	Soft and hard marine growth
C	11.1	No anomalies noted	No anomalies noted	No anomalies noted	N/A	General over view in good condition	90 -100%	Soft and hard marine growth
C	12.1	No anomalies noted	No anomalies noted	No anomalies noted	N/A	General over view in good condition	90 -100%	Soft and hard marine growth
C	13.1	No anomalies noted	No anomalies noted	No anomalies noted	N/A	General over view in good condition	90 -100%	Soft and hard marine growth
C	14.1	No anomalies noted	No anomalies noted	No anomalies noted	N/A	General over view in good condition	90 -100%	Soft and hard marine growth
C	15.1	No anomalies noted	No anomalies noted	No anomalies noted	N/A	General over view in good condition	90 -100%	Soft and hard marine growth
C	16.1	No anomalies noted	No anomalies noted	No anomalies noted	N/A	General over view in good condition	90 -100%	Soft and hard marine growth
C	17.1	No anomalies noted	No anomalies noted	No anomalies noted	N/A	General over view in good condition	90 -100%	Soft and hard marine growth
C	18.1	No anomalies noted	No anomalies noted	No anomalies noted	N/A	General over view in good condition	90 -100%	Soft and hard marine growth

East to west

				Delamination due to corrosion or rebar/corrosion			
C	19.1	No anomalies noted	Minor delamination	No anomalies noted	General over view in good condition	90 -100%	Soft and hard marine growth
C	20.1	No anomalies noted	Minor delamination	No anomalies noted	General over view in good condition	90 -100%	Soft and hard marine growth
C	20.2	No anomalies noted	No anomalies noted	N/A	General over view in good condition	90 -100%	Soft and hard marine growth
C	21.1	No anomalies noted	Minor delamination	No anomalies noted	General over view in good condition	90 -100%	Soft and hard marine growth
C	21.2	No anomalies noted	Minor delamination	No anomalies noted	General over view in good condition	90 -100%	Soft and hard marine growth
C	22.1	No anomalies noted	No anomalies noted	N/A	General over view in good condition	90 -100%	Soft and hard marine growth
C	22.2	No anomalies noted	Minor delamination	No anomalies noted	General over view in good condition	90 -100%	Soft and hard marine growth
C	23.1	No anomalies noted	Minor honey combing/delamination	No infrastructure	No infrastructure top of pile - No infrastructure base of pile	90 -100%	Soft and hard marine growth
C	23.2	No anomalies noted	Minor honey combing/delamination	Minor delamination	General over view in good condition	90 -100%	Soft and hard marine growth
C	23.3	No anomalies noted	Minor honey combing/delamination	Minor delamination	Possible replacement pile	90 -100%	Soft and hard marine growth
C	24.1	No anomalies noted	No anomalies noted	Minor delamination	General over view in good condition	90 -100%	Soft and hard marine growth

West to east

Allocation	Pile	Spine beam default	Slab underbelly default	Pile default	Pile default Depth	Comment	Marine growth coverage	Type of fouling
D	12	No anomalies noted	No anomalies noted	No anomalies noted	N/A	General over view in good condition	90 -100%	Soft and hard marine growth
D	11	No anomalies noted	No anomalies noted	No anomalies noted	N/A	General over view in good condition	90 -100%	Soft and hard marine growth
D	10	No anomalies noted	No anomalies noted	No anomalies noted	N/A	General over view in good condition	90 -100%	Soft and hard marine growth
D	9	No anomalies noted	No anomalies noted	No anomalies noted	N/A	General over view in good condition	90 -100%	Soft and hard marine growth
D	8	No anomalies noted	No anomalies noted	No anomalies noted	N/A	General over view in good condition	90 -100%	Soft and hard marine growth
D	7	No anomalies noted	No anomalies noted	No anomalies noted	N/A	General over view in good condition	90 -100%	Soft and hard marine growth
D	6	No anomalies noted	No anomalies noted	No anomalies noted	N/A	General over view in good condition	90 -100%	Soft and hard marine growth
D	5	No anomalies noted	No anomalies noted	No anomalies noted	N/A	General over view in good condition	90 -100%	Soft and hard marine growth
D	4	No anomalies noted	No anomalies noted	No anomalies noted	N/A	General over view in good condition	90 -100%	Soft and hard marine growth
D	3	No anomalies noted	No anomalies noted	No anomalies noted	N/A	General over view in good condition	90 -100%	Soft and hard marine growth
D	2	No anomalies noted	No anomalies noted	No anomalies noted	N/A	General over view in good condition	90 -100%	Soft and hard marine growth
D	1	No anomalies noted	No anomalies noted	No anomalies noted	N/A	General over view in good condition	90 -100%	Soft and hard marine growth
D	0	No anomalies noted	No anomalies noted	No anomalies noted	N/A	General over view in good condition	90 -100%	Soft and hard marine growth

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7.0 Photographs (if applicable)

A - Line Crack line Spine beam.



C - Line Detachment



C - Line, base no infrastructure



C- Line, surface no infrastructure




C - Line slab and pile delamination. Group 23



Delamination/Honeycombing B3 - B1



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Delamination B – C 6mx2m



Delamination B – C Group 2



Slab and Pile general overview




Core drilling at 5m depth



8.0 Drawings to follow.


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Pile core sample allocation – East end.

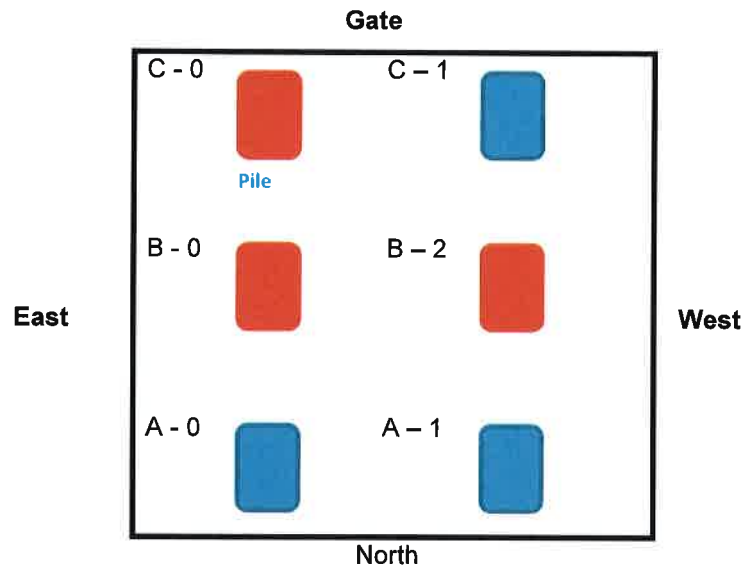

C-0.Sample taken at tidal
B-0.Sample taken at 5m depth in water
B-2.Sample taken at tidal


Deck slab core sample allocation

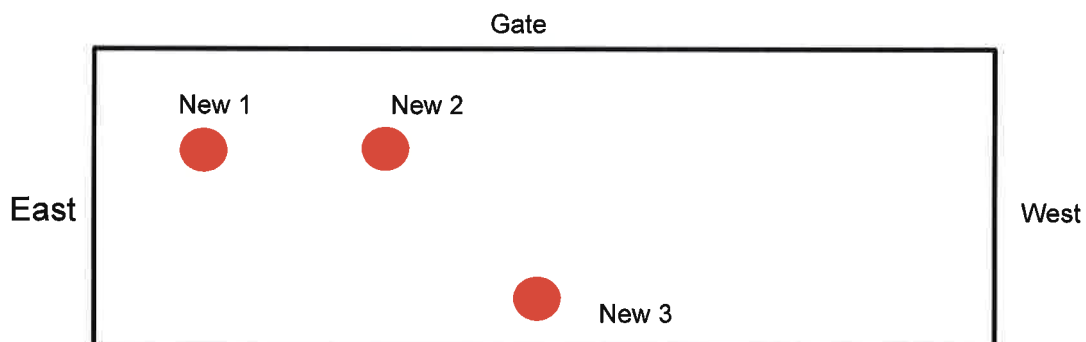

8.0 Drawings to follow.

ISLAND VIEW 4
QUAY SIDE INSPECTION

CHANNEL SIDE

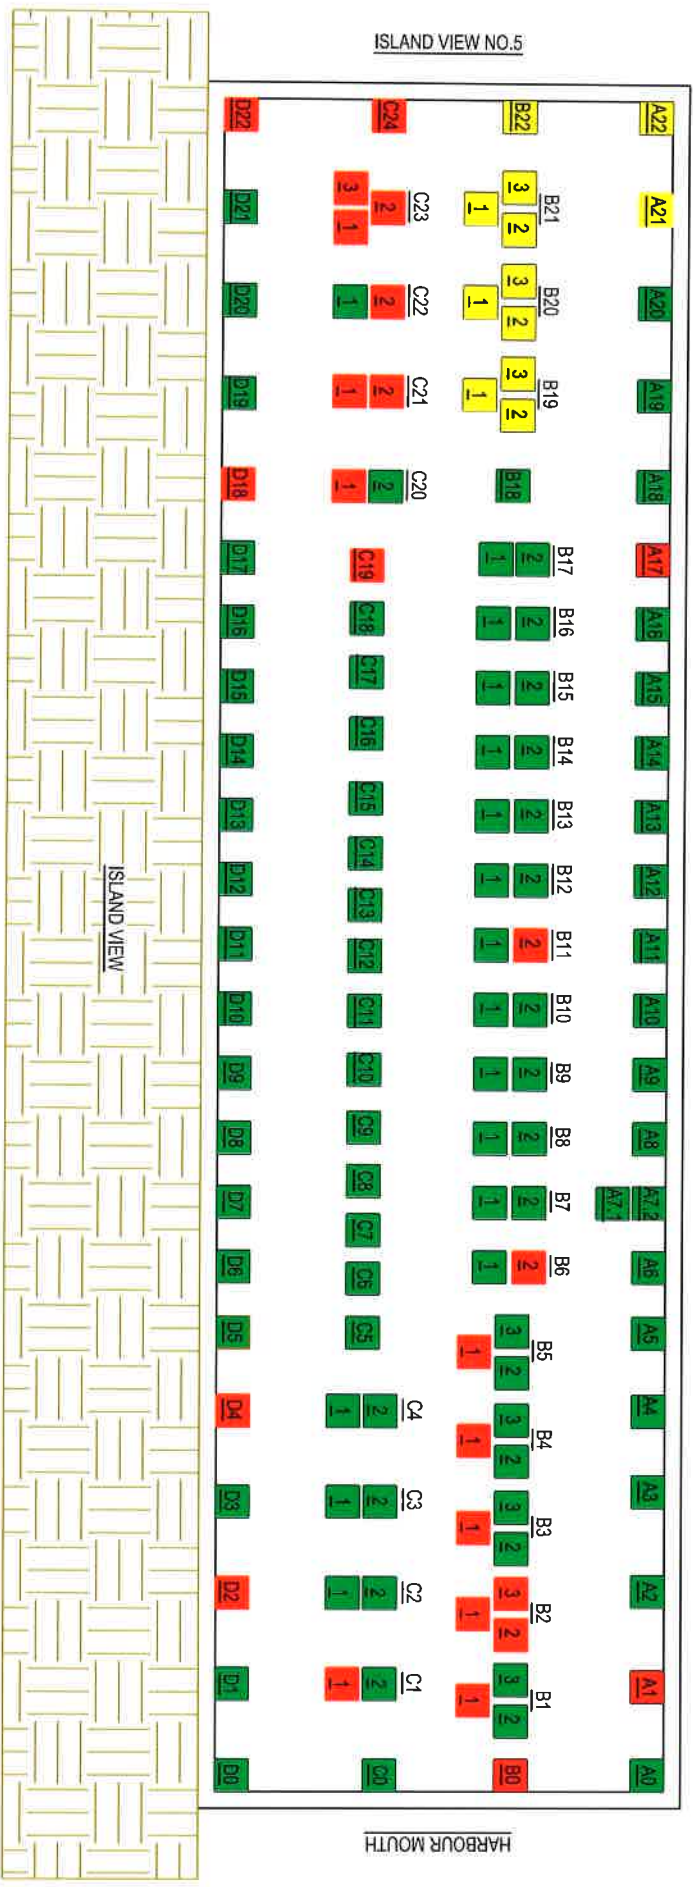

1

= INCOMPLETED

1

= COMPLETED

1

= ANOMALY NOTED

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SUBTECH

GROUP

Client Name:
KATLANTIC

Drawn: CJM

Date: 2018/08/17

Scale:
NTS

Vessel Name:
ISLAND VIEW 4

Description:
QUAY SIDE INSPECTION
ANOMALIES NOT NOTED

Report Number:
SSD18 001B-032- (001)

Sheet 1 of 1

NTS

A4

Client Name:
KATLANTIC

Drawn: CJM

Date: 2018/08/17

Scale:
NTS

Vessel Name:
ISLAND VIEW 4

Description:
QUAY SIDE INSPECTION
ANOMALIES NOT NOTED


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NTS


A4

ISLAND VIEW 4
QUAY SIDE INSPECTION
FACING WEST SIDE
PILE B1.1



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	= AREA OF ANOMALY		
	= WATER LEVEL		
Client Name:	KATLAN TIC	Drawn: CJM	Date: 2018/08/17
Scale:	NTS	A4	Sheet 1 of 1
Vessel Name:	ISLAND VIEW 4	Description:	QUAY SIDE INSPECTION PILE NO. B1.1
Report Number:	SSD18 001B-032- (000)		

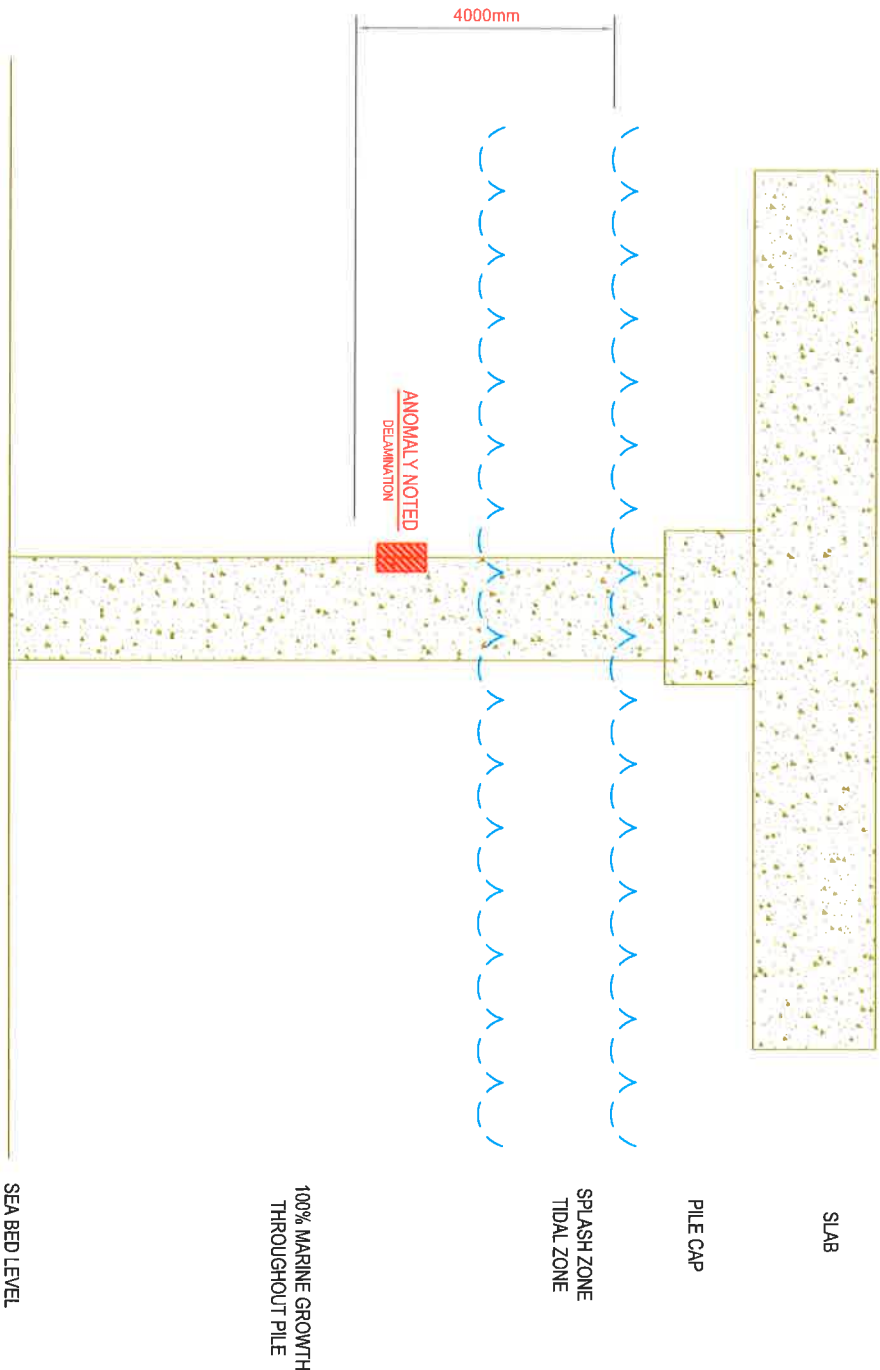ISLAND VIEW 4
QUAY SIDE INSPECTION
FACING NORTH SIDE
PILE B1.1

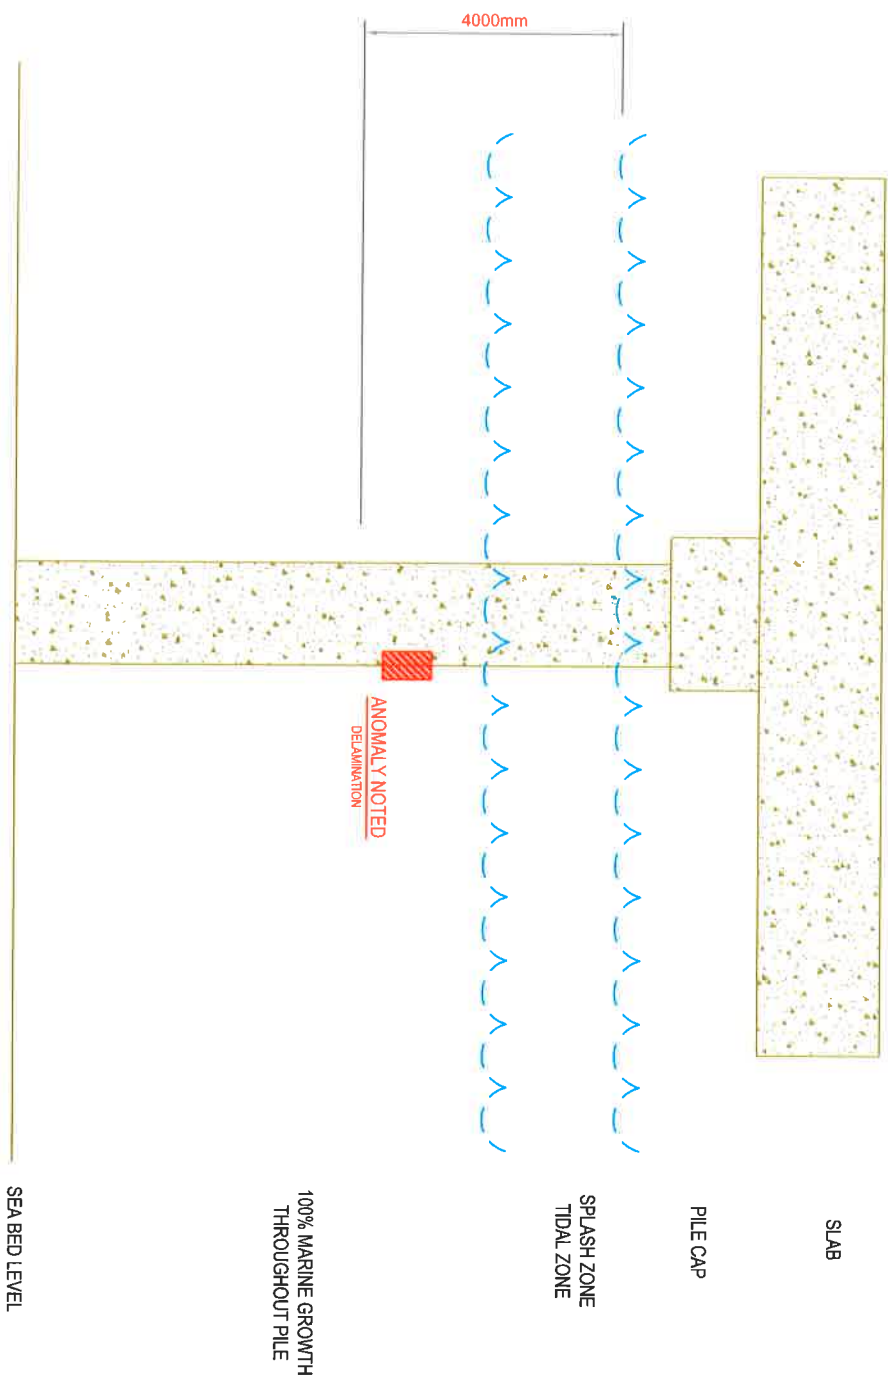

100% MARINE GROWTH
THROUGHOUT PILE

SEA BED LEVEL

Key:

 = AREA OF ANOMALY

 = WATER LEVEL

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Client Name:

KATLANTIC

Drawn: CJM

Date: 2018/08/17

Scale:

NTS

A4

Sheet 1 of 1

Vessel Name:

Item Name:


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PILE NO. B1.1

Report Number:


ISLAND VIEW 4
QUAY SIDE INSPECTION
PILE NO. B1.1
SSD18 001B-032- (000)
SIGNED

ISLAND VIEW 4
QUAY SIDE INSPECTION
PILE B0.1

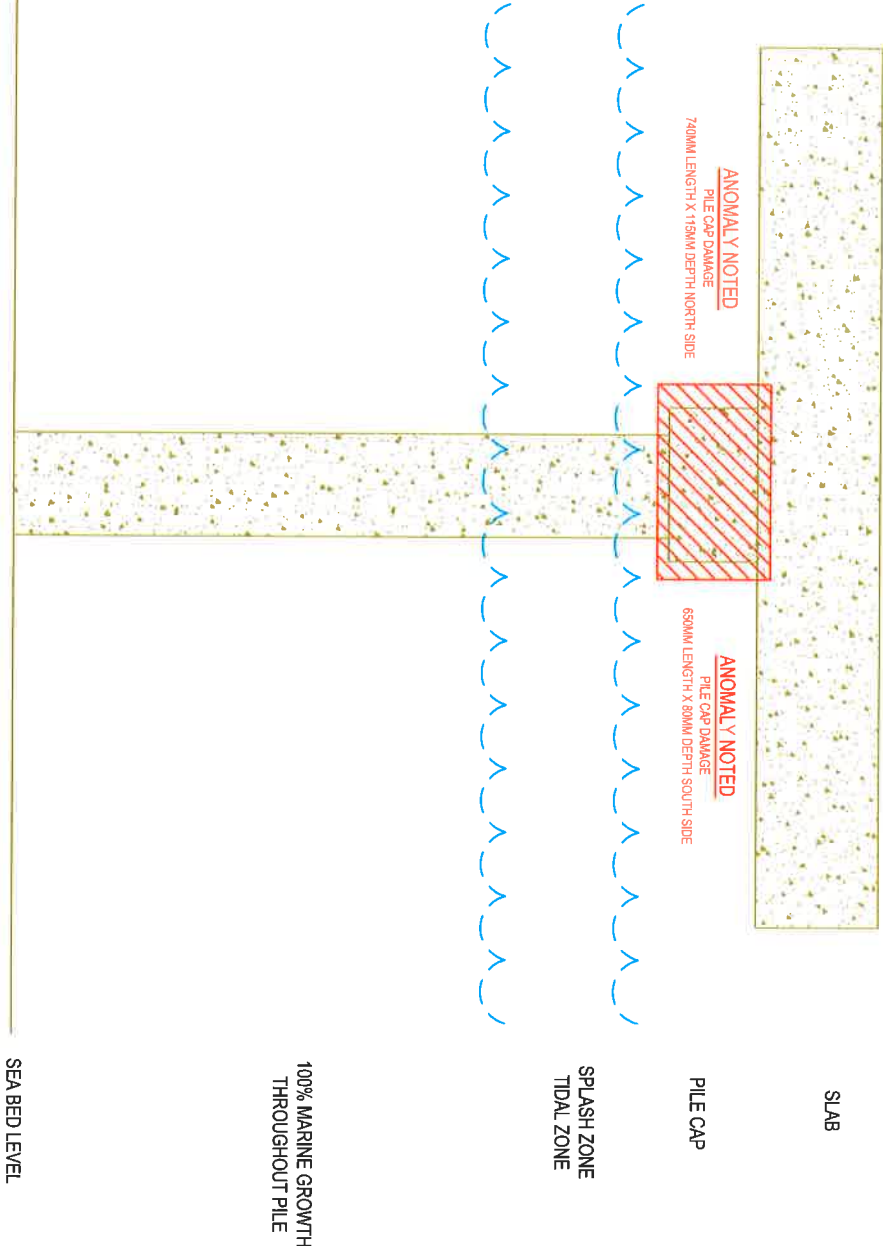


<div>Key:</div> <div> = AREA OF ANOMALY</div> <div> = WATER LEVEL</div>		<p>THIS DRAWING IS THE PROPERTY OF SUBTECH AND IS PRODUCED FOR THE INTENDED CLIENT. INTELLECTUAL PROPERTY RIGHTS VEST IN SUBTECH AND NOTHING HEREIN MAY BE REPRODUCED, USED OR DISCLOSED IN WHOLE OR IN PART WITHOUT PRIOR PERMISSION FROM THE COMPANY.</p>	
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Client Name:		Vessel Name:	
KATLANTIC		ISLAND VIEW 4	
Drawn: CIM		Description:	
Date: 2018/08/17		QUAY SIDE INSPECTION	
Scale:		PILE NO. B0.1	
NTS		Report Number:	
A4		SSD18 001B-032- (000)	
		Revision	
Sheet 1 of 1			

ISLAND VIEW 4
QUAY SIDE INSPECTION
PILE A17

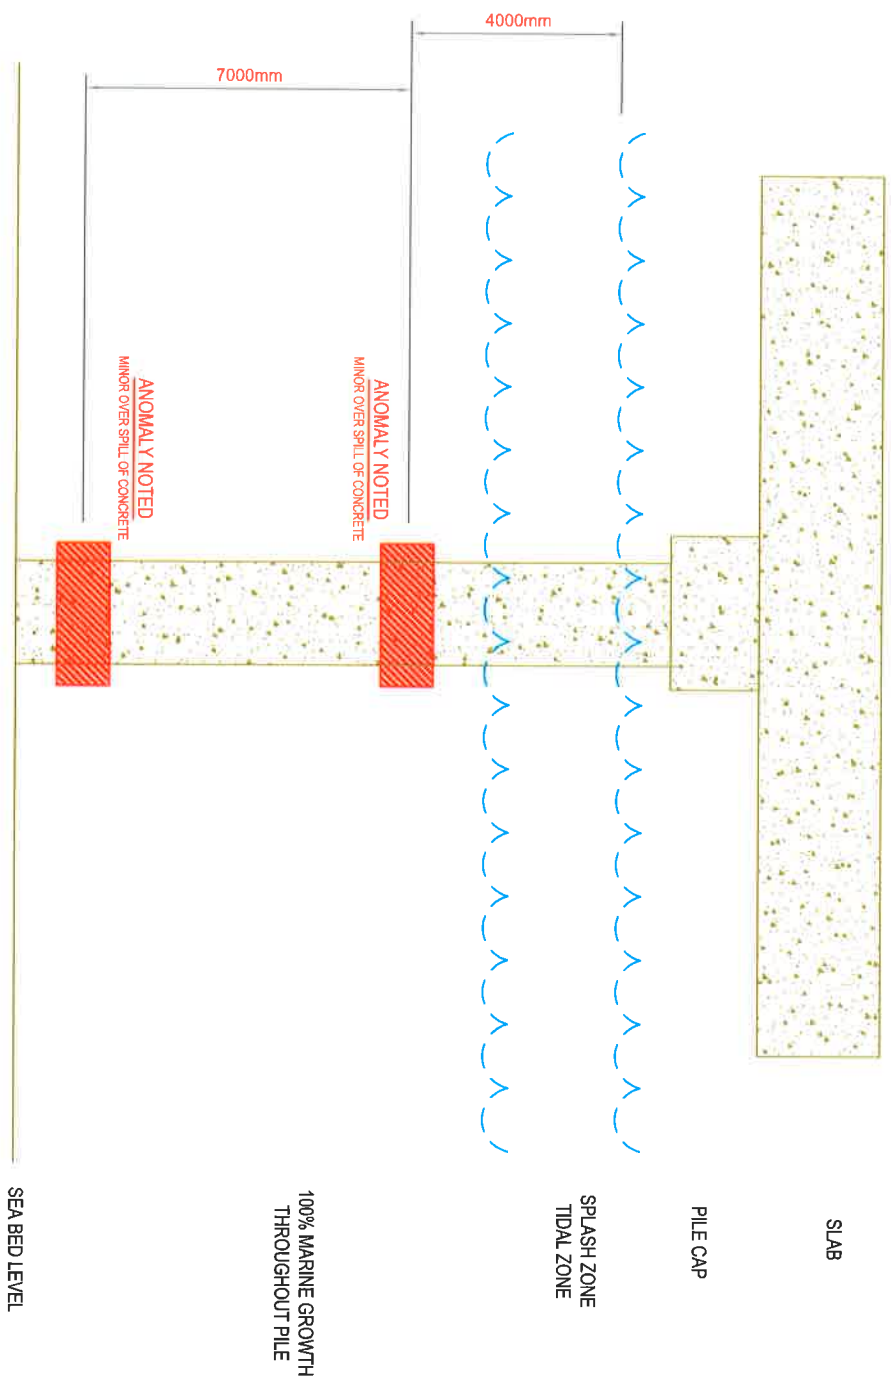

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Drawn: CJM		Date: 2018/08/17		Description: QUAY SIDE INSPECTION PILE NO. A17		Scale: NTS		Report Number: SSD18 001B-032- (000)	
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where experience meets innovation

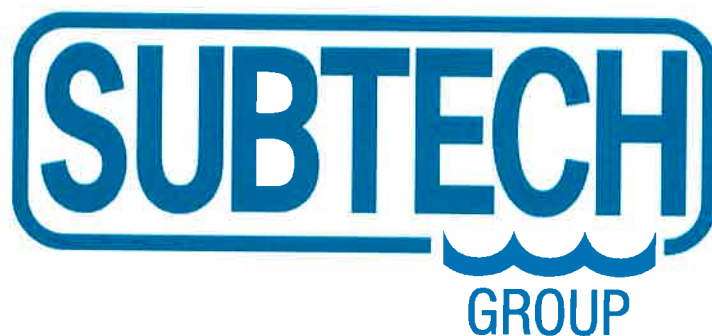